American River Basin

Attachment 3: Work Plan

Supporting Documents

Att3_IG1_ARB_Workplan_6of10 includes the following:

Proj No	' Project Name	Supporting Documentation Included	Notes
8	Sacramento Regional County Sanitation District / Sacramento Power Authority Recycled Water Project	SRCSD/SPA Recycled Water Project Feasibility Study	The Feasibility Study for the project also includes the conceptual design drawings for the project.

SRCSD/SPA Recycled Water Project Feasibility Study (Part 2 of 3)

Attachment F

Water Reclamation Facility Phase II Expansion Project – 100% Design Drawings (Jan. 2010)



Sacramento Regional
County Sanitation District
Sacramento County, California

Contract Documents for the Construction of

Sacramento Regional Wastewater Treatment Plant

WATER RECLAMATION FACILITY EXPANSION PROJECT - PHASE II



Black & Veatch Corporation
Walnut Creek, California

Terada Engineering, Inc.

1570 The Alameda Suite 221 San Jose, California 95126 (408) 294-1445 VOLUME 2 OF 2 DRAWINGS

JANUARY 2010

100% SUBMITTAL





CONTRACT NUMBER [XXXX]

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GENERAL
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CONTROL AND LOGIC DIAGRAM - P44992 WF FILTER FEED PUMP 1 - SHEET 2 OF 2
CONTROL AND LOGIC DIAGRAM - P44992 VFC449928 WF FILTER FEED PUMP 2 - SHEET 2 OF 2
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CONTROL AND LOGIC DIAGRAM - P44993 WF FILTER FEED PUMP 3 - SHEET 1 OF 2
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INTERCONNECT DIAGRAM P44992 WF FILTER FEED PUMP 3
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CY108
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CONTROL AND LOGIC DIAGRAM CIP ACID & CAUSTIC CIRCULATION PUMPS
CONTROL AND LOGIC DIAGRAM CIP ACID & CAUSTIC CIRCULATION PUMPS
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P&ID - CIP NEUTRALIZATION TANK
P&ID - CIP CHEMICAL NEUTRALIZATION PUMP
P&ID - CIP ACID TANK
P&ID - CIP ACID SOLUTION FEED SYSTEM
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                         DWG NO.
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                                                                                                                                                                                                                                                                                                                  FY306
                                                                                                                                                                                                                                                                                                                                           EXISTING HANDHOLE 453 AND DUCT BANK SECTIONS
                                                                                                                                                                                                                                                                                                                                                                                                                                                                                                                                                                                                                                                                                                   CIVIL
                                                                                                                                                                                                                                                                                                                                                                                                                                                                                                                                                                                                                                                                                                                                                                                         100 PLAN/ENLARGED PLAN
                                                                                                                                                                                                                                                                                            157
158
                                                                                                                                                                                                                                                                                                                                            EXISTING HANDHOLE 454 AND DUCT BANK SECTIONS
                                                                                                                                                                                                                                                                                                                                                                                                                                                                                                                                                                                                                         GENERAL
                                                   CHEMICAL STORAGE FACILITY - CHEMICAL VENT LINE DEMO
                                                                                                                                                                                                                                                                                                                                                                                                                                                                                                                                                                                                                                                                                                   FILTER FEED PUMP STATION
                                                                                                                                                                                                                                                                                                                                                                                                                                                                                                                                                                                                                                                                                                                                                                                          200 ELEVATIONS/PROFILES
                                                                                                                                                                                                                                                                                                                                                                                                                                                                                                                                                                                                                         CIVIL
                                                                                                                                                                                                                                                                                                                  EY308
                                                                                                                                                                                                                                                                                                                                           EXISTING HANDHOLE 455 & 456 AND DUCT BANK SECTIONS
                                                                                                                                                                                                                                                                                                                                                                                                                                                                                                                                                                                                                                                                                                  MEMBRANE FILTRATION FACILITY
BACKWASH WASTE PUMPS
                                                                                                                                                                                                                                                                                                                                                                                                                                                                                                                                                                                                                          STRUCTURA
                                                                                                                                                                                                                                                                                            159
                                                                                                                                                                                                                                                                                                                  FY309
                                                                                                                                                                                                                                                                                                                                           EXISTING HANDHOLE 457 & 458 AND DUCT BANK SECTIONS
                                                                                                                                                                                                                                                                                                                                           EXISTING HANDHOLE 459, 460 & 461 AND DUCT BANK SECTIONS
MANHOLE 1002 AND HANDHOLE 100005 AND DUCT BANK SECTIONS
                                                                                                                                                                                                                                                                                                                                                                                                                                                                                                                                                                                                                         MECHANICAL
                                                                                                                                                                                                                                                                                                                                                                                                                                                                                                                                                                                                                                                                                                                                                                                         500 DETAILS
                                                                                                                                                                                                                                                                                                                                                                                                                                                                                                                                                                                                                                                                                                   CIP-NEUTRALIZATION SYSTEM
                                                                                                                                                                                                                                                                                                                                                                                                                                                                                                                                                                                                                         PLUMBING
                                                                                                                                                                                                                                                                                                                                                                                                                                                                                                                                                                                                                                                                                                                                                                                         600 FLECTRICAL ONE-LINES
                                                                                                                                                                                                                                                                                                                                                                                                                                                                                                                                                                                                                                                                                                  CHEMICAL STORAGE AREA
MCC BUILDING
                                                                                                                                                                                                                                                                                                                                                                                                                                                                                                                                                                                                                                                                                                                                                                                         700 ELECTRICAL SCHEMATICS
800 ELECTRICAL SCHEDULES
                                                                                                                                                                                                                                                                                                                                                                                                                                                                                                                                                                                                                         ELECTRICAL
                                                                                                                                                                                                                                                                         INSTRUMENTATION
                                                                                                                                                                                                                                                                                                                                                                                                                                                                                                                                                                                                                        INSTRUMENTATION
                                                                                                                                                                                                                                                                                                                                                                                                                                                                                                                                                                                                                                                                                                                                                                                         900 PROCESS AND INSTRUMENTATION
                                                                                                                                                                                                                                                                                                                DWG NO.
                                                                                                                                                                                                                                                                                                                                          P&ID - LEGEND AND ABBREVIATIONS 1 OF 3
P&ID - LEGEND AND ABBREVIATIONS 2 OF 3
P&ID - LEGEND AND ABBREVIATIONS 3 OF 3
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BLACK & VEATCH
Building a World of difference



		REVISIONS				. LINE IS 2 INCHES .
ZONE	REV.	DESCRIPTION	BY	DATE	APP.	AT FULL SIZE
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SACRAMENTO REGIONAL COUNTY
SANITATION DISTRICT
OF SACRAMENTO COUNTY, CALIFORNIA

SACRAMENTO REGIONAL WASTEWATER TREATMENT PLANT WATER RECLAMATION FACILITY

CONTRACT NUMBER


DRAWING INDEX


NO SCALE

DRAWING NUMBER

GG001
SHEET NUMBER

EXPANS 1 OF 236

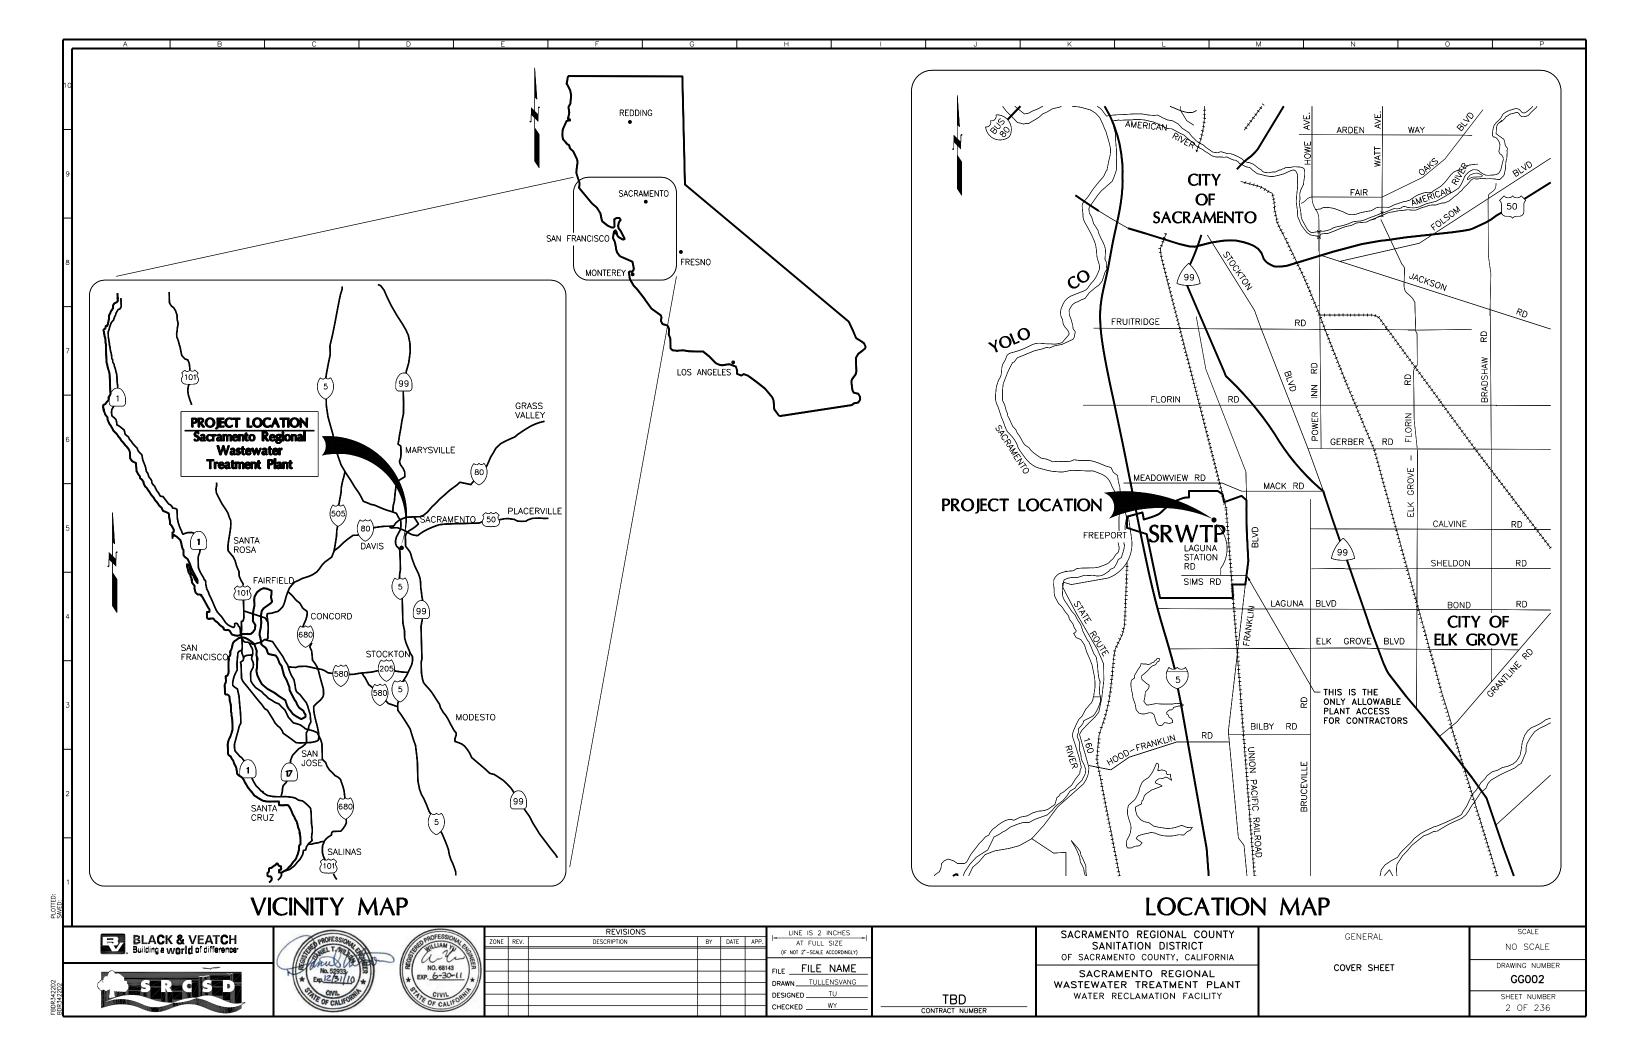

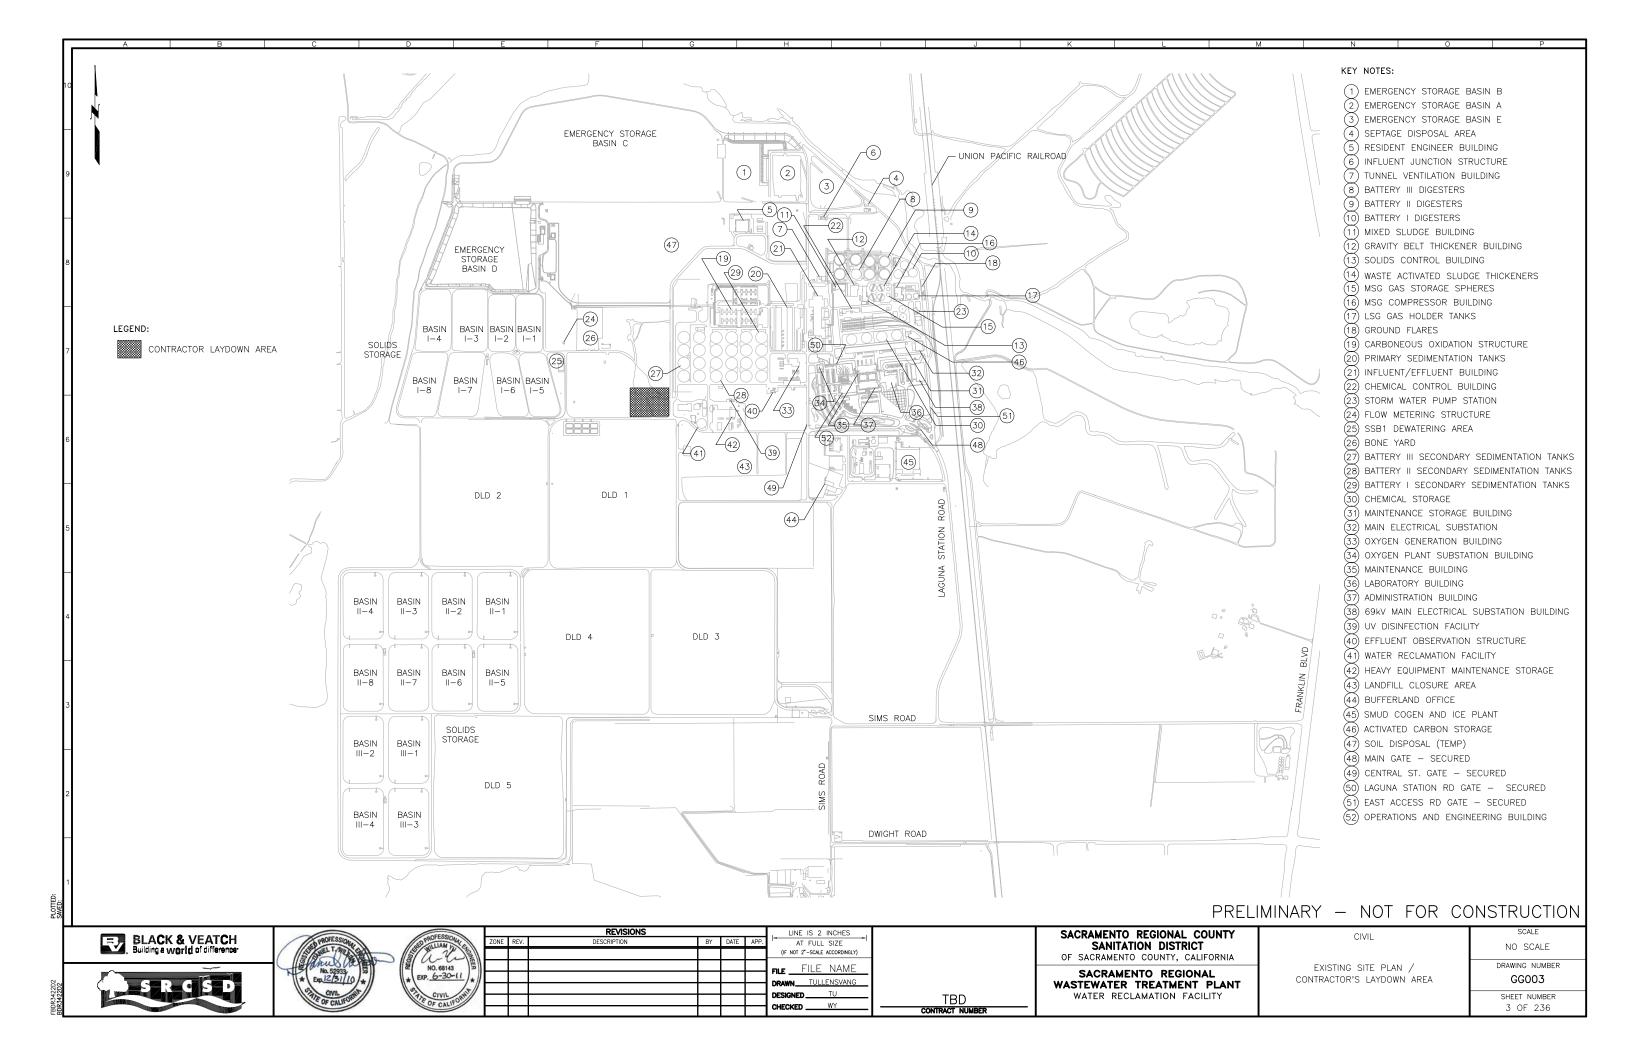

```
DESIGN DATA
DESIGN FLOW
                                                                               NEUTRALIZATION PUMP
NET RECLAIMED WATER PRODUCTION
                                                                                                                       VERTICAL CENTRIFUGAL,
                                        10
               CAPACITY, MGD
                                                                                                                       CONSTANT SPEED
                                                                                    NUMBER OF UNITS
REVERSE FILTRATION WATER
                                                                                    RATED CAPACITY, EACH gpm
                                        1.1
               CAPACITY, MGD
                                                                                   RATED HEAD. ft
                                                                                                                       70
7 1/2
                                                                                    MOTOR HORSEPOWER. EACH
TOTAL PLANT FLOW AT
RATED CAPACITY, MGD
                                                                               SODIUM HYDROXIDE TRANSFER PUMP
                                                                                                                      CENTRIFUGAL,
CONSTANT SPEED-1200 RPM
SECONDARY EFFLUENT QUALITY
BOD, mg/L
                                                                                    NUMBER OF UNITS
                                                                                   RATED CAPACITY, EACH gpm
RATED HEAD, ft
MOTOR HORSEPOWER, EACH
\it TOTAL SUSPENDED SOLIDS, \it mg/L
                                        3-13
TURBIDITY, NTU
                                        2.2-11.7
                                                                                SODIUM HYPOCHLORITE PUMP
FILTER FEED PUMP STATION
                                                                                                                       CENTRIFUGAL
                                                                                   TYPE
FILTER FEED PUMPS
                                                                                                                       CONSTANT SPEED-1200 RPM
                                                                                    NUMBER OF UNITS
                                        VERTICAL TURBINE,
                                                                                    RATED CAPACITY, EACH gpm
                                                                                   RATED HEAD, ft
MOTOR HORSEPOWER, EACH
                                        VARIABLE SPEED
     NUMBER OF UNITS
RATED CAPACITY, EACH gpm
RATED HEAD, ft
                                        3420
175
200
                                                                               SODIUM BISULFITE PUMP
     MOTOR HORSEPOWER, EACH
                                                                                                                       CENTRIFUGAL,
                                                                                                                       CONSTANT SPEED-1200 RPM
                                        VERTICAL TURBINE.
     TYPE
                                                                                   NUMBER OF UNITS
RATED CAPACITY, EACH gpm
                                        VARIABLE SPEED
     NUMBER OF UNITS
                                                                                   RATED HEAD. ft
     RATED CAPACITY, EACH gpm
RATED HEAD, ft
MOTOR HORSEPOWER, EACH
                                                                                    MOTOR HORSEPOWER, EACH
                                        175
60
                                                                                CITRIC ACID PUMP
                                                                                                                       CENTRIFUGAL,
AUTOMATIC STRAINERS
                                                                                                                       CONSTANT SPEED-1200 RPM
                                        INLINE
                                                                                    NUMBER OF UNITS
                                        AUTO-BACKWASHING
                                                                                    RATED CAPACITY, EACH gpm
     NUMBER OF UNITS
                                                                                    RATED HEAD, ft
     RATED CAPACITY, gpm
                                                                                    MOTOR HORSEPOWER. EACH
                                        1 1/2
     POWER, hp
                                                                                SODIUM HYPOCHLORITE-DISINFECTANT PUMP
MEMBRANE SYSTEM
                                                                                    TYPE DIAPHRAGM
MEMBRANE UNITS
                                        PALL MICROZA, UNA-620A
                                                                                    NUMBER OF UNITS
     NUMBER OF UNITS
                                                                                   RATED HEAD
RATED CAPACITY, EACH gpm
                                        5 (5 DUTY)
                                                                                                                       55 ft
     NUMBER OF MODULES
ON EACH UNITS
                                                                                                                       0.6 gpm
1/2 hp
                                                                                    MOTOR HORSEPOWER, EACH
     RATED CAPACITY, apm
                                        7000
                                                                                SODIUM BISULFITE-DECHLORINIZATION PUMP
      MAX INSTANT. FLUX, gfd
AIR COMPRESSOR SYSTEM
COMPRESSOR
                                                                                    NUMBER OF UNITS
                                        SINGLE STAGE W/ INTERNAL DRYER
                                                                                    RATED HEAD
                                                                                                                       55 ft
    NUMBER OF UNITS
RATED CAPACITY, cfm
                                                                                   RATED CAPACITY, EACH gpm
MOTOR HORSEPOWER, EACH
                                                                                                                      1 gpm
1/2 hp
                                        15g
                                                                                ALUM PRETREATMENT PUMP
RECEIVER
                                        VERTICAL, CYLINDRICAL
     NUMBER OF UNITS
                                                                                   NUMBER OF UNITS
RATED HEAD
RATED CAPACITY, EACH gpm
     RATED CAPACITY, GAL
                                        1040g
                                                                                                                       55 ft
REVERSE FILTRATION PUMPS
                                                                                    MOTOR HORSEPOWER, EACH
                                        VERTICAL TURBINE,
                                        VARIABLE SPEED
                                        2 (1 DUTY 1 STANDBY)
912
     NUMBER OF NEW UNITS
     RATED CAPACITY, EACH gpm
RATED HEAD, ft
     MOTOR HORSEPOWER, EACH
MUD WELL PUMPS
                                        SELF-PRIMING CENTRIFUGAL,
                                        CONSTANT SPEED
2 (1 DUTY 1 STANDBY)
     NUMBER OF NEW UNITS
    RATED CAPACITY, EACH gpm
RATED HEAD, ft
MOTOR HORSEPOWER, EACH
CIP/NEUTRALIZATION SYSTEM
CIP CIRCULATION PUMPS
                                        VERTICAL CENTRIFUGAL,
                                        CONSTANT SPEED
     NUMBER OF UNITS
RATED CAPACITY, EACH gpm
                                         3 (2 DUTY 1 BOXED SPARE)
     RATED HEAD. ft
CIP DRAIN PUMP
                                        VERTICAL CENTRIFUGAL,
CONSTANT SPEED
2 (1 DUTY 1 BOXED SPARE)
```

* RF PUMPS AND PIPELINE WILL BE REDESIGNED BASED ON LATEST INFORMATION FROM PALL.

70 7 1/2

PRELIMINARY - NOT FOR CONSTRUCTION



NUMBER OF NEW UNITS RATED CAPACITY, EACH gpm RATED HEAD, ft

MOTOR HORSEPOWER, EACH





			RE VISIONS				, LINE IS
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		Α	50% SUBMITTAL		09/09		(IF NOT 2"-SC/
۱		В	90% SUBMITTAL		11/09		FILE
П		С	100% SUBMITTAL		01/10		DRAWN
							DESIGNED
							CHECKED
							CHECKED

CONTRACT NUMBER

SACRAMENTO REGIONAL COUNTY
SANITATION DISTRICT
OF SACRAMENTO COUNTY, CALIFORNIA
SACRAMENTO REGIONAL

WATER RECLAMATION FACILITY

EXPANSION PROJECT - PHASE II

SACRAMENTO REGIONAL
WASTEWATER TREATMENT PLANT

DESIGN DATA

GENERAL

NONE

DRAWING NUMBER

GG004

SHEET NUMBER
4 OF 236

A B C	D E	F G H	I J K	L M	N O	P
AS ANCHOR BOLT SYMPHET SYMPHET AND A CACE SAPILST SYMPHET AND A CACE SAPILST SHEET PIPE ACST ACROSSITE CHEMP TIPE ACST ACROSSITE CHEMP TIPE ACROSSITE CHEMP TIPE ACROSSITE CHEMP TIPE ACROSSITE CHEMP ACROSSITE CHEMP TIPE ACROSSITE CHEMP TIPE ACROSSITE CHEMP TO CHEMP CHEM	D DOOR DOUBLE CURRENT DEADLE DOUBLE CURRENT DEG DEGREE DEMO DEMOLISH AND REMOVE DEPT DEPATHENT DET DETATH DET DETATH DETATH DET DETATH DET DEPATHENT DET DETATH DETATH DETATH DET DETATH	## HIGH, MOUR, MYDROGEN HA HIGH-PRESSURE AIR HOR HEAP PRESSURE AIR HOR HARRIESSED MECHANICAL JOINT HOR HARMESSED MECHANICAL JOINT HOR HOLLOW, HANDBAIL HARMESSED MECHANICAL JOINT HOR HARMESSED MECHANICAL JOINT HARMESSED MECH	OC ON CENTER, COOR CONTROL OD OUTSIDE FACE, OVERFLOW OF OUTSIDE FACE, OVERFLOW OH OVERHEAD OL OVERLOAD OL OVERLOAD OPENING OPP OPPOSITE OSL OUTSTANDING LEG OZ OUNCE PC POINT OF CUNVE PC PC POINT OF CUNVE PC PC POINT OF COMPOUND CURVATURE PC PC POINT OF COMPOUND CURVATURE PC PC POINT OF COMPOUND CURVATURE PC PC POINT OF CUNVE PC PC POINT OF COMPOUND CURVATURE PC PC POINT OF INTERSECTION PT PC POINT OF INTERSECTION ON VERTICAL CURVE PC POINT OF INTERSECTION PR POINT OF INTERSECTION ON VERTICAL CURVE PC POINT OF POINT OF TANGENCY PC POINT OF POINT OF TANGENCY PC POINT POINT OF TANGENCY PC	T THERMOSTAT, TREAD TAN TANGENT THE TERMINAL BOX TAB TOP AND BOTTOM TBE THREAD BOTH COND TO C TERMINAL CABINET, TO TC TERMINAL CABINET, TO TC TERMINAL CABINET TELL TELESCOPING TEMP TERMINAL TAGG TONGUE & GROOVE TH TEST HOLE THE THRESTHOLE THREST HOLE THREST TRANSFORMER, TRANS TRANSFORMER, TRANS TRANSFORMER, TRANS TRANSFORMER, TRANS TEMPERATURE SWITC TY TYPICAL UND UNTERGROUND UNDERGROUND UN UNDERGROUND UN UNDERGROUND UN UNTERSOUNTE THE THE THREST TO THE THREST THREST TO THE UNO UNITED STATES GEO VALVE, VOLT, VENT VAC VALVE, NOTED OTHE UN UNITED STATES GEO VALVE, AWWA BUTTE VBI VALVE, SALL MISCE VC VERTICAL CONTROL VCK VALVE, CHECK VAL VE, CHECK VAL VE, CHECK VAL VE, GONE VCP VITTIFIED CLAY PI VG VAL VE, GONE VCP VITTIFIED CLAY PI VG VAL VE, PRESSURE R VG	RK P OF CURB OTOR, TEMPERATURE INDICATOR TING RECORDER ILE, TOWEL PIN ISMITTER, TRANSFER H Y METER RWISE LLOGICAL SURVEY LLE RELY BUTTERFLY LLANEOUS ICTAULIC COUPLING DAMPER PE CC GATE GEGULATING PLUG BELIEF ACCUM RELIEF IEF W, WATT, WATER WHATH METER ING POINT, WATER POTABLE ILITERED	P
SANEE: 17 SANEE: 17 104				חחרי יי	AINIADY NOT FOR	CONCIDUOTION
SAVE SAVE				PRELIN	MINARY - NOT FOR	CONSTRUCTION
BLACK & VEATCH Building a World of difference	ZONE REV.	RE VISIONS DESCRIPTION BY DATE APP. AT FULL SIZE 09/09 111/09 (F NOT 2"-SCALE ACCORDING 01/10 FILE	SANITA OF SACRAMEN	O REGIONAL COUNTY ATION DISTRICT ITO COUNTY, CALIFORNIA ENTO REGIONAL	GENERAL ABBRE VIATIONS	SCALE NONE DRAWING NUMBER GG005

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CHECKED __

CONTRACT NUMBER

GG005


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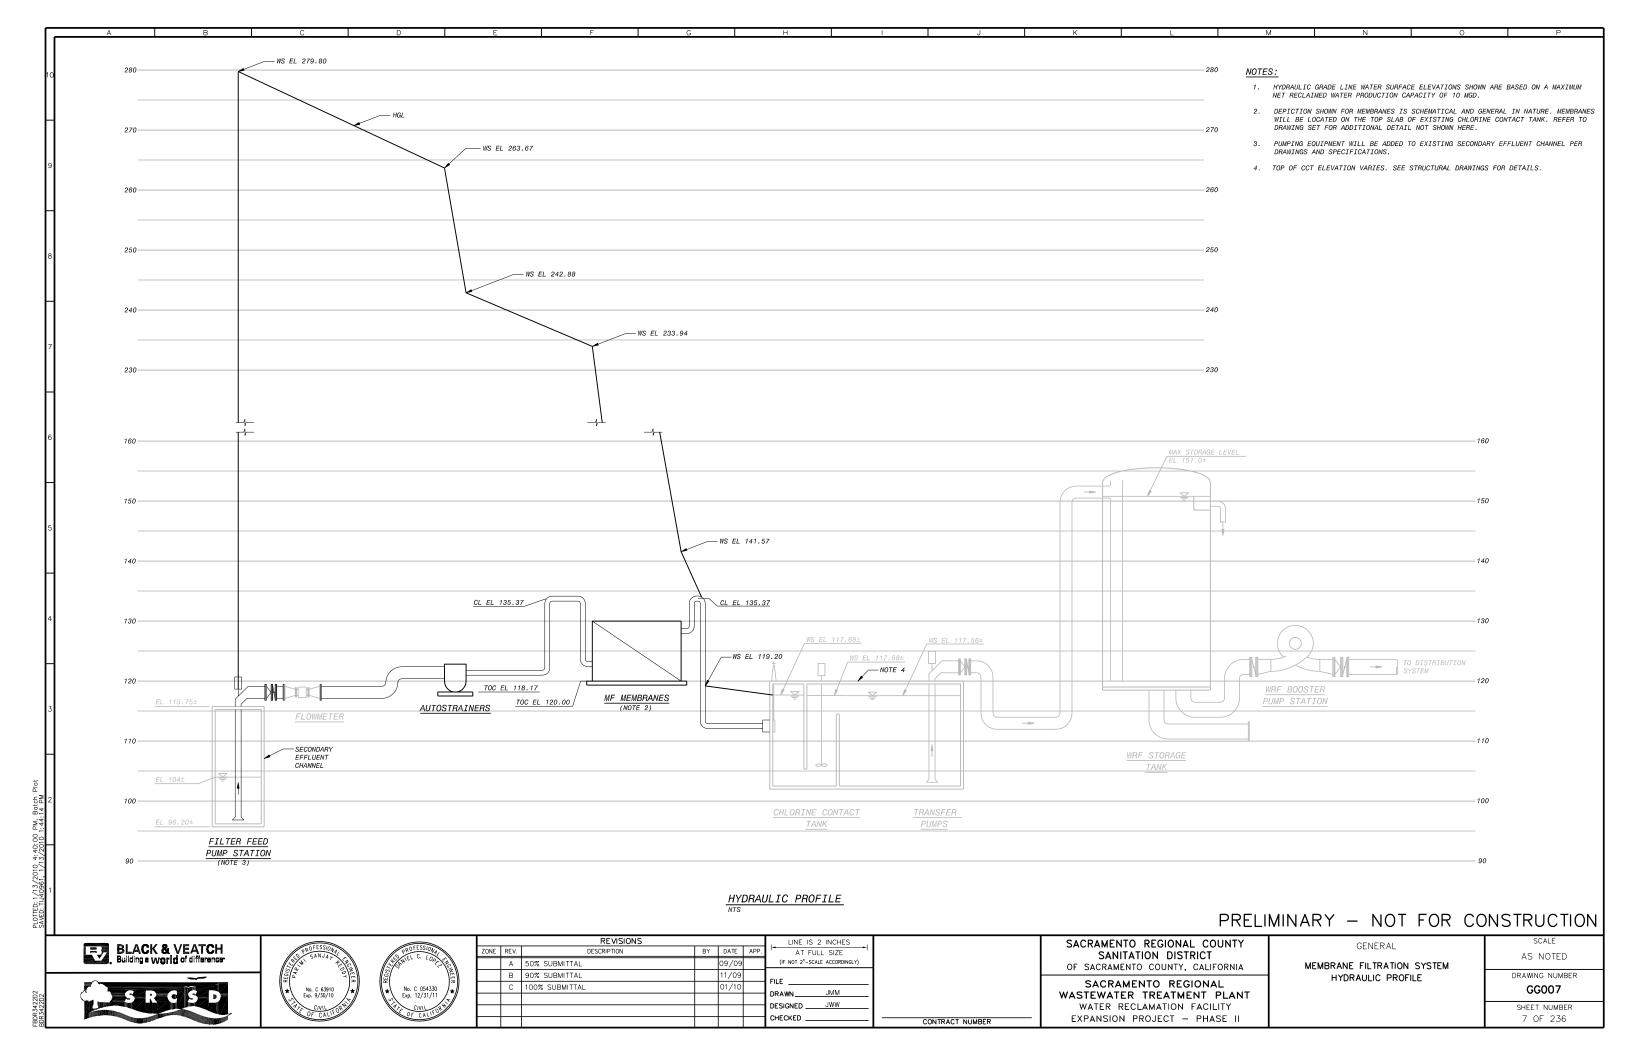
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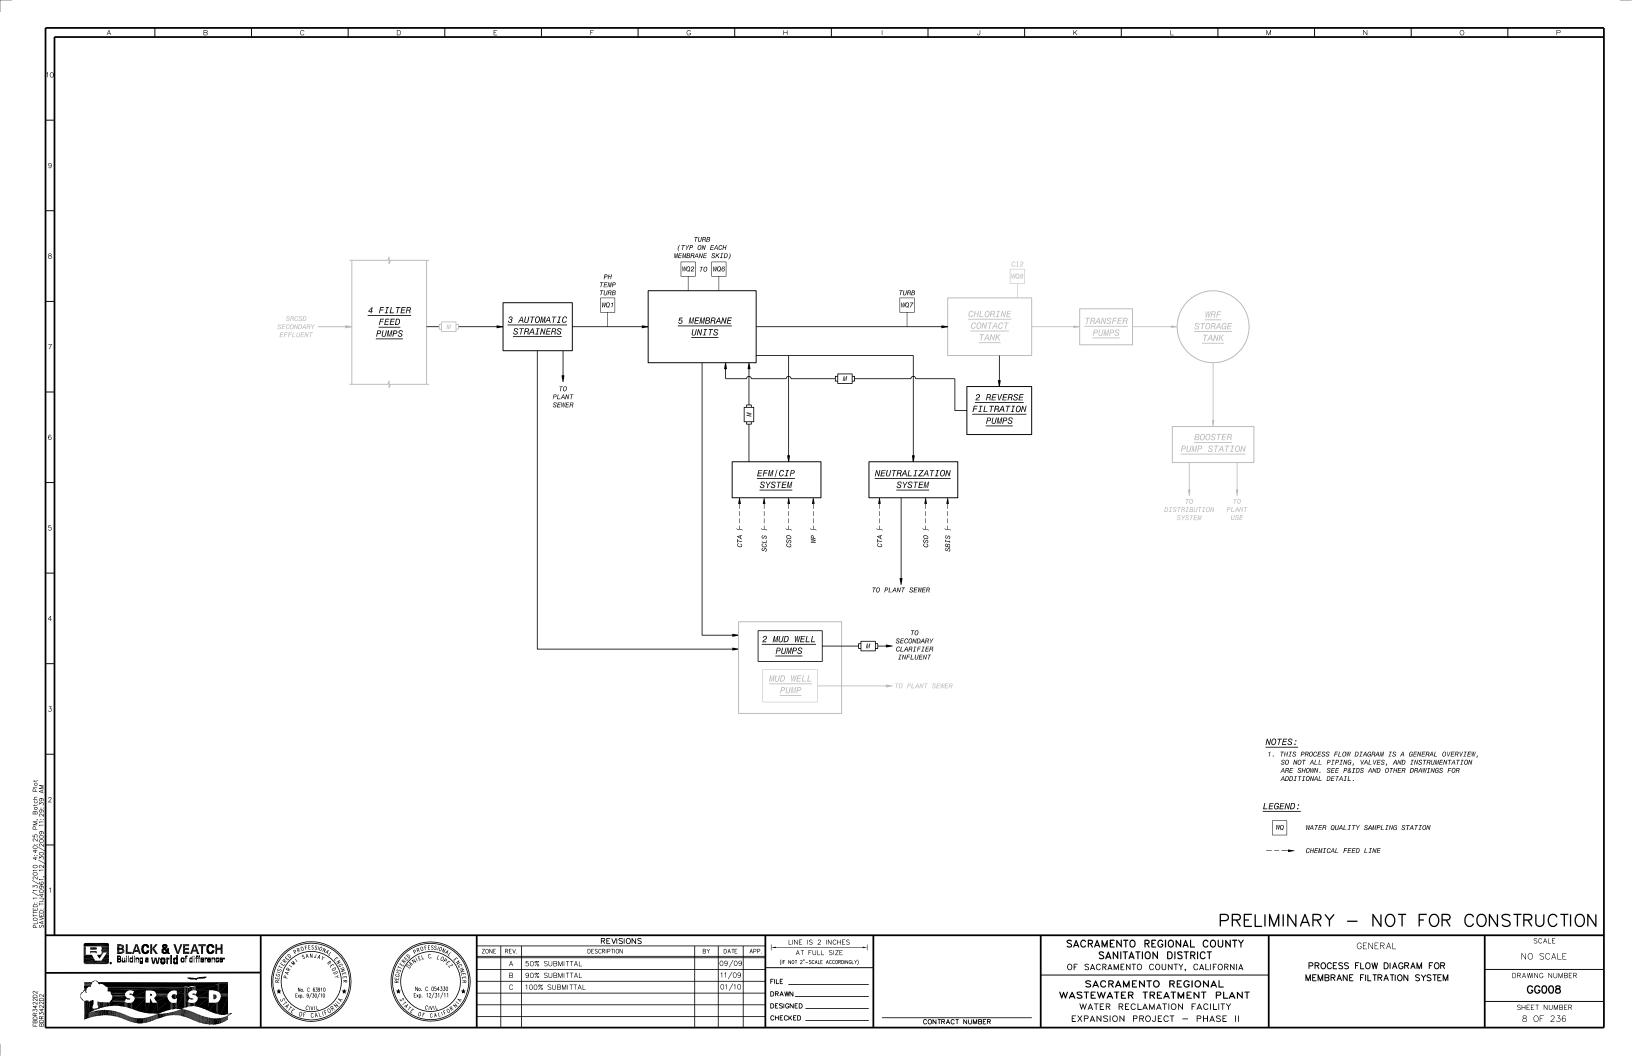
SACRAMENTO REGIONAL WASTEWATER TREATMENT PLANT


WATER RECLAMATION FACILITY


EXPANSION PROJECT - PHASE II







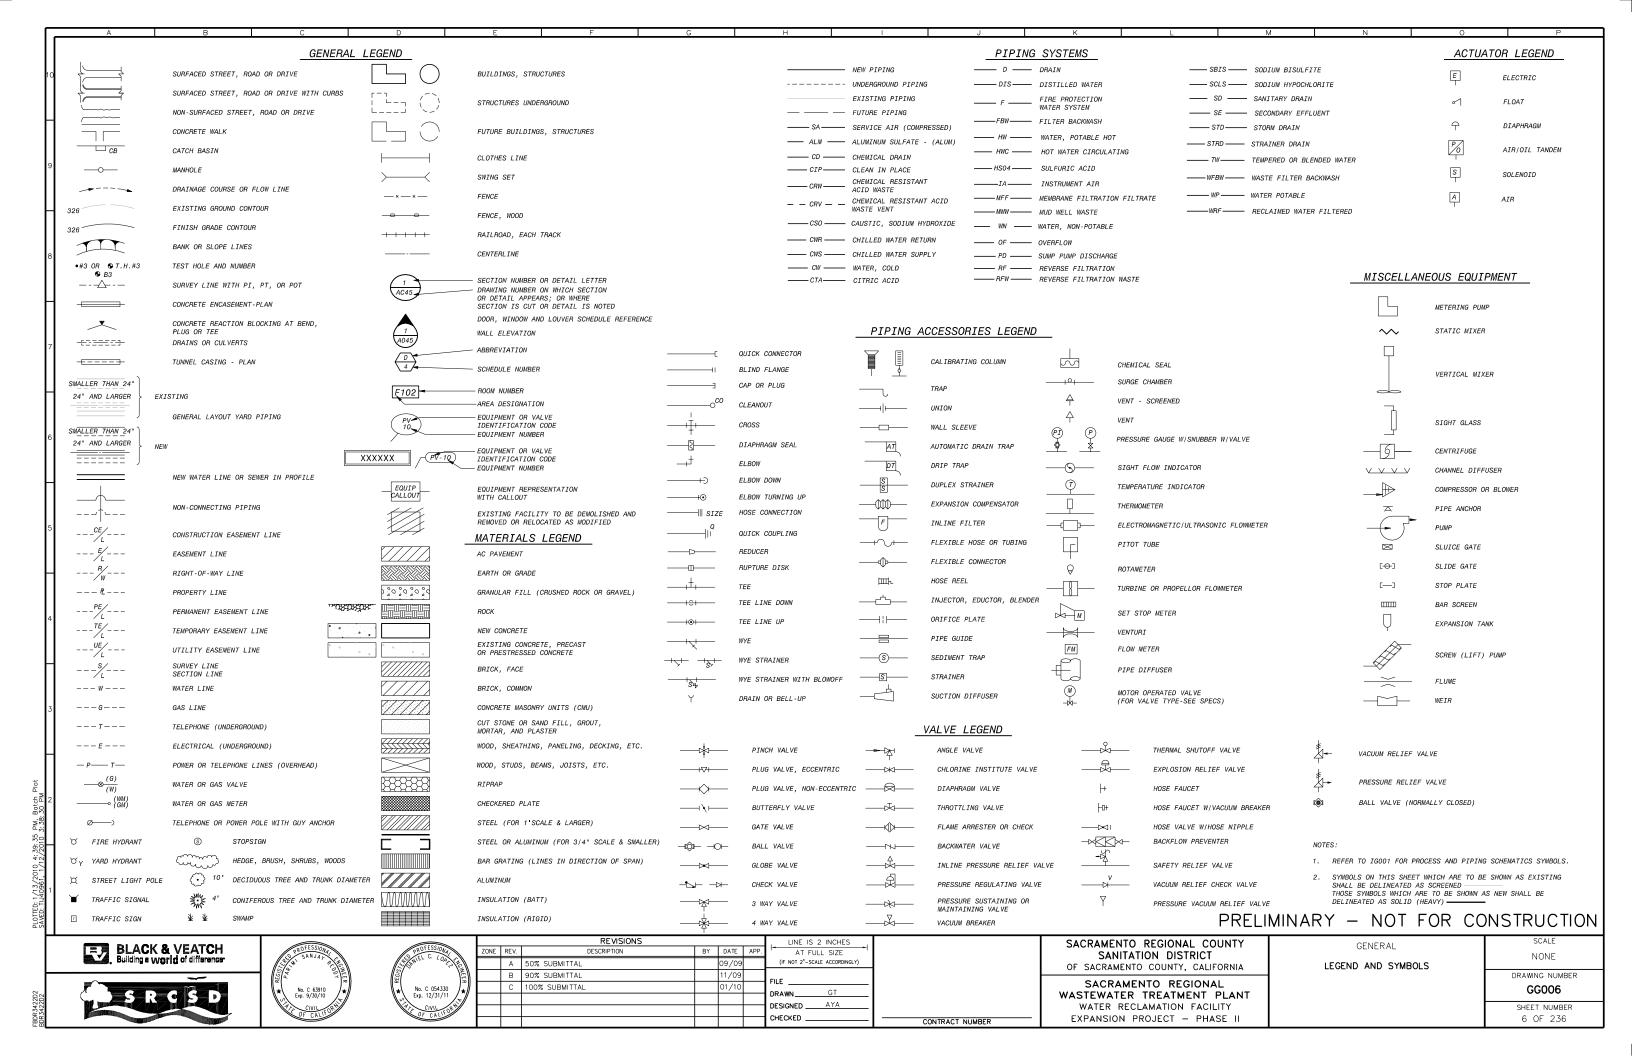


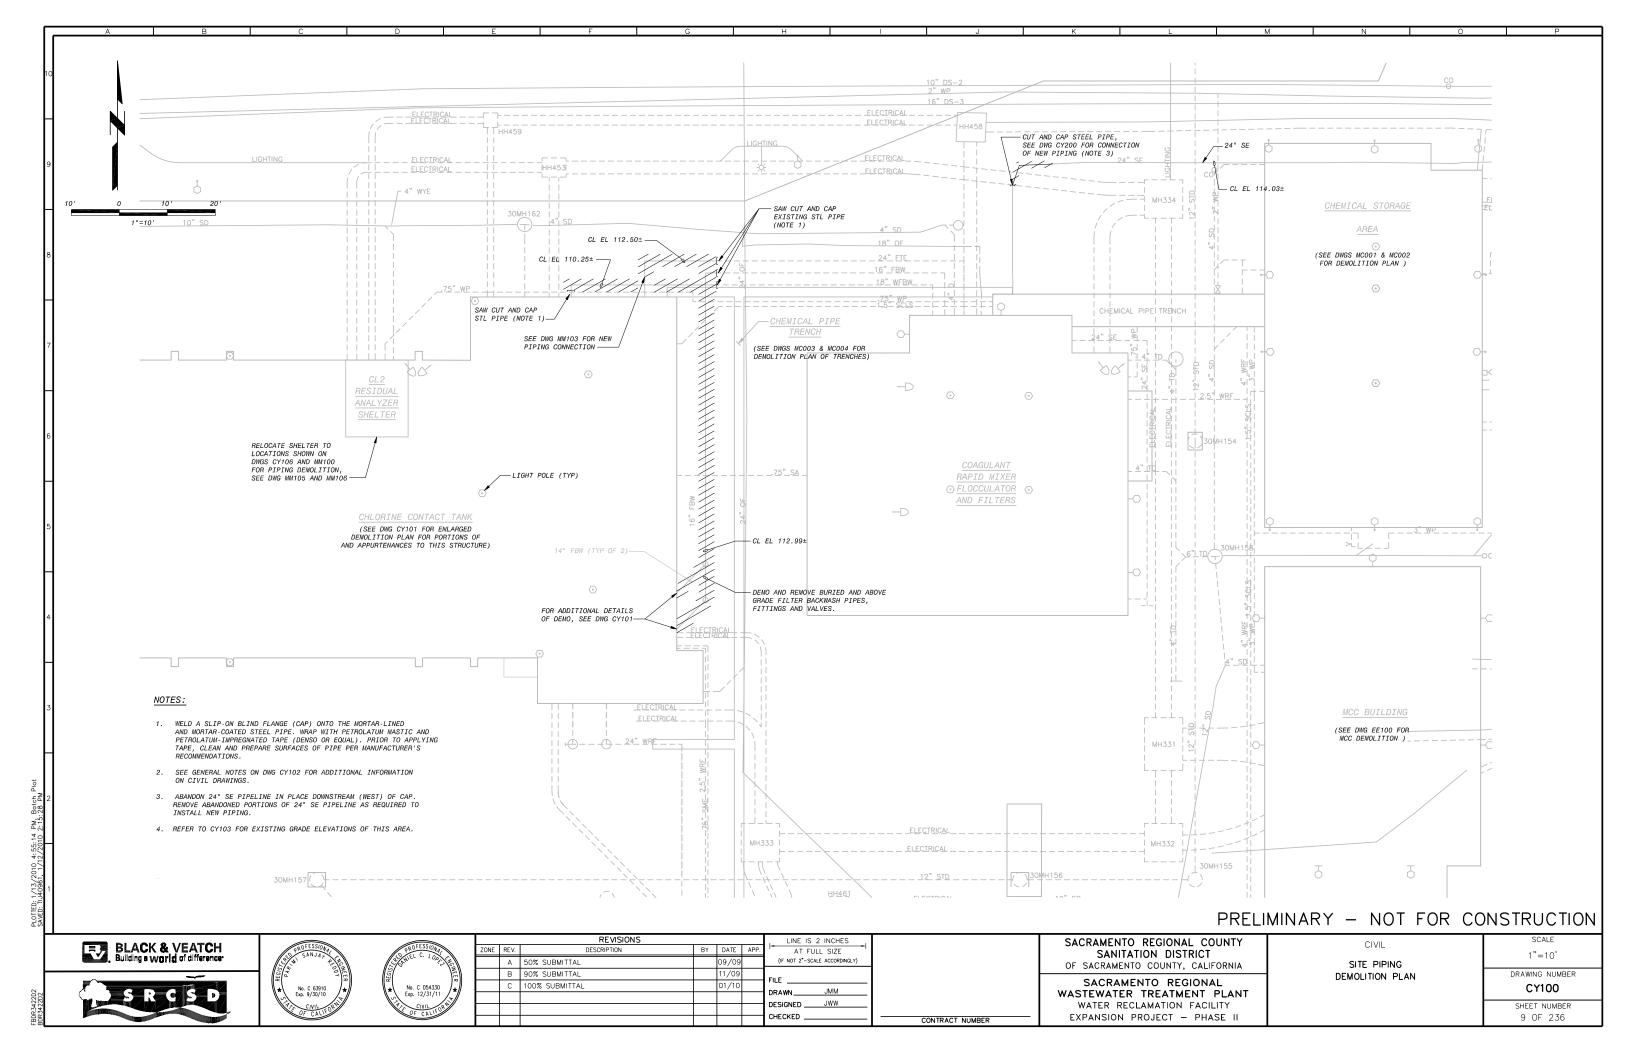


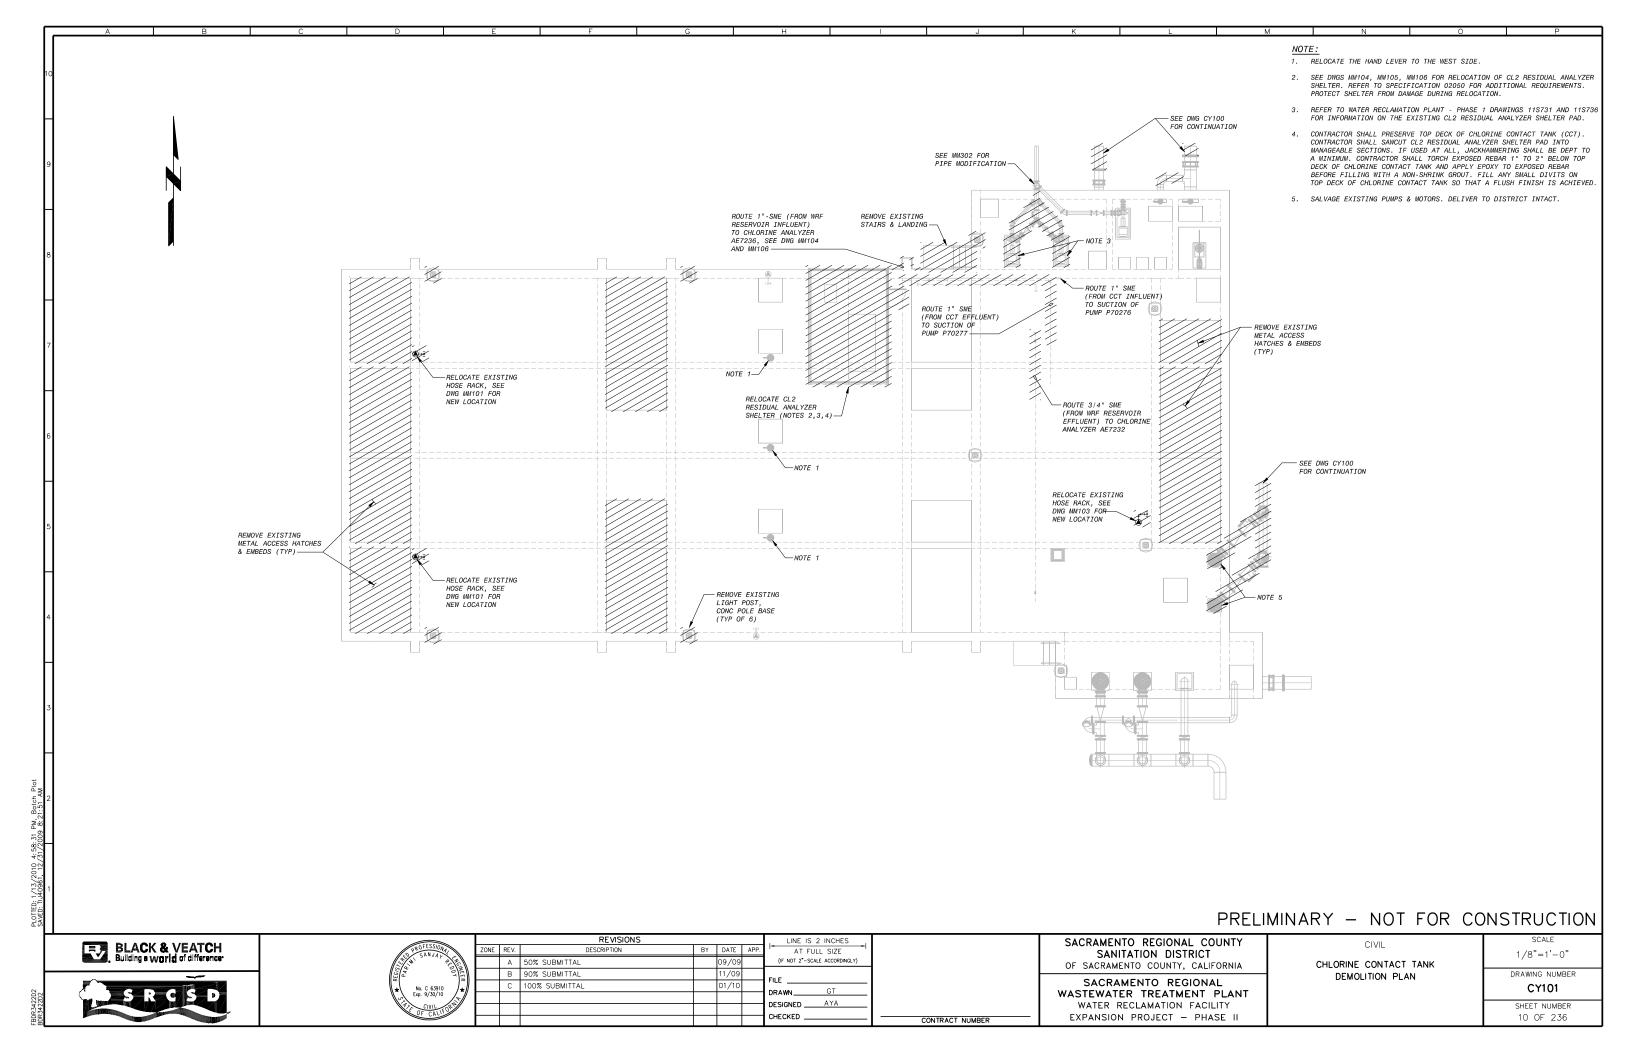


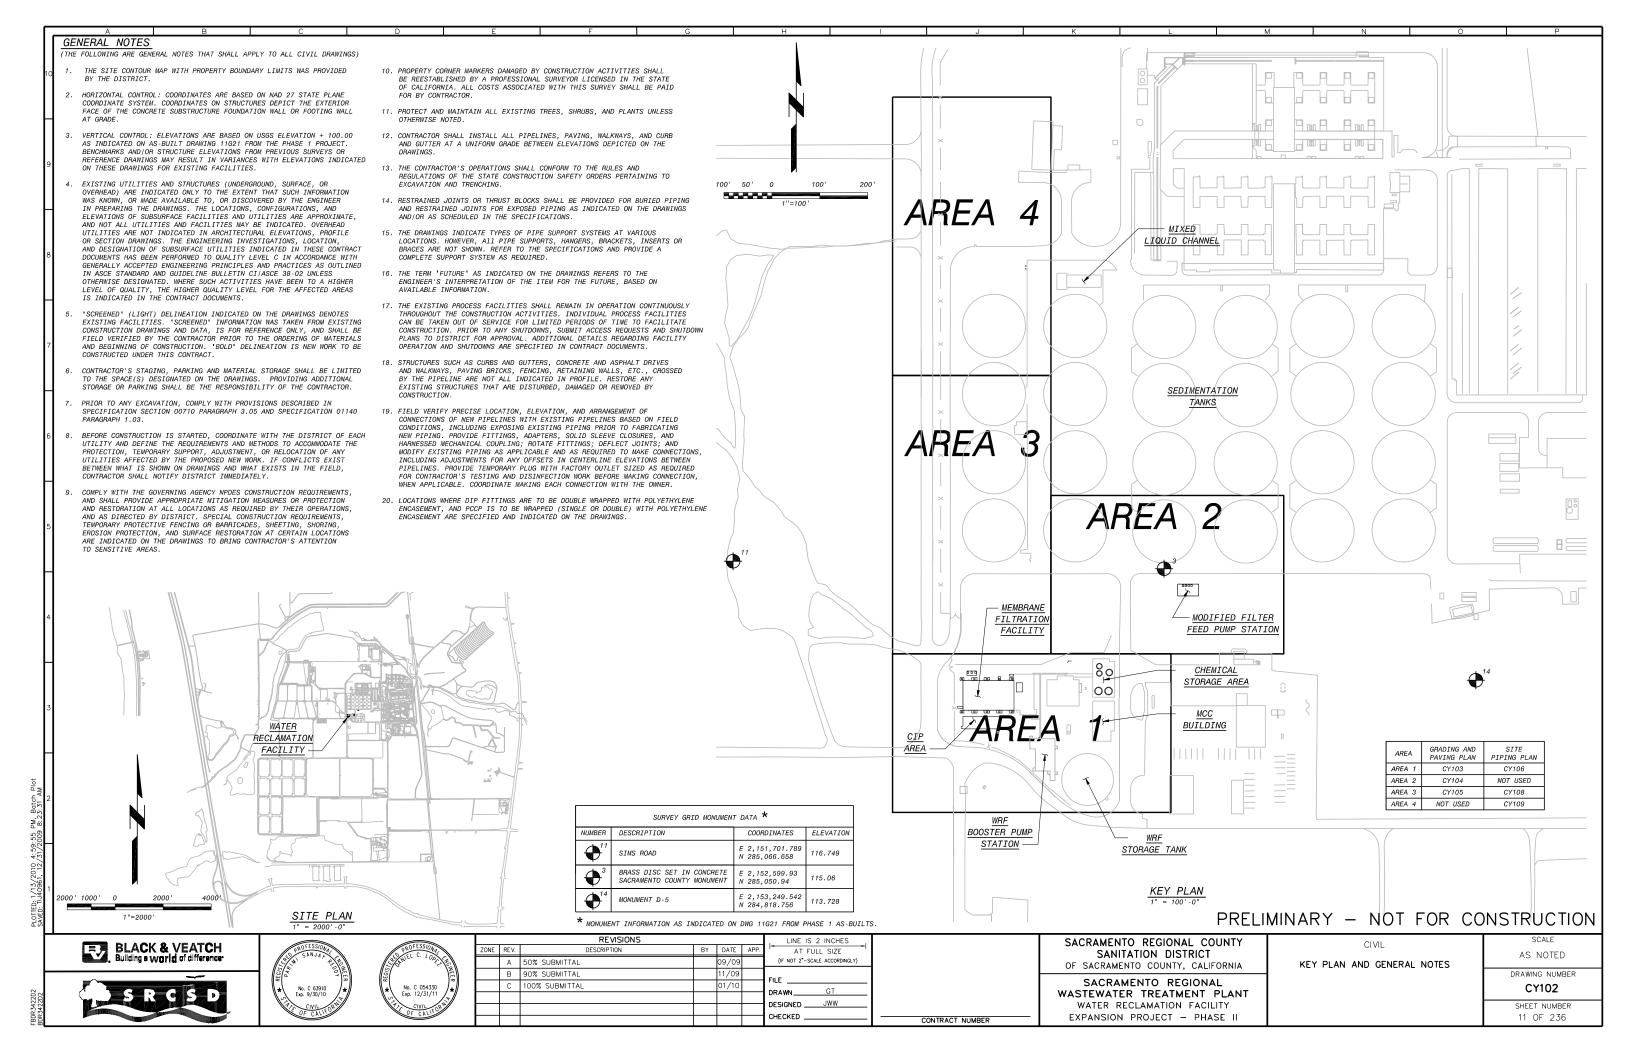


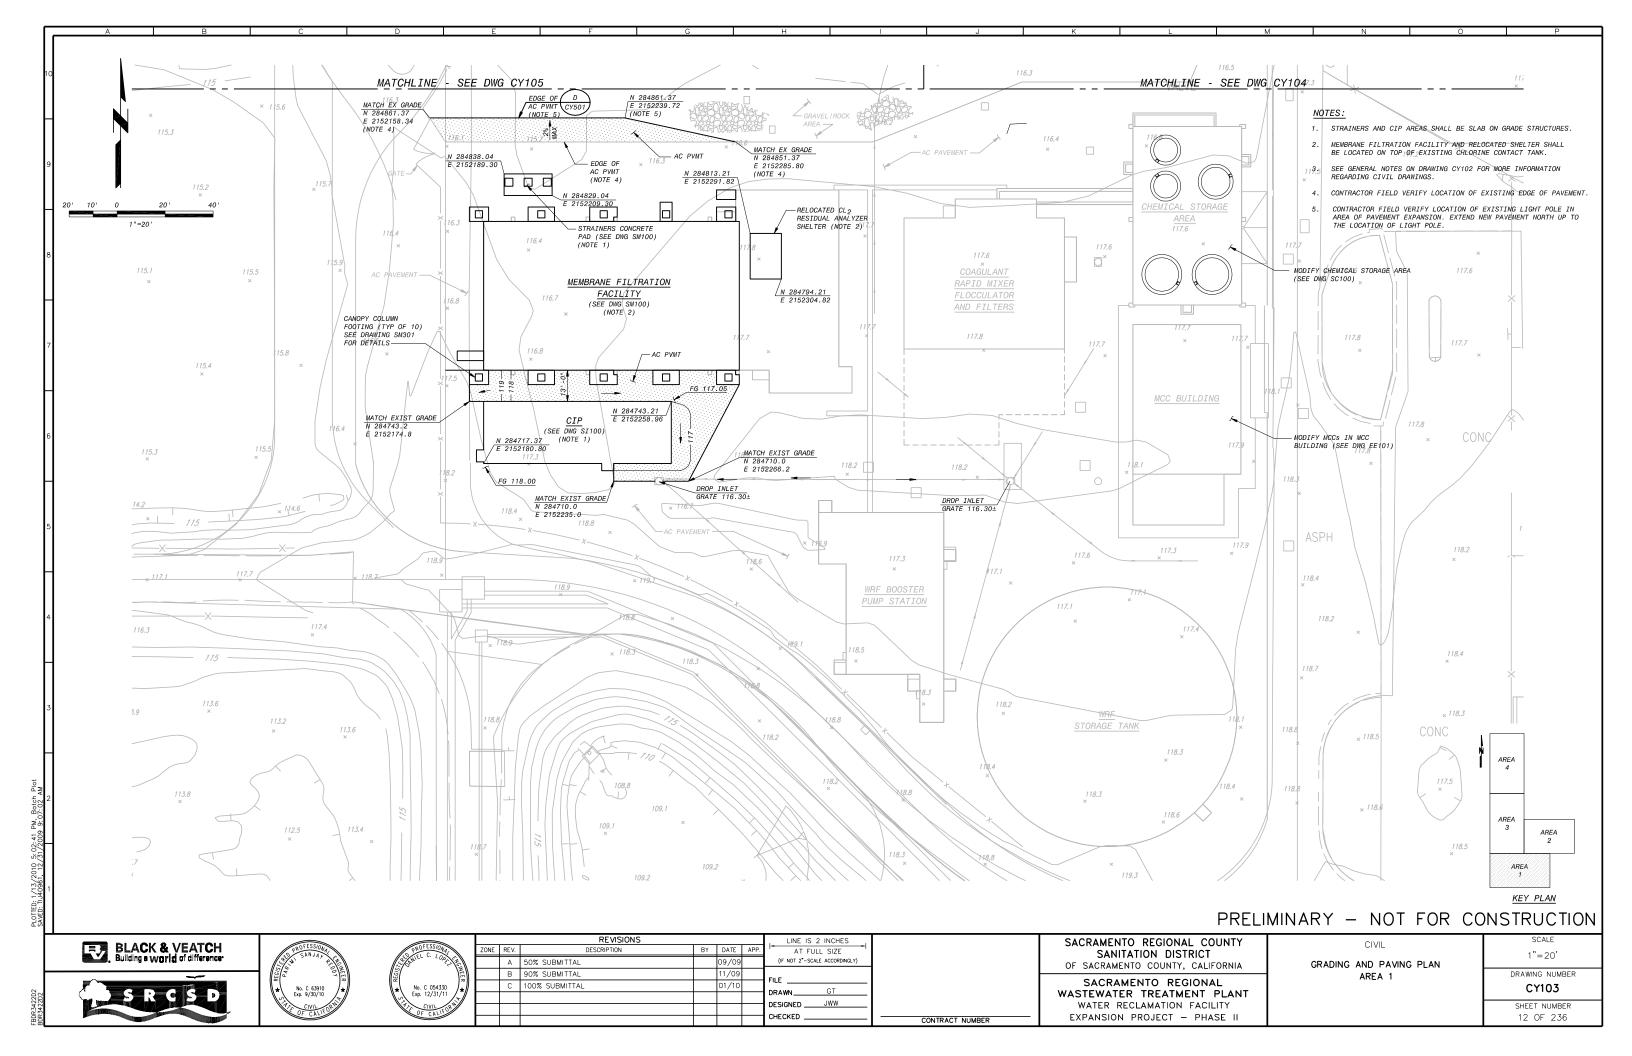


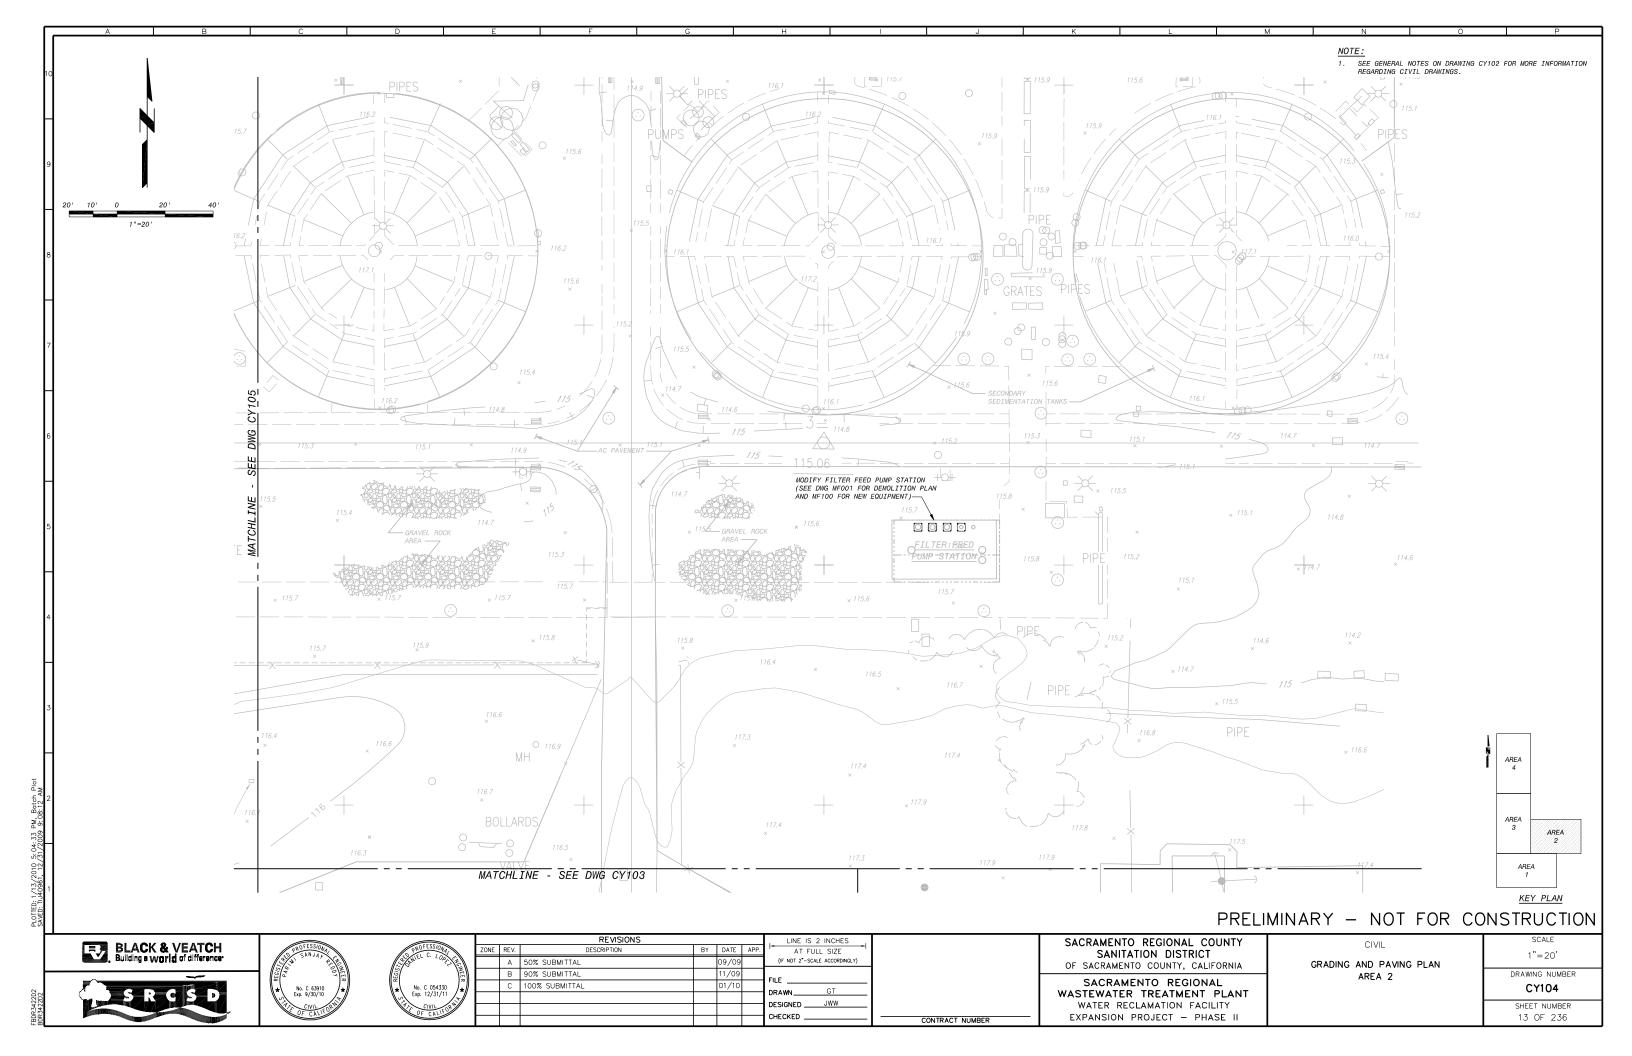


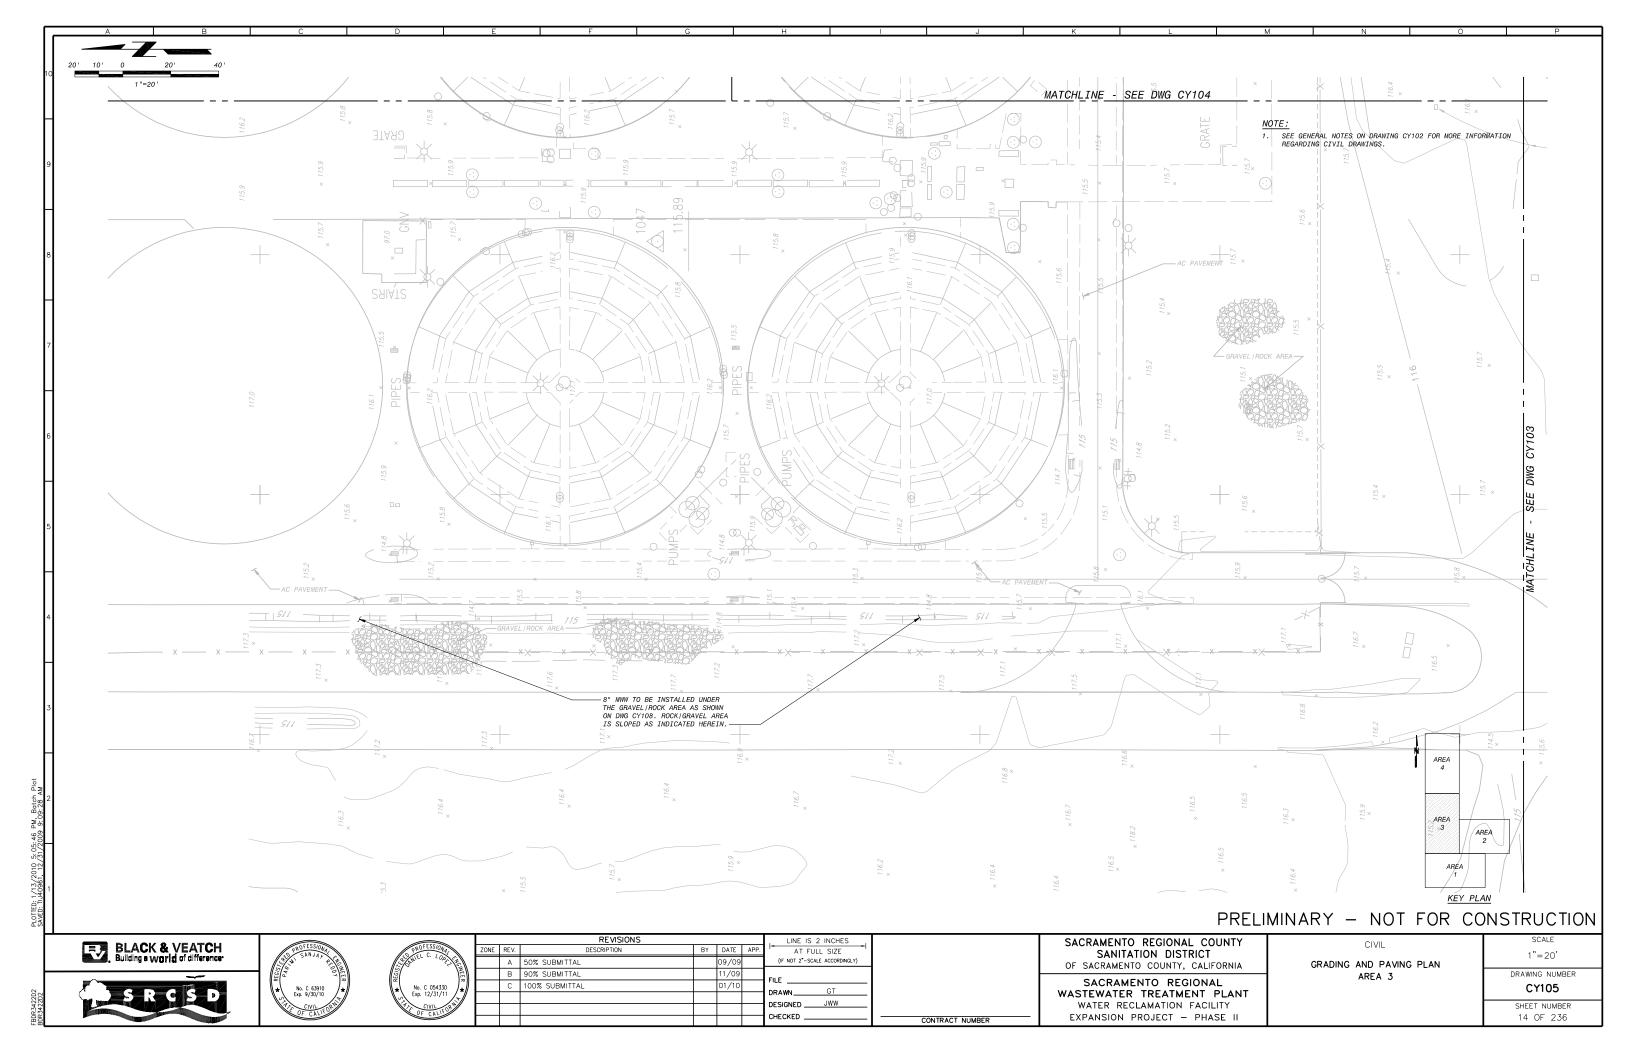

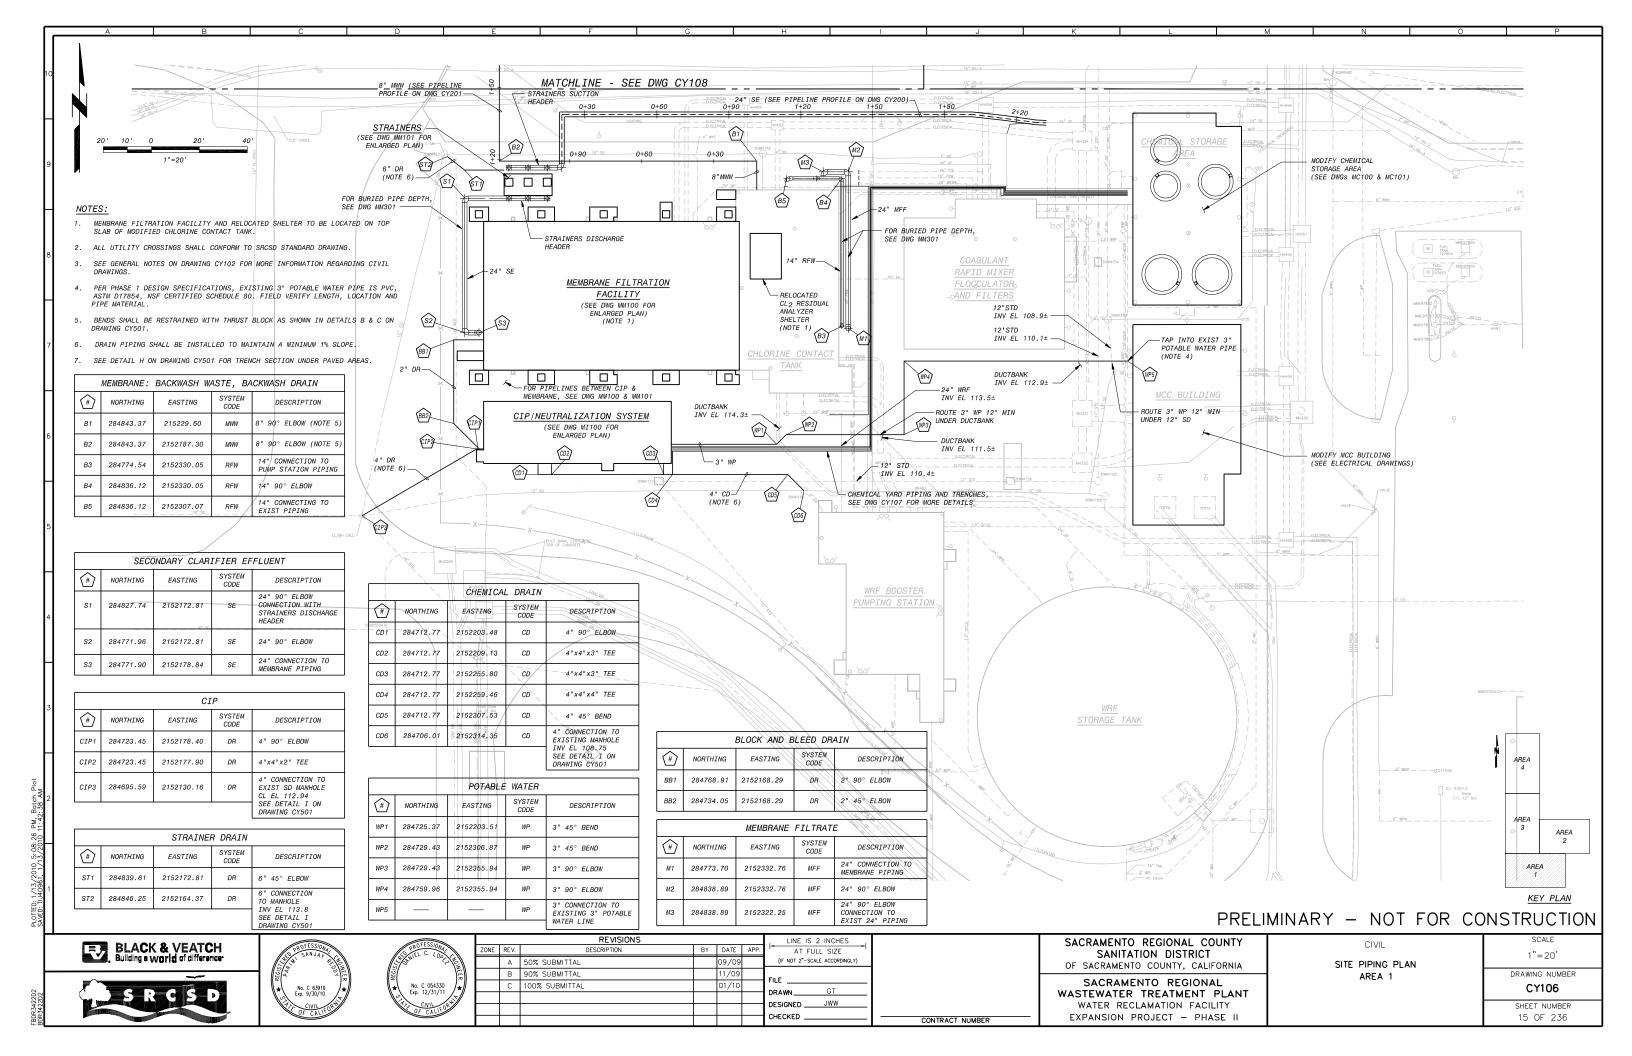


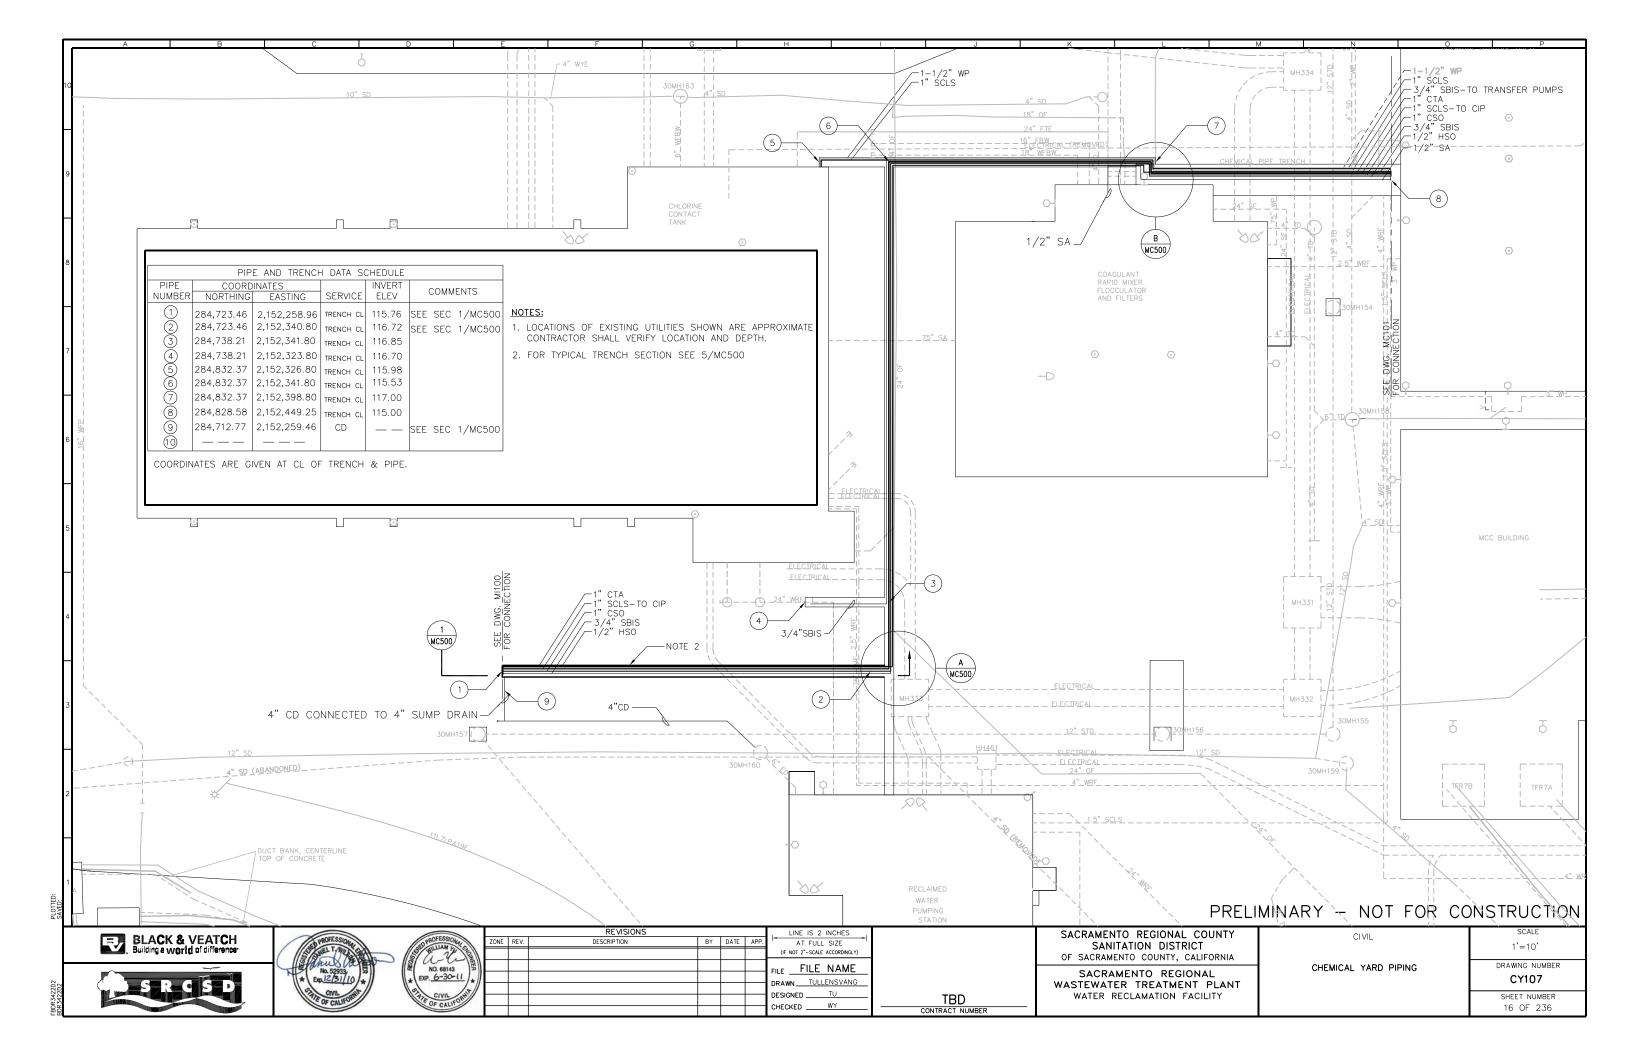

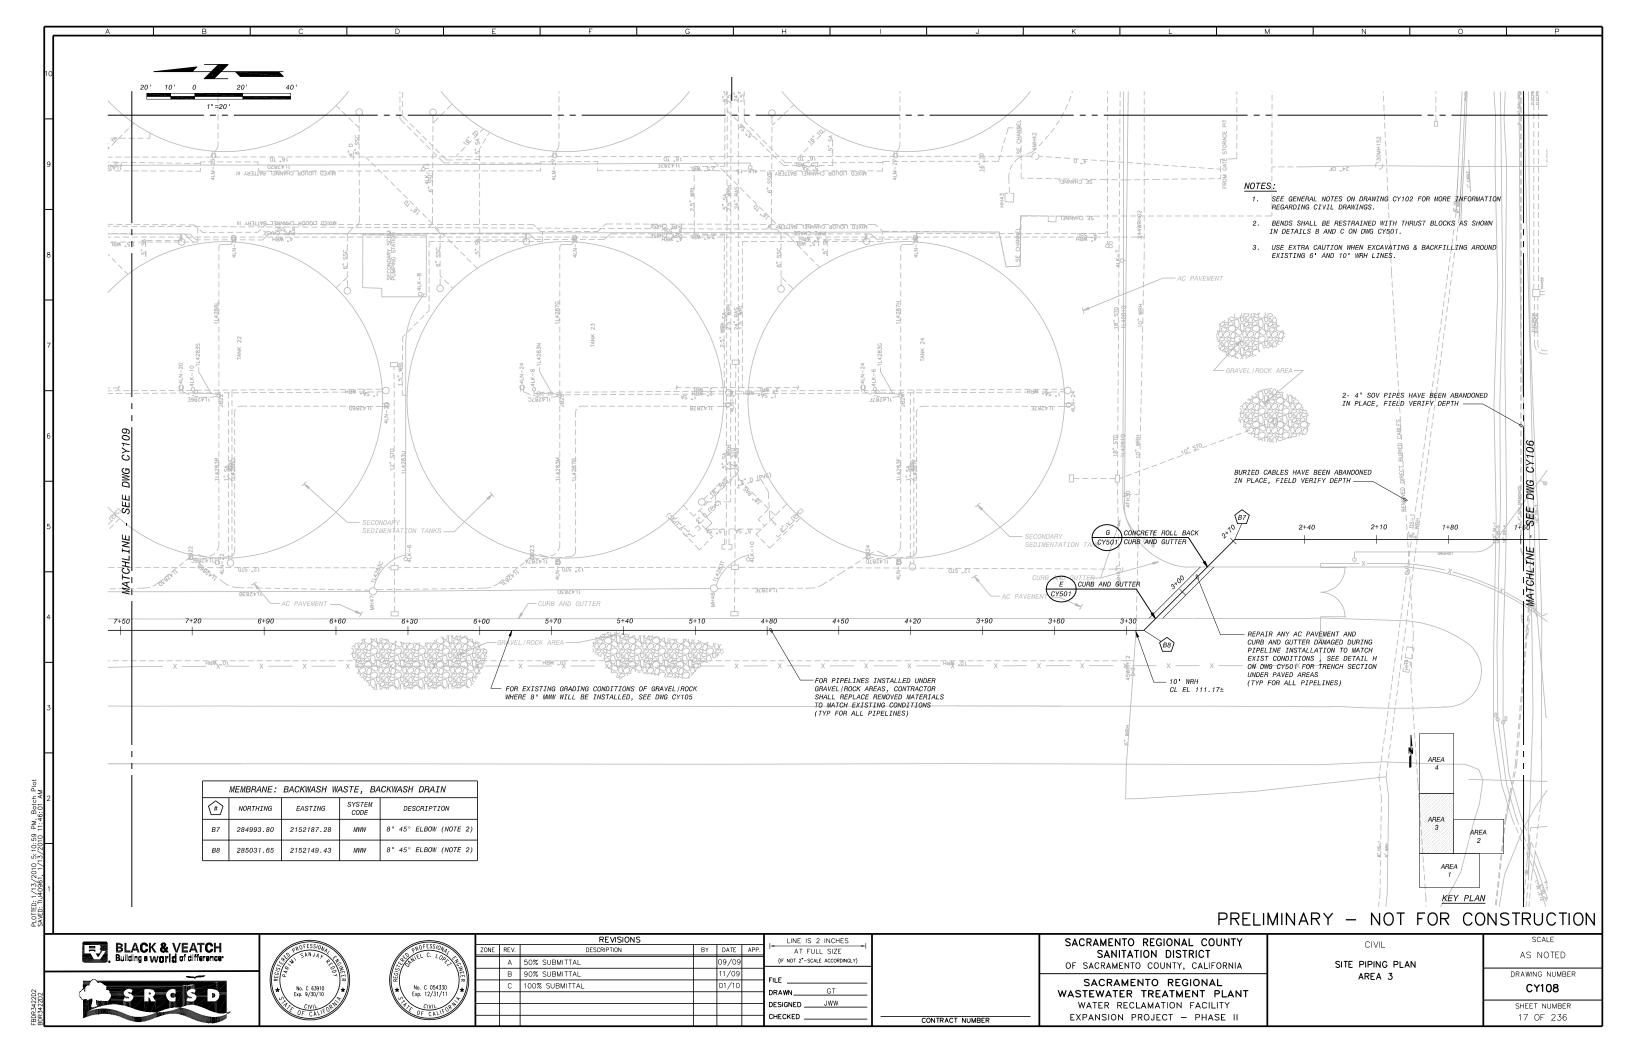

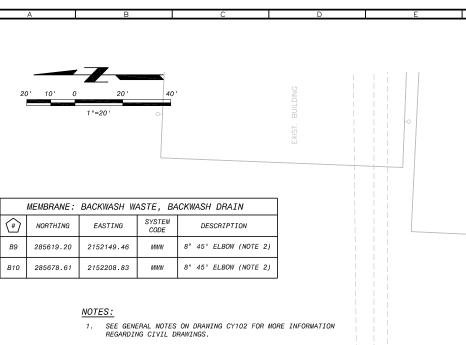

- 2. BENDS SHALL BE RESTRAINED WITH THRUST BLOCKS AS SHOWN INDETAIL B AND C ON DRAWING CY501.
- 3. FIELD VERIFY LOCATION OF EXISTING VALLEY GUTTER AND REPLACE PER F/CY501.

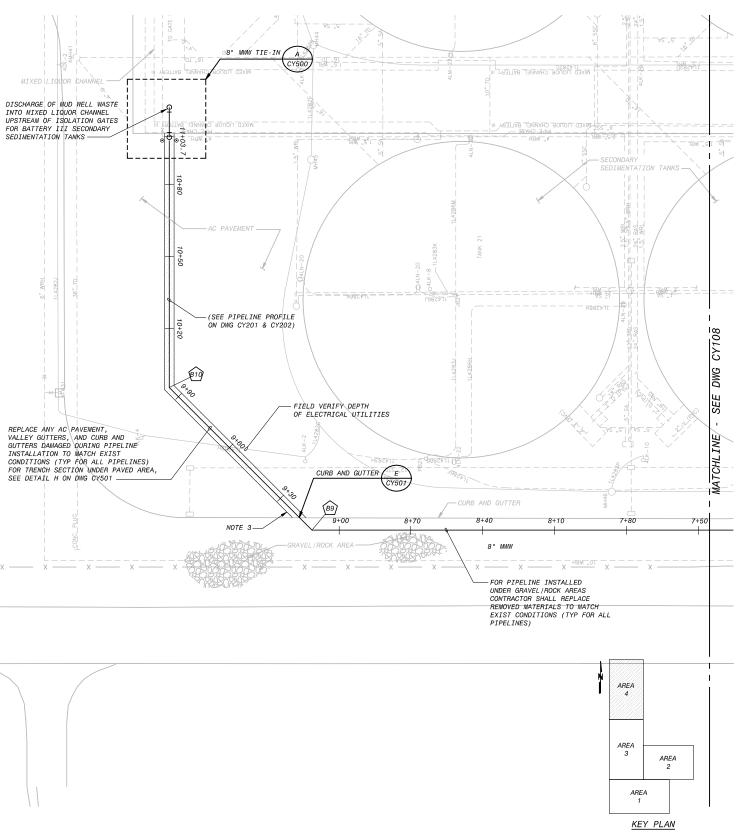

PRELIMINARY - NOT FOR CONSTRUCTION







			REVISIONS				. LINE IS 2 INCHES .
	ZONE	REV.	DESCRIPTION	BY	DATE	APP.	AT FULL SIZE
\		Α	50% SUBMITTAL		09/09		(IF NOT 2"-SCALE ACCORDINGLY)
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							DESIGNED
							CHECKED

SACRAMENTO REGIONAL COUNTY SANITATION DISTRICT OF SACRAMENTO COUNTY, CALIFORNIA	Ī
SACRAMENTO REGIONAL WASTEWATER TREATMENT PLANT WATER RECLAMATION FACILITY	$\left[\right]$

EXPANSION PROJECT - PHASE II


CONTRACT NUMBER

CIVIL SITE PIPING PLAN AREA 4 SCALE
AS NOTED

DRAWING NUMBER

CY109

SHEET NUMBER
18 OF 236

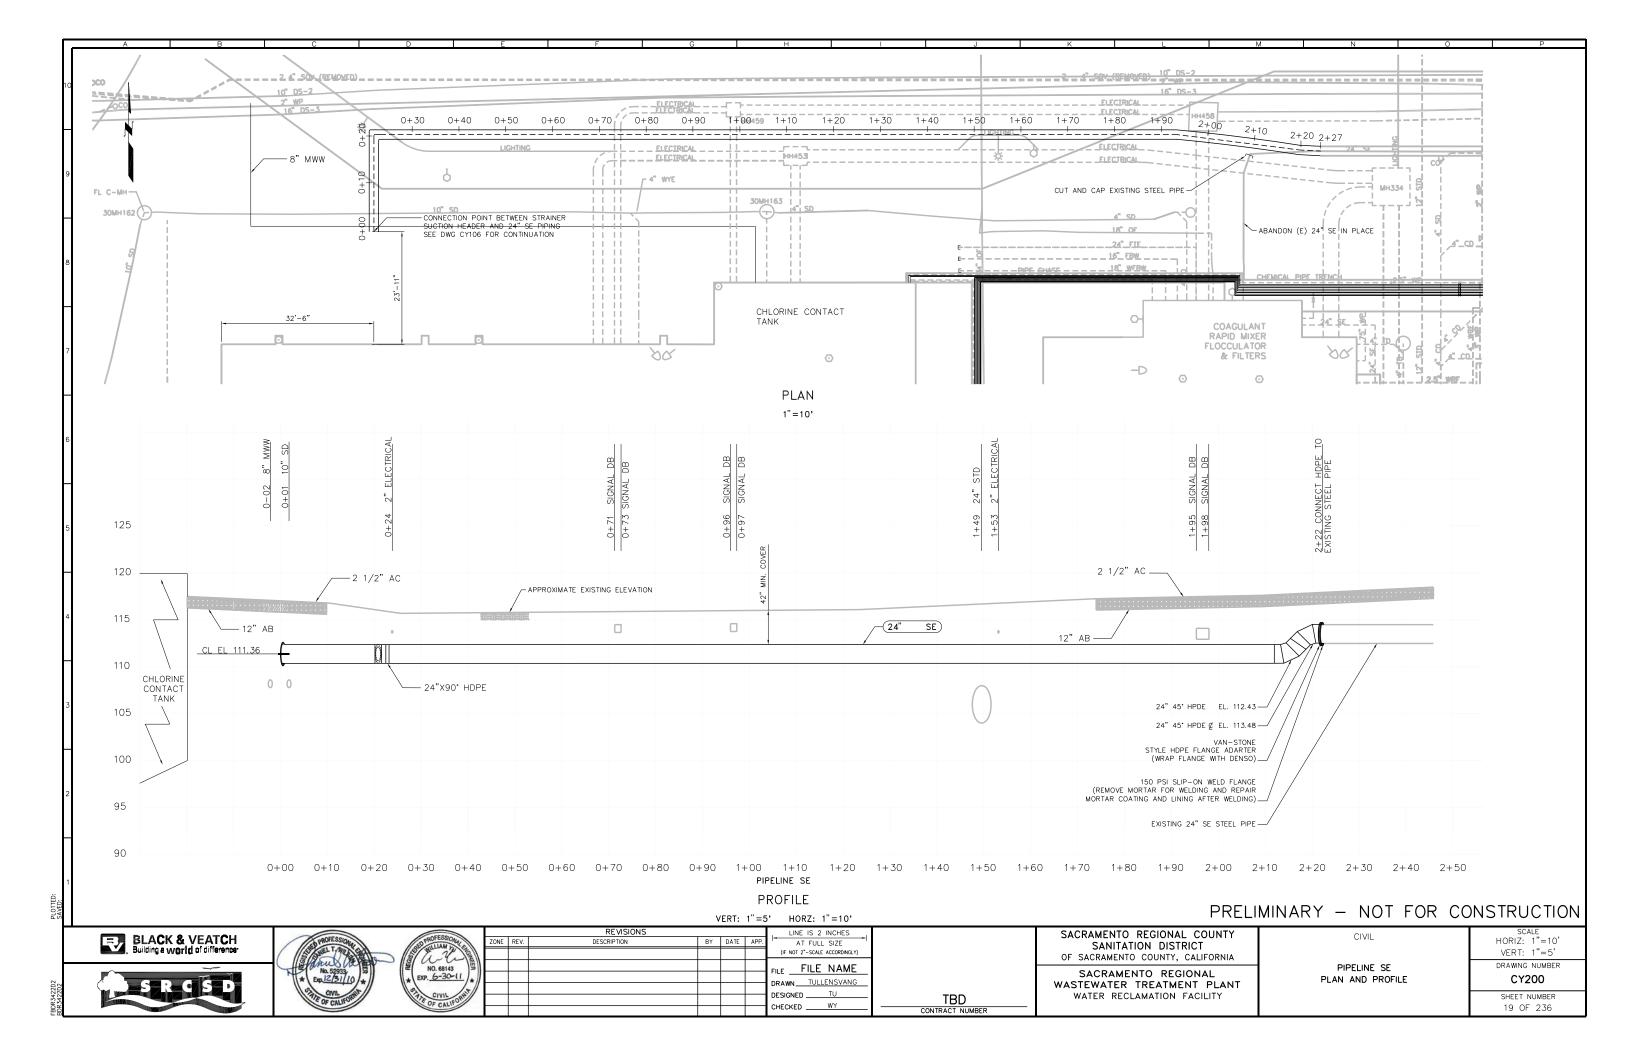

125 125 SIGNAL DUCTBAN STA 0+41.5± 4" DRAIN STA 0+37.0± INV EL 107.1= 120 120 SEE DWG MM100 FOR CONTINUATION 115 — PIPE CONTINUES WITH A
SLOPE OF 0.001, SEE
DWG CY202 FOR CONTINUATION
AT STA 9+00 AND SEE
DWG CY108 FOR PIPE
CROSSING INFORMATION MAINTAIN CONSTANT UP SLOPE \$=0.001 110 CL EL 109.76-AT A MINIMUM, PROVIDE RESTRAINED JOINTS FROM STA 0+00 TO STA 0+90 105 105 THRUST BLOCK C
(TYP) CY501 100 100 95 0+00 0+10 0+20 0+30 0+40 0+50 0+60 0+70 0+80 0+90 1+00 1+10 1+20 1+30 1+40 1+50 1+60 1+70 1+80 1+90 2+00 2+10

CONTRACT NUMBER

8" MWW YARD PIPING PROFILE

1"=5' VERT 1"=10' HORIZ

- 1. SEE DRAWINGS CY106, CY108 AND CY109 FOR PLAN VIEW OF PIPELINE.
- SEE GENERAL NOTES ON DRAWING CY102 FOR MORE INFORMATION REGARDING CIVIL DRAWINGS.

PRELIMINARY - NOT FOR CONSTRUCTION







		REVISIONS				LINE IS 2 INCHES
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	В	90% SUBMITTAL		11/09		FILE
	С	100% SUBMITTAL		01/10		
						DIVATIN
						DESIGNED
						CHECKED

SACRAMENTO REGIONAL COUNTY	Т
SANITATION DISTRICT	Т
OF SACRAMENTO COUNTY, CALIFORNIA	ı
SACRAMENTO REGIONAL	1
SACRAMENTO REGIONAL WASTEWATER TREATMENT PLANT	1

EXPANSION PROJECT- PHASE II

MWW YARD PIPING PROFILE SHEET 1 OF 2

CIVIL

SCALE AS SHOWN DRAWING NUMBER CY201 SHEET NUMBER 20 OF 236

125 125 120 120 FOR CONTINUATION SEE DETAIL A ON DWG CY500 FINISHED PIPE CONTINUES WITH A
SLOPE OF 0.001, SEE
DWG CY201 FOR PIPE
CROSSING INFORMATION — 115 S=0.001 MAINTAIN CONSTANT UP SLOPE 110 110 - AT A MINIMUM, PROVIDE RESTRAINED JOINTS FROM STA 10+13 TO STA 11+03.7± 105 105 100 100 9+00 10+10 10+20 11+00 11+10

> 1"=5' VERT 1"=10' HORIZ

8" MWW YARD PIPING PROFILE

NOTES

1. NOTES ON DRAWING CY201 ALSO APPLY TO THIS DRAWING.

PRELIMINARY - NOT FOR CONSTRUCTION

BLACK & VEATCH
Building a World of difference





		REVISIONS				, LINE IS 2 INCHES ,
ZONE	REV.	DESCRIPTION	BY	DATE	APP.	AT FULL SIZE
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	В	90% SUBMITTAL		11/09		FILE
	С	100% SUBMITTAL		01/10		DRAWN JLK
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						DESIGNED
						CHECKED

SACRAMENTO REGIONAL COUNTY
SANITATION DISTRICT
OF SACRAMENTO COUNTY, CALIFORNIA
SACRAMENTO REGIONAL
SACRAMENTO REGIONAL WASTEWATER TREATMENT PLANT

EXPANSION PROJECT - PHASE II

CONTRACT NUMBER


YARD PIPING PROFILE SHEET 2 OF 2


CIVIL

SCALE
AS SHOWN
DRAWING NUMBER

CY202

SHEET NUMBER
21 OF 236

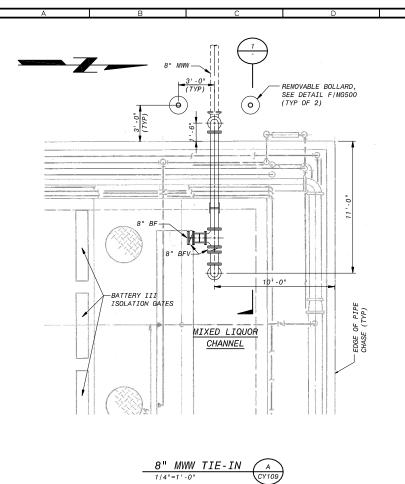

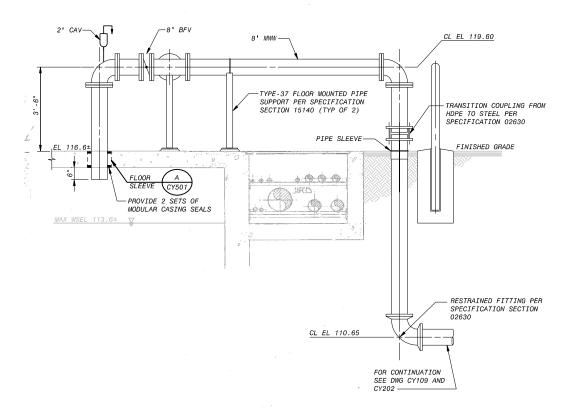

SECTION 1

PRELIMINARY - NOT FOR CONSTRUCTION







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SACRAMENTO REGIONAL COUNTY							
SANITATION DISTRICT							
OF SACRAMENTO COUNTY, CALIFORNIA							
SACRAMENTO REGIONAL							
SACRAMENTO REGIONAL WASTEWATER TREATMENT PLANT							

EXPANSION PROJECT - PHASE II


CONTRACT NUMBER

YARD STRUCTURES PLAN AND SECTION

CIVIL


SCALE
AS SHOWN
DRAWING NUMBER
CY500

SHEET NUMBER
22 OF 236

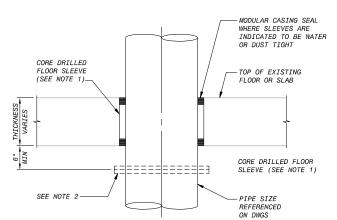



- 1. CORE DRILL SMOOTH FLOOR OPENING AND COORDINATE DIAMETER WITH MODULAR CASING SEAL MANUFACTURER. MAXIMUM CORE DIAMETER 12". FOR PIPES 8" OR SMALLER.
- 2. TO MINIMIZE SLEEVE SIZE PROVIDE SCREW-ON FLANGE, GROOVED COUPLING, OR MECHANICAL COUPLING WITH ANCHOR STUDS ON ONE SIDE OF OPENING. NOT NEEDED FOR 8" MWW DISCHARGE FLOOR SLEEVE.



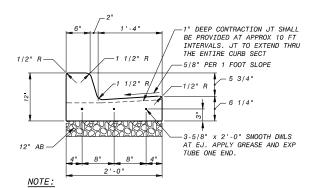


DETAIL PROVIDED FOR BIDDING PURPOSES. CONTRACTOR TO REPLACE EXISTING CURB AND GUTTER TO MATCH EXISTING

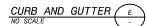

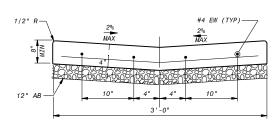


DETAIL PROVIDED FOR BIDDING PURPOSES, CONTRACTOR TO REPLACE EXISTING VALLEY GUTTER TO MATCH EXISTING


VALLEY GUTTER DETAIL F. CY10

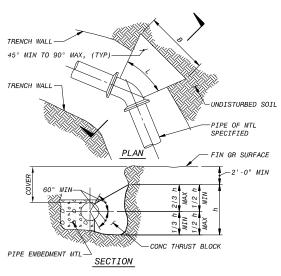


- 1. AREA OF BLOCK, A = Bxh. BLOCK AREAS ARE SHOWN ON GENERAL LAYOUT OR TABLE.
- 2. $B = h = \sqrt{A}$, EXCEPT WHERE TOP OF BLOCK IS WITHIN 2 FEET FROM GROUND SURFACE,
- 3. MINIMUM BLOCK DIMENSION (B & h) SHALL BE AT LEAST OD OF PIPE OR 1 FOOT FOR PIPE OD 12" OR LESS.
- 4. THE BOTTOM OF THE BLOCK SHALL EXTEND AT LEAST TO THE BOTTOM OF THE TRENCH IN ALL CASES.
- 5. L=FITTING LENGTH MINUS CLEARANCE FOR BELLS.
- 6. DETAIL IS SHOWN FOR CAST IRON PIPE; DETAIL IS SIMILAR FOR OTHER TYPES OF PIPE.


HORIZONTAL THRUST GUIDE												
	PIPE CHARAC	THRUST BLOCK AREAS										
SIZE	MATERIAL	TEST PRESSURE	90°	45°	22.5°	11.25°						
(IN)		(PSI)	FT²	FT²	FT²	FT²						
8	PVC W/ DIP FITTING	135	7	4	2	2						

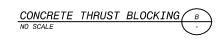


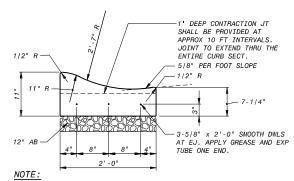

DETAIL PROVIDED FOR BIDDING PURPOSES. CONTRACTOR TO REPLACE EXISTING ROLL BACK CURB AND GUTTER TO MATCH

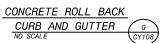

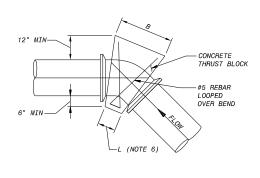

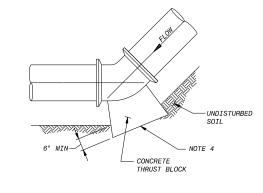

UPWARD BEND


DOWNWARD BEND

NOTES:

- APPLY BOND BREAKER TAPE AROUND FITTING.
- CONCRETE IS NOT TO BE PLACED OVER PIPE JOINTS.
- WHERE POSSIBLE, INSTALL FULL LENGTH (20'-0") PIPE SECTIONS ON EITHER SIDE OF UPWARD BEND.
- FOR DOWNWARD BENDS, DIMENSIONS FOR BLOCK AREA SHALL CONFORM TO NOTE 2 IN DETAIL B OF THIS DRAWING.
- 6. L = INSIDE FITTING LENGTH MINUS CLEARANCE FOR BELLS.

VERTICAL THRUST GUIDE											
PIPE CHARACTERISTICS DOWNWARD UPWARD BEN BEND AREAS DIMENSION:											
SIZE	MATERIAL	TEST PRESSURE	11.25°	11.	25°						
(IN)		F²	В	W							
8	PVC W/ DIP FITTING	135	2	2'-6"	2"-9"						




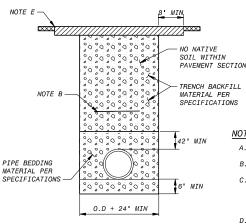


TRENCH SECTION IN IMPROVED AREAS

CONTRACT NUMBER

- A. MATCH EXISTING A.C. THICKNESS, 2 1/2" MIN., 4" MAX.
- B. CONDUCTIVE TRACER AS REQUIRED PER SPECIFICATIONS.
- C. T-CUT REQUIRED FOR ALL PAVEMENTS AND SHALL BE 1-1/2" DEEP BY GRINDING AND PAVING, MIN. 8' WIDE. IF CENTER OF TRENCH IS WITHIN 20' OF LIP OF GUTTER, GRIND AND. PAVE TO LIP OF GUTTER.
- D. STREET SECTION SHALL HAVE A MINIMUM 12" OF AB OR
- E. COAT ALL EXISTING VERTICAL FACES WITH ASPHALTIC EMULSION (TACK) PRIOR TO PAVING.
- F. SEE SPECIFICATIONS FOR COMPACTION REQUIREMENTS.

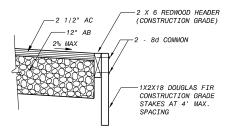

EDGE OF PAVEMENT (D) NO SCALE

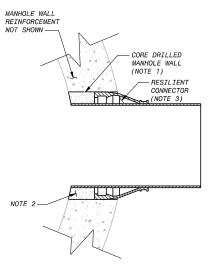

- 1. CORE DRILL SMOOTH OPENING THROUGH MANHOLE WALL AND COORDINATE DIAMETER W/ RESILIENT CONNECTOR MANUFACTURER.
- 2. ANNULAR SPACES BETWEEN PIPE AND MANHOLE TO BE SEALED W/ MASTIC FILL OR GROUT APPROVED BY ENGINEER.
- INSTALL RESILIENT CONNECTOR IN ACCORDANCE W/ MANUFACTURER'S RECOMMENDATIONS.

CORE DRILLED MANHOLE CONNECTION (

PRELIMINARY - NOT FOR CONSTRUCTION







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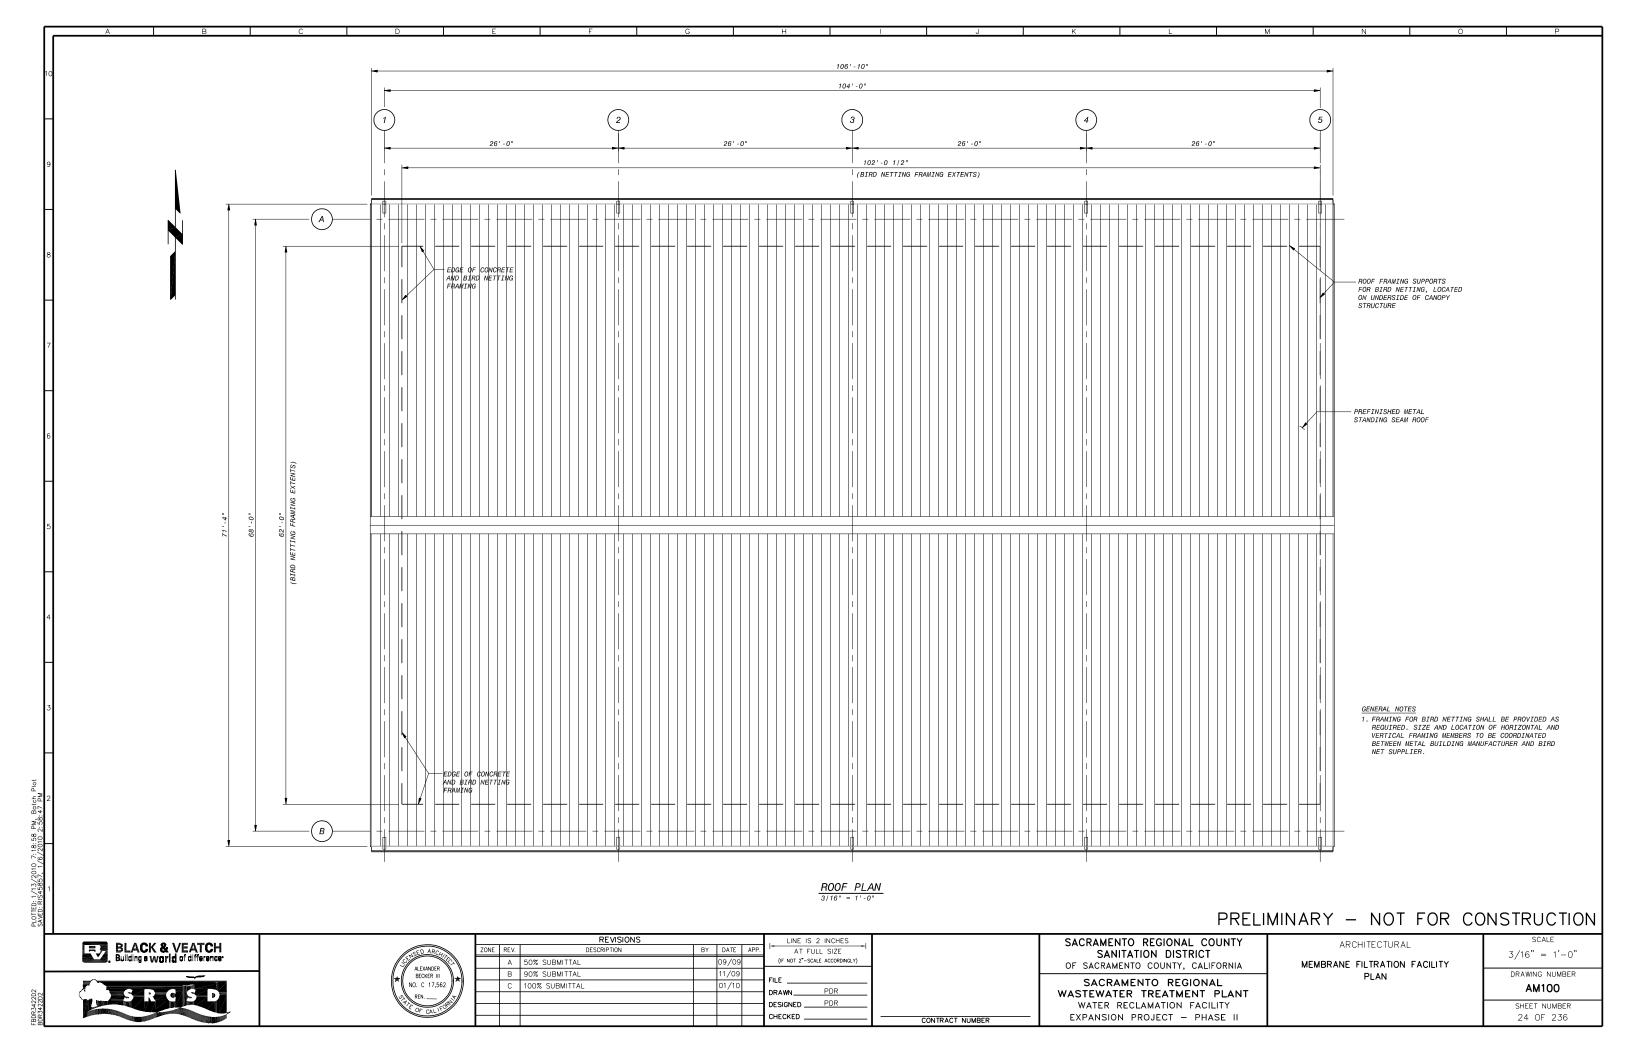
SACRAMENTO REGIONAL COUNTY SANITATION DISTRICT OF SACRAMENTO COUNTY, CALIFORNIA


SACRAMENTO REGIONAL WASTEWATER TREATMENT PLANT WATER RECLAMATION FACILITY EXPANSION PROJECT - PHASE II


CIVIL TYPICAL DETAILS

AS SHOWN DRAWING NUMBER CY501 SHEET NUMBER

23 OF 236



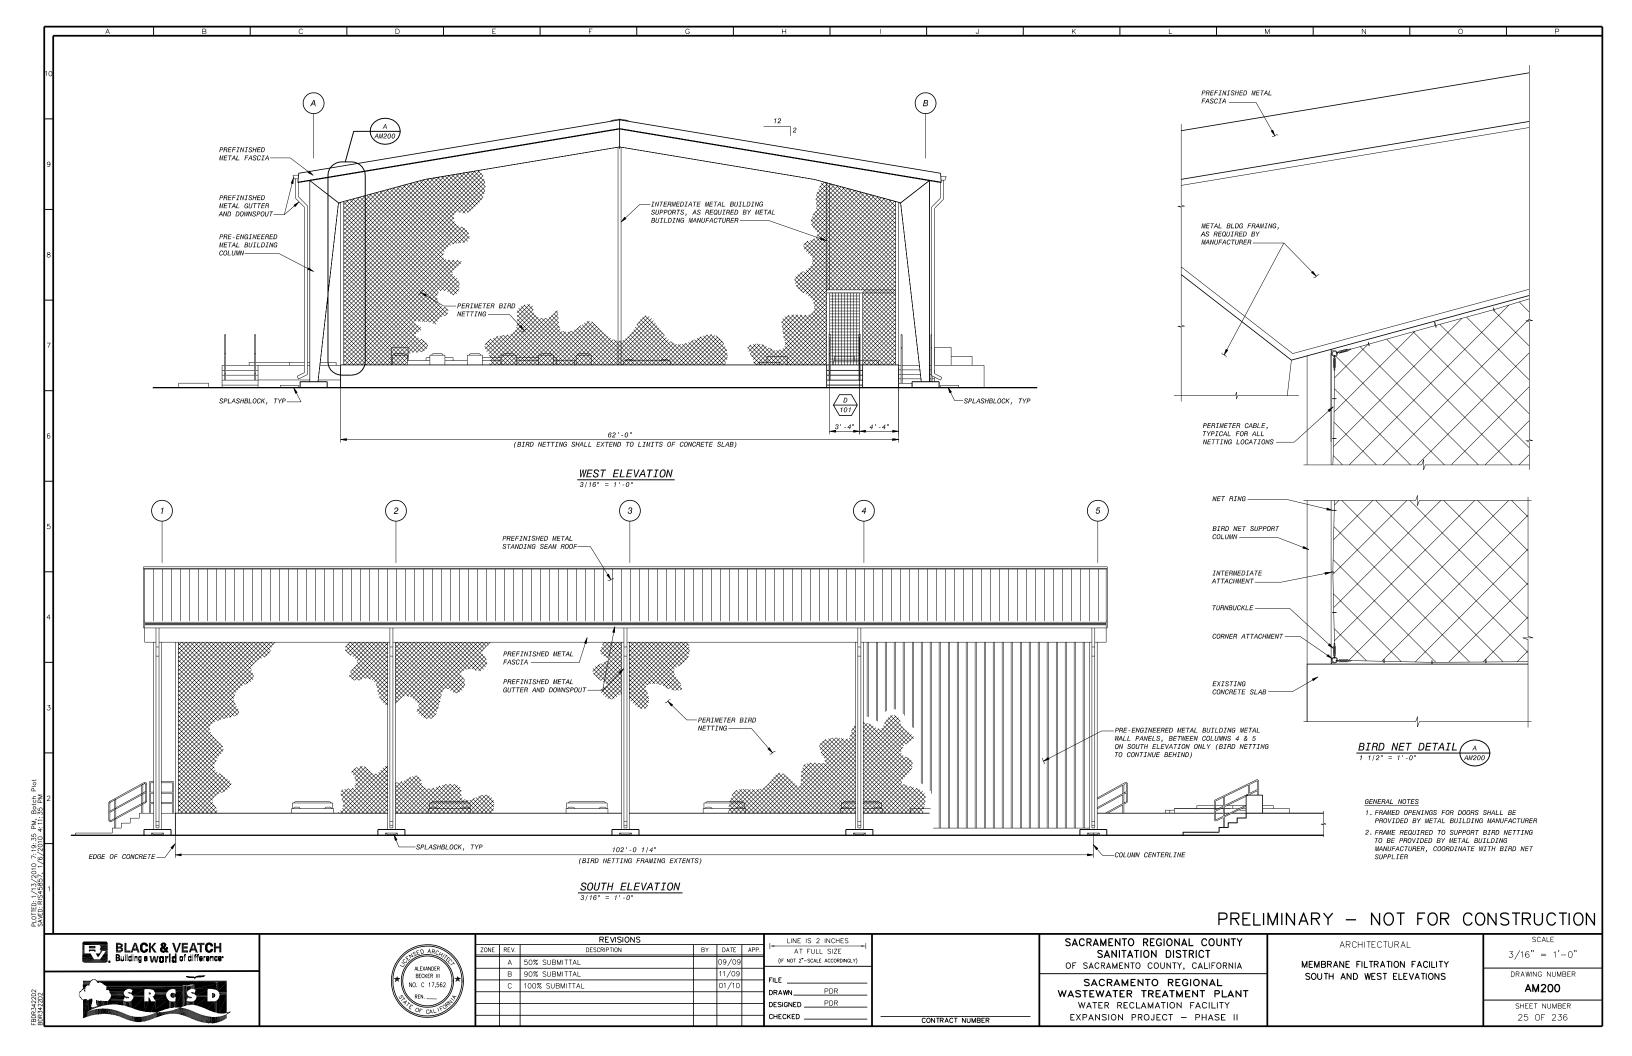

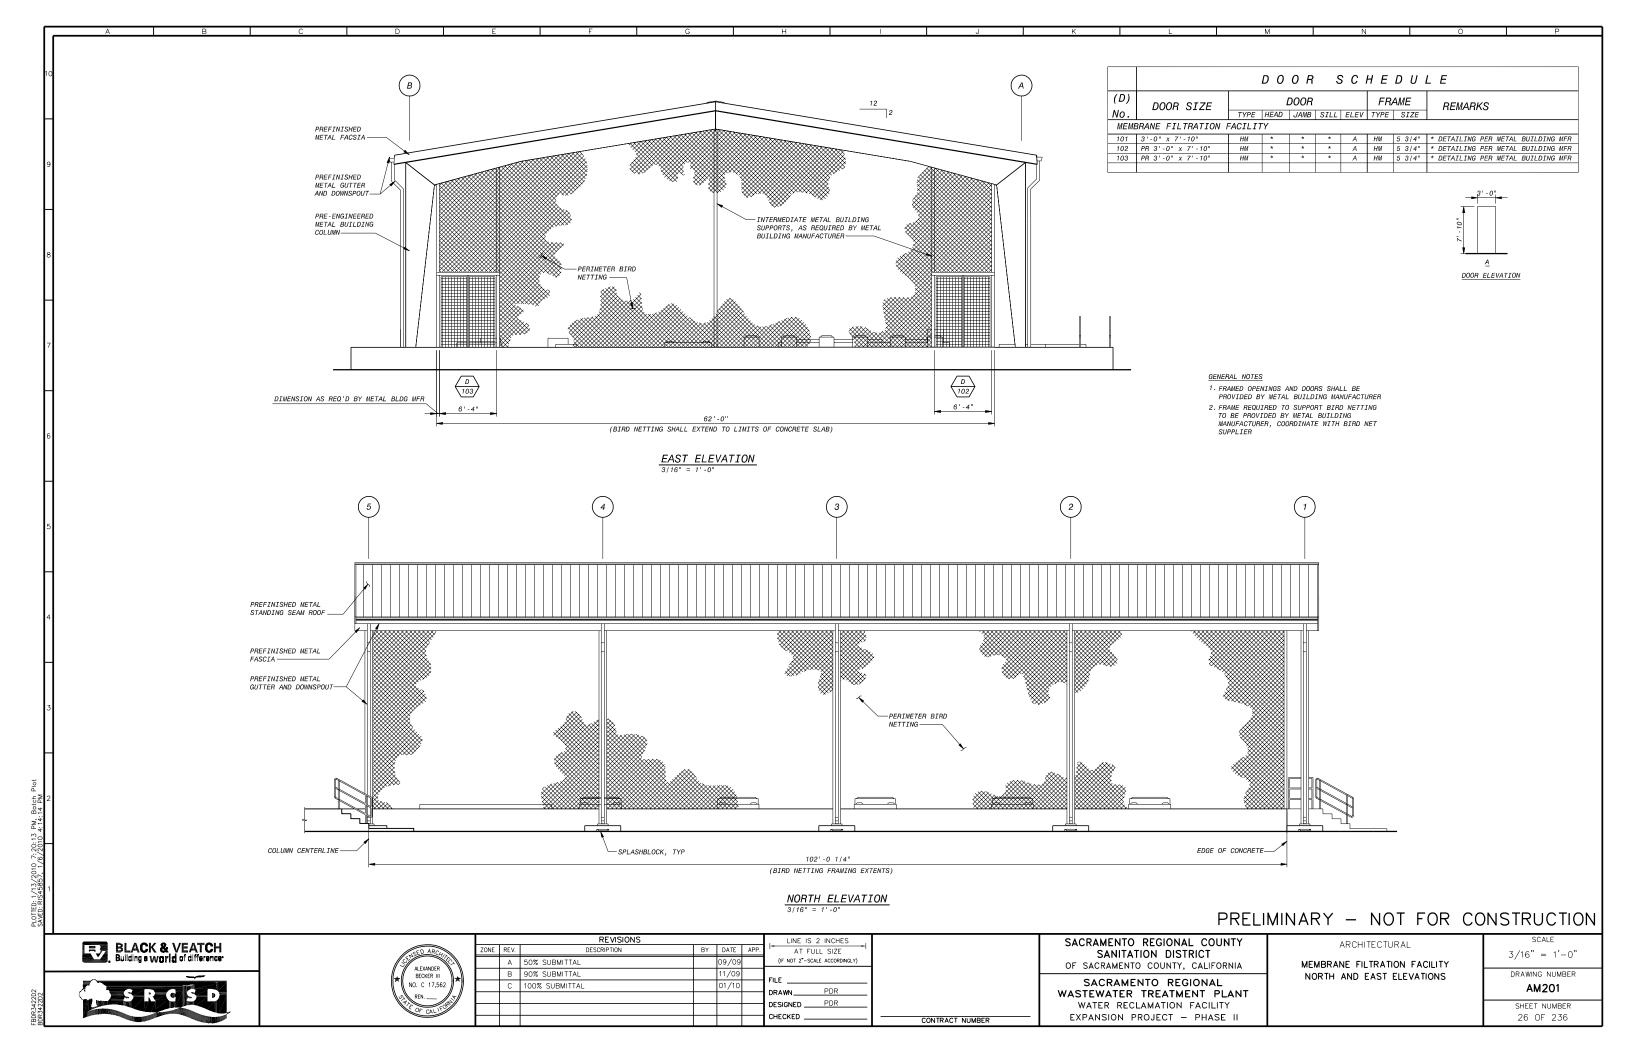

- 2. STRUCTURES ARE DESIGNED FOR OPERATIONAL (OCCUPANCY) LOADS ON THE COMPLETED STRUCTURES. DURING CONSTRUCTION, THE STRUCTURES SHALL BE PROTECTED BY BRACING, BALANCING AND SHORING WHEREEVER CONSTRUCTION LOAD MAY OCCUR.
- FOR LOCATIONS AND DIMENSIONS OF SLEEVES, CURB, OPENINGS AND DEPRESSIONS NOT SHOWN ON THE STRUCTURAL DRAWINGS, SEE ARCHITECTURAL, CIVIL IMECHANICAL, YARDWORK, PLUMBING, HVAC AND ELECTRICAL DRAWINGS. CONTRACTOR SHALL VERIFY AND COORDINATE REQUIREMENT FOR LOCATION OF ABOVE ITEMS WHETHER SHOWN ON THE STRUCTURAL DRAWINGS OR NOT.
- 4. ALL STRUCTURAL RELATED SHOP DRAWINGS SHALL BE SUBMITTED, REVIEWED & ACCEPTED BY THE ENGINEER PRIOR TO ERECTION/CONSTRUCTION.

CAST-IN-PLACE CONCRETE

- 1. A MINIMUM 28 DAY COMPRESSIVE STRENGTH (f'c) of 4,000 PSI WAS UTILIZED IN THE DESIGN OF
- 2. CEMENT SHALL BE ASTM C150, TYPE II, LOW ALKALI.
- 3. ALL CONCRETE CONSTRUCTION SHALL CONFORM TO THE OCCA AND THE ACI 318 "BUILDING CODE REQUIREMENTS FOR REINFORCED CONCRETE" INCLUDING BAR BENDS AND HOOKS, UNLESS
- THE LOCATION OF CONSTRUCTION JOINTS AND OTHER TYPES OF JOINTS, OTHER THAN SPECIFIED OR SHOWN ON THE PLANS, SHALL BE APPROVED BY THE ENGINEER PRIOR TO PLACING CONCRETE. CONSTRUCTION JOINTS SHALL BE LOCATED AS INDICATED ON THE DRAWINGS AND IN ACCORDANCE WITH PROJECT SPECIFICATION SECTION 03250-COBCRETE JOINTS AND ACCESSORIES, ARTICLE 3-1. CONSTRUCTION JOINTS PACING IN WALLS AND SLABS SHALL NOT EXCEDE 00 FEET, WITH JOINTS IN WALLS ALCATED NOT MORE THAN 40 FEET FROM NEAREST CORNER PER DETAILS ON DRAWING SGSOO.
- 5. ALL EXPOSED EDGES AND CORNERS, UNLESS NOTED OTHERWISE, SHALL BE CHAMFERED 3/4" EXCEPT THE TOP EDGE OF WALLS AND SLABS WHICH ARE TO BE TOOLED.
- 6. ALL EXISTING CONSTRUCTION JOINTS SHALL BE ROUGHENED TO 1/4" AMPLITUDE MINIMUM.

REINFORCING STEEL

- 1. ALL REINFORCING BAR SHALL BE GRADE 60, DEFORMED, ASTM A615
- 2. WELDED WIRE FABRIC SHALL CONFORM TO ASTM A185 OR A497
- DIMENSIONS TO REINFORCING BARS ARE TO BAR CENTERLINES, UNLESS NOTED OTHERWISE. BAR COVER IS CLEAR DISTANCE BETWEEN BAR AND THE CONCRETE SURFACE. BAR COVERS AS SHOWN ON THE "STANDARD CONCRETE REINFORCING DETAILS" SHEET SHALL BE PROVIDED UNLESS NOTED OTHERWISE.
- SPLICING OF REINFORCEMENT FOR WALLS, FOOTINGS AND SLABS SHALL BE AS SHOWN ON THE "STANDARD CONCRETE REINFORCING DETAILS" SHEET, UNLESS NOTED OTHERWISE. WHEN BARS OF DIFFERENT SIZE LAP TO EACH OTHER, SPLICE LENGTH OF THE LARGER BAR SHALL BE USED.
- 5. LINIESS INDICATED OTHERWISE ALL DOWELS SHALL HAVE THE SAME SIZE AND SPACING AS THOSE OF THE REINFORCING STEEL TO WHICH THEY ARE SPLICED AND SHALL HAVE A MINIMUM LAP PER NOTE NO. 4 ABOVE, UNLESS NOTED OTHERWISE.
- NO WELDING OF REINFORCING BARS SHALL BE PERMITTED, UNLESS APPROVAL IS OBTAINED FROM THE ENGINEER PRIOR TO CONSTRUCTION.

STAINLESS STEEL

- 1. STAINLESS STEEL BOLTS SHALL CONFORM TO ASTM F593, ALLOY GROUP 1 OR 2, UNLESS NOTED OTHERWISE.
- 2. STAINLESS STEEL PLATES, BARS AND RODS SHALL CONFORM TO ASTM A240, TYPE 316L
- 3. STAINLESS STEEL STRUCTURAL SHAPES AND STUDS SHALL CONFORM TO ASTM A276. TYPE 316L.

- 1. UNLESS NOTED OTHERWISE, ALUMINUM ALLOY IN ALL ALUMINUM STRUCTURAL MATERIALS SHALL BE 6061-T6. PIPE AND TUBING FOR GUARDRAIL AND HANDRAIL SHALL BE ALLOY 6061-T6.
- ALL ALUMINUM SURFACES IN CONTACT WITH CONCRETE OR DISSIMILAR METALS SHALL BE COATED OR COVERED WITH A HEAVY COAT OF EPOXY ENAMEL TO PREVENT ALUMINUM-CONCRETE REACTION OR ELECTROLYTIC ACTION.
- 3. ALL ALUMINUM WELDING SHALL CONFORM TO THE PROVISIONS OF THE LATEST STRUCTURAL WELDING CODE (AWS D1.2)
- 4. AN AWS CERTIFIED FABRICATOR IS REQUIRED FOR ALL ALUMINUM STRUCTURES.

STRUCTURAL STEEL

- UNLESS NOTED OTHERWISE, STRUCTURAL STEEL SHALL CONFORM TO ASTM A36, ROLLED WIDE FLANGE SHAPES TO ASTM A992; STRUCTURAL PIPES TO ASTM A53, TYPE E OR S, GRADE B OR ASTM A500, GRADES B OR C, OR ASTM A501, STRUCTURAL TUBLING TO ASTM A500, GRADE B OR C. ALL STRUCTURAL STEEL SHALL BE FABRICATED AND ERECTED IN CONFORMANCE WITH THE NINTH EDITION OF AISC SPECIFICATIONS PARTS 1 THRU 4 AND THE "SPECIFICATION FOR STRUCTURAL
- ANCHOR BOLTS SHALL CONFORM TO ASTM A307 OR TO ASTM A36 THREADED ROD UNLESS NOTED OTHERWISE ON THE DRAWINGS. SET ANCHOR BOLTS WITH TEMPLATE AND SECURE TO PREVENT MOVEMENT DURING CONCRETE OR GROUT PLACEMENT.

STRUCTURAL NOTES

- 3. ALL WELDING SHALL BE DONE BY AWS CERTIFIED WELDERS. WELDING SHALL CONFORM TO THE PROVISIONS OF THE LATEST STRUCTURAL WELDING CODE (AWS D1.1). ALL WELDING SHALL BE PERFORMED IN ACCORDANCE WITH THE SUBMITTED WRITTEN PROCEDURES, USING ONLY THOSE JOINT DETAILS WHICH HAVE PREQUALIFIED STATUS WHEN PERFORMED IN ACCORDANCE WITH D1.1.
- 4. UNLESS NOTED OTHERWISE, ALL STRUCTURAL STEEL COMPONENTS AND CONNECTIONS SHALL BE PAINTED OR PROTECTIVE COATED IN ACCORDANCE WITH THE SPECIFICATIONS.
- 5. ALL CONNECTIONS SHALL BE WELDED OR BOLTED IN ACCORDANCE WITH THE DETAILS SPECIFICATIONS. AND THE NINTH EDITION OF THE AISC HANDBOOK OF FRAMED BEAM CONNECTIONS. BOLTS SHALL BE ASTM A325N, 3/4 INCH DIAMETER, UNLESS NOTED
- 6. IN A TIMELY MANNER, BEFORE CONSTRUCTION BEGINS, AN ANCHOR BOLT SETTING PLAN AND DETAILED PROCEDURE FOR THE INSTALLATION OF BASE PLATES AND SHEAR LUGS SHALL BE PREPARED BY THE CONTRACTOR AND SUBMITTED TO THE ENGINEER FOR REVIEW, ANCHOR BOLTS AND SHEAR LUGS EMBEDDED IN CONCRETE SHALL BE ACCURATELY POSITIONED WITH A TEMPLATE AND ADEQUATELY SECURED TO PREVENT MOVEMENT UNTIL
- 7. LISTED THICKNESS OF BASE PLATES IS NET FINISH AFTER MILLING. BASE PLATES MAY BE PRESSED FLAT AT FABRICATORS OPTION.
- 8. HOLES FOR ANCHOR BOLTS IN COLUMN BASE PLATES SHALL BE AS FOLLOWS:

BOLT 3/4" TO 1" - 5/16" OVERSIZE BOLT 1" TO 2" - 1/2" OVERSIZE BOLTS OVER 2" - 1" OVERSIZE

AT THE CONTRACTORS OPTION, OVERSIZE HOLES LARGER THAN THOSE LISTED ABOVE MAY BE USED, PROVIDED THAT 3/8" PLATE WASHERS ARE ALSO USED AND FIELD WELDED WITH A 5/16" FILLET TO THE BASE PLATE ALONG A MIN OF 3 SIDES.

FIBERGLASS REINFORCED PLASTICS (FRP)

- MATERIAL: PROVIDE CLASS 1 FIRE RESISTANT FRP MATERIAL PER ASTM E84. USE VINYL ESTER RESIN WITH UV RESISTANT VEIL FOR ALL SHAPES AND GRATING.
- AND MANUFACTURER'S RECOMMENDED ADHESIVE. MAKE CONNECTIONS OF FRP MEMBERS TO CONCRETE WITH STAINLESS STEEL ANCHORS.

SOIL AND FOUNDATIONS

- 1. ALL EARTHWORK AND FOUNDATION CONSTRUCTION SHALL BE IN ACCORDANCE WITH THE SPECIFICATIONS.
- 2. FOUNDATION CONSTRUCTION SHALL NOT BEGIN UNTIL THE SPECIAL INSPECTION HAS BEEN COMPLETED AND THE CONTRACTOR NOTIFIED TO PROCEED.
- 3. THE CONTRACTOR SHALL BE RESPONSIBLE FOR DESIGN, CONSTRUCTION, OPERATIONS, MAINTENANCE,

LOADING CRITERIA

1.	DEAD LOAD	CALCULATED
2.	LIVE LOADS:	
۷.	OPERATING AND PROCESS FLOORS	100 PSF (OUTSIDE MEMBRANE SKIDS)
	STAIRS, SERVICE PLATFORMS & LANDINGS	
	GRATING AREAS	
	ALL FLOORS NOT INDICATED	
		12 FSI (TON NOOF GINDENS)
3.	SOIL WEIGHT AND LATERAL EARTH PRESSURE (EFP)	
	ACTIVE PRESSURE:	
	LEVEL BACKFILL ABOVE MAX	45,005
	GROUNDWATER LEVEL (GWL)	45 PCF
	AT-REST PRESSURE:	
	LEVEL BACKFILL ABOVE GWL	65 PCF
	DESIGN SOIL UNIT WEIGHT	125 PCF
4.	LATERAL SURCHARGE	EQUIVALENT OF 2 FT OF SOIL (120 PSF UNIFORM PRESSURE) WHERE ADJACENT TO ROADWAY
5.	BEARING PRESSURE	
		FOR LOAD COMBINED W/WIND OR SEISMIC LOAD
6.	HYDROSTATIC FLUID PRESSURE	63 PSF/FT
7.	WIND LOAD:	
	OCCUPANCY CATEGORY	III
	BASIC WIND SPEED	
	EXPOSURE	
	IMPORTANCE FACTOR	1.15
8.	SEISMIC LOAD:	
	OCCUPANCY CATEGORY	III
	DESIGN CATEGORY	
	IMPORTANCE FACTOR (I)	1.25, Ip = 1.50 OR Ip = 1 (PER ASCE 7-05, 13.1.3)
	SITE CLASS	
	STRUCTURAL SYSTEM "R"	
		13.5-1, 13.6-1, 15.4-1 AND 15.4-2
	SEISMIC COEFFICIENT, SD1	
	SEISMIC COEFFICIENT, SDS	U.547 g

SPECIAL INSPECTIONS

- SPECIAL INSPECTION IN ACCORDANCE WITH 2007 CBC, CHAPTER 17 SHALL BE REQUIRED FOR THE FOLLOWING TYPES OF WORK BUT NOT LIMITED TO. CONTACTOR SHALL REQUEST THESE INSPECTIONS IN ACCORDANCE WITH THE CONTRACT DOCUMENTS.

 - A. CONCRETE (f'c GREATER THAN 2500 PSI)

 PLACING OF REINFORCING STEEL

 PLACING OF ANCHOR BOLTS OF EMBEDDED PLATES

 INSTALLATION OF MECHANICAL COUPLERS

 DURING THE TAKING OF TEST SPECIMENS & PLACING OF REINFORCED CONCRETE

 (SUBJECT TO THE EXCEPTIONS LISTED IN OSSCA, CHAPTER 17.)

 - B. WELDING
 ALL STRUCTURAL STEEL
 HEADED STUDS OR DOWELS FOR EMBEDDED PLATES
 - C. HIGH STRENGTH BOLTING

 - D. MASONY CONSTRUCTION

 D. MASONY CONSTRUCTION

 E. GRADING, EXCAVATION AND FILLING

 F. INSTALLATION OF EXPANSION ANCHORS, ADHESIVE ANCHORS AND EPOXY ANCHORS AS REQUIRED BY THE RESPECTIVE ICBO EVALUATION REPORT.

STRUCTURAL OBSERVATION

- 1. STRUCTURAL OBSERVATION DURING THE CONSTRUCTION PHASE SHALL BE PROVIDED IN ACCORDANCE
- OWNER SHALL ENGAGE THE ENGINEER-OF-RECORD (ER) OR ANOTHER ENGINEER DESIGNATED BY, AND UNDER THE DIRECT SUPERVISION OF, THE ER. TO PROVIDE STRUCTURAL OBSERVATION.
- 3. NOTIFY THE ER AT A MINIMUM 48 HOURS FOR A SITE VISIT TO CONDUCT THE OBSERVATION FOR THE
 - FOLLOWING CONSTRUCTION PHASES:
 A. AFTER PLACEMENT OF REINFORCING STEEL AND PRIOR TO CONCRETE PLACEMENT.
- 4. STRUCTURAL OBSERVATIONS ARE NOT TO BE CONSTRUED AS INSPECTION OF THE WORK. STRUCTURAL OBSERVATION BY THE ER DOES NOT RELIEVE THE CONTRACTOR'S RESPONSIBILITY FOR BUILDING THE PROJECT, CONTROLLING THE PROGRESS, PROVIDING SAFE WORKING CONDITIONS, AND CORRECTING ANY DEVIATIONS FROM PROJECT REQUIREMENTS.

PRELIMINARY - NOT FOR CONSTRUCTION





			REVISIONS				LINE IS 2 INCHES
	ZONE	REV.	DESCRIPTION	BY	DATE	APP.	AT FULL SIZE
		Α	50% SUBMITTAL		09/09		(IF NOT 2"-SCALE ACCORDINGLY)
FER		В	90% SUBMITTAL		11/09		FILE
		С	100% SUBMITTAL		01/10		DRAWN
*/							
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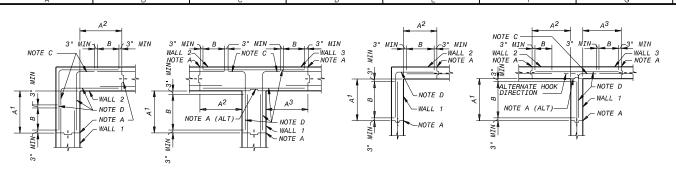
SACRAMENTO REGIONAL COUNTY SANITATION DISTRICT OF SACRAMENTO COUNTY, CALIFORNIA

SACRAMENTO REGIONAL WASTEWATER TREATMENT PLANT WATER RECLAMATION FACILITY EXPANSION PROJECT - PHASE II

STRUCTURAL GENERAL NOTES

DRAWING NUMBER SG000 SHEET NUMBER 27 OF 236

CONTRACT NUMBER



A = VERTICAL CONSTRUCTION JOINT NEAREST TO WALL CORNER.

A(ALT) = ALTERNATE VERTICAL CONSTRUCTION JOINT NEAREST TO WALL CORNER IN T WALL JOINT WHICH DOES NOT REQUIRE WATERSTOP.

AX (X=1 2 FTC) = DISTANCE FROM INSIDE CORNER FACE TO NEAREST VERTICAL CONSTRUCTION JOINT IN SIMILARLY NUMBERED WALL. AS SHALL NOT BE LESS THAN DIMENSIONS INDICATED BY THESE DETAILS; NOR GREATER THAN INDICATED ON PLAN DRAWINGS: BUT IN ANY CASE SHALL NOT EXCEED 30 FEET IN LIQUID CONTAINMENT STRUCTURES OR 40 FEET IN OTHER STRUCTURES. IN T WALL JOINTS WHICH DO NOT REQUIRE WATERSTOP, A1 MAY BE ZERO.

B = OPTIONAL SPLICE LOCATION UNLESS SPECIFICALLY NOTED ON PLAN DRAWINGS. SPLICE LENGTH SHALL NOT BE LESS THAN THAT REQUIRED FOR TOP BARS AS SHOWN IN TABLE ON THIS SHEET. USE SPLICE LENGTH FOR THE SMALLER OF THE TWO BARS BEING SPLICED.

D = TYPICAL CORNER REINFORCEMENT. SIZE SHALL MATCH LARGEST ADJACENT WALL HORIZONTAL REINFORCEMENT; SPACING SHALL MATCH MINIMUM ADJACENT WALL HORIZONTAL REINFORCEMENT SPACING.


MAIN REINFORCEMENT FOR ALL STRUCTURES

TYPICAL HORIZONTAL CORNER REINFORCING DETAILS

NOTES:

VERTICAL REINFORCING NOT SHOWN


THESE DETAILS SHALL BE APPLICABLE TO ALL WALL CORNERS UNLESS NOTED OTHERWISE ON THE DRAWINGS.

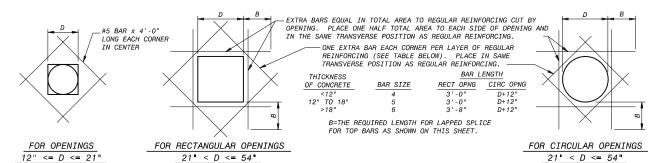

TYPICAL EXTRA REINFORCING AT OPENINGS 12" TO <= 54"

NOTES:
1. TYPICAL REQUIRED UNLESS ADDITIONAL REINFORCEMENT SPECIFICALLY INDICATED AT OPENINGS ON DRAWINGS.

2. FOR OPENINGS LARGER THAN 54" USE EXTRA REINFORCING BASED ON D=54".

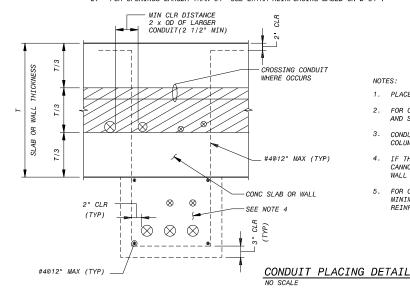

- 1. PLACE CONDUIT ONLY IN SHADED AREA
- 2. FOR CONDUIT REQUIREMENTS SEE THE ELECTRICAL DRAWINGS
- CONDUIT SHALL NOT BE PLACED IN BEAM OR COLUMN UNLESS APPROVED BY ENGINEER.
- IF THE SPACING REQUIREMENT BETWEEN CONDUITS AS SHOWN CANNOT BE MET WITHIN T/3. USE CONCRETE ENCASEMENT OUTSIDE WALL OR SLAB AS SHOWN BY DASHED LINES
- 5. FOR CONDUITS PENETRATING SLAB OR WALL, BLOCKOUT ONLY MINIMUM NECESSARY AREA OF SLAB OR WALL AND PROVIDE EXTRA REINFORCING AT THE BLOCKOUTS AS SHOWN ON THIS SHEET.


NOTE C WALL 3 WALL 2 WALL 2-NOTE E - NOTE E - WALL 1 - WALL 1

F = WHERE SPECIFICALLY NOTED ON THE DRAWINGS. ADDITIONAL E = WHERE SPECIFICALLY NOTED ON THE DRAWINGS, ADDITIONAL CONNER REINFORCEMENT SHALL BE PLACED IN BOTH FACES OF THE INDICATED CORNER OVER THE FULL HEIGHT. ADDITIONAL CORNER REINFORCEMENT SHALL BE OF THE SME SIZE AND SPACING AS THE MAIN CORNER REINFORCEMENT. PLACE ADDITIONAL REINFORCEMENT ALTERNATELY WITH, AND EQUAL DISTANCE BETWEEN, MAIN CORNER BETMEROGEMENT.

 E^{X} (X=1,2,ETC.) = DISTANCE FROM INSIDE CORNER FACE TO TERMINATION OF ADDITIONAL CORNER REINFORCEMENT IN SIMILARLY NUMBERED WALL. E SHALL NOT BE LESS THAN 0.20 THE CLEAR SPAN DISTANCE MEASURED HORIZONTALLY BETWEEN THIS CORNER AND THE NEXT OR 0.40 THE CLEAR SPAN DISTANCE OR CANTILEVERED DISTANCE MEASURED VERTICALLY, WHICHEVER IS SMALLER, BUT NOT LESS THAN

CONTRACTORS OPTION: E BAR TAILS MAY BE SPLICED USING LAPPED SPLICE LENGTHS FOR TOP BARS. SPLICES SHALL NOT BE LOCATED IN THE CORNER AREA COMMON TO BOTH WALLS AND SHALL CLEAR HOOK ENDS BY 3" MIN.

ADDITIONAL REINFORCEMENT WHERE SPECIFICALLY NOTED ON THE DRAWINGS

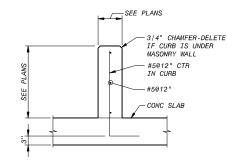



WHEN CURB WIDTH EXCEEDS 8", PROVIDE ABOVE REINF IN EACH FACE OF CURB.

TYPICAL CONCRETE CURB (c)

NOTES

- 1. DETAILS ON THIS DRAWING APPLY TO ALL DRAWINGS UNLESS OTHERWISE NOTED. 2. WORK THIS DRAWING WITH THE STANDARD CONCRETE JOINT DETAILS.
- 3. UNLESS SHOWN OTHERWISE, ALL DOWELS SHALL MATCH SIZE AND SPACING OF REBARS TO BE SPLICED TO AND HAVE 90 DEG HOOK LOCATED AT FAR SIDE OF INTERSECTING MEMBERS WITH PROPER CONCRETE COVER.

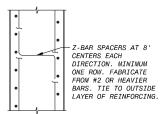

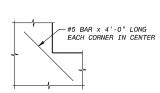


SPACERS FOR WALL REINFORCEMENT

SPLICED IN HORIZONTAL PAIRS —

TYPICAL EXTRA REINFORCING AT ISOLATED RE-ENTRANT CORNERS

(TYPICAL REQUIRED UNLESS ADDITIONAL REINFORCEMENT SPECIFICALLY INDICATED AT OPENINGS ON DRAWINGS)

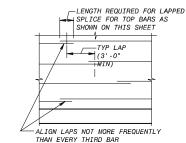

WALL SECTION

WALL ELEVATION

TYPICAL CIRCULAR TANK OR RING WALL REINFORCING SPLICE DETAIL

LENGTH OF LAPPED SPLICES FOR REINFORCEMENT (INCHES) (UNLESS NOTED OTHERWISE ON THE DRAWINGS)						CONCRETE COVER FOR REINFORCEMENT					
(f'c=4000 PSI)						LOCATION	MINIMUM COVER				
545	BEAMS & COLUMNS WALLS & SLABS				UNFORMED SURFACES ADJACENT TO EXCAVATION SURFACES INSIDE OF OZONE CONTACTORS EXPOSED TO	3"					
BAR SIZE	*TOP BARS	OTHERS	*TOP BARS	OTHERS	BAR SIZE	OZONE IN WATER OR AIR FORMED OR TOP SURFACES EXPOSED TO WEATHER OR SATURATED AIR, SUBMERGED OR IN CONTACT WITH EARTH,	3" 2"				
3	16	16	16	16	3	INCLUDING STIRRUPS, TIES OR SPIRALS					
4	20	16	20	16	4	OTHER LOCATIONS:					
5	26	20	29	22	5	BARS IN BEAMS OR GIRDERS, INCLUDING STIRRUPS	1 1/2"				
6	37	29	29	23	6	AND COLUMN SPIRALS OR TIES					
7	60	47	48	37	7	0/450 #4//0 4//0 #57070 #6 4//0 / 45070	1 1/2"				
8	70	54	60	47	8	SLABS, WALLS AND JOISTS #6 AND LARGER #5 AND SMALLER	1' 1/2				
9	80	62	74	57	9	NOTE:	,				
10	92	70	91	70	10	TOLERANCES FOR CONCRETE COVER AND THE FABRICATION A	ND				
11	103	79	109	84	11	PLACING OF REINFORCEMENT SHALL CONFORM TO ACI 117.					

- TOP BARS ARE HORIZONTAL BARS SO PLACED THAT MORE THAN 12" OF CONCRETE IS CAST IN THE MEMBER BELOW THE BAR HORIZONTAL BARS IN WALLS ARE TO BE PROVIDED WITH LAP LENGTHS AS REQUIRED FOR TOP BARS. VERTICAL BARS MAY BE CONSIDERED AS OTHER BARS.
- WHERE DIFFERENT BARS ARE TO BE LAP-SPLICED, LAPPED SPLICE LENGTH SHALL BE BASED ON LARGER BAR

CONTRACT NUMBER

PRELIMINARY - NOT FOR CONSTRUCTION



REVISIONS BY DATE DESCRIPTION A 50% SUBMITTAL B 90% SUBMITTAL 00% SUBMITTAL

LINE IS 2 INCHES AT FULL SIZE (IF NOT 2"-SCALE ACCORDINGLY) DRAWN DESIGNED CHECKED .


SANITATION DISTRICT OF SACRAMENTO COUNTY, CALIFORNIA SACRAMENTO REGIONAL WASTEWATER TREATMENT PLANT WATER RECLAMATION FACILITY

SACRAMENTO REGIONAL COUNTY

EXPANSION PROJECT - PHASE II

STRUCTURAL STANDARD CONCRETE REINFORCING DETAILS

AS SHOWN DRAWING NUMBER SG500 SHEET NUMBER 28 OF 236

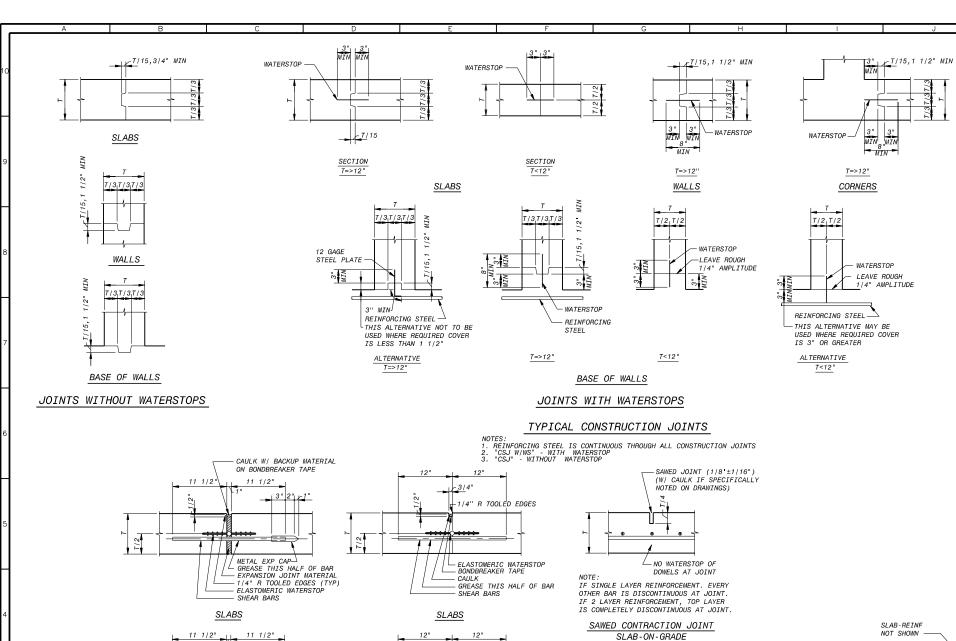

3/4" CHAMFER (TYP)

WALLS

TYPICAL CONTROL JOINTS

OTES:
PROVIDE 3/4" SHEAR BARS & 1'-6" CTRS ACROSS JOINT UNLESS NOTED OTHERWISE

BOND (ONE HALF OF BAR ONLY).

2. REINFORGING STEEL SHALL NOT BE EXTENDED ACROSS JOINT UNLESS NOTED OTHERWISE.
3. SHEAR BARS SHALL BE SMOOTH FREE FROM RUST OR SCALE, AND GREASED TO PREVENT

- BONDBREAKER TAPE - CAULK ALL EXPOSED FACES - ELASTOMERIC WATERSTOP - GREASE THIS HALF OF BAR - SHEAR BARS

CONTRACTION JOINTS

"CJ" W/ WS" - WITH ELASTOMERIC WATERSTOP



STEEL WATERSTOP INTERSECTION AT BASE SLAB CONSTRUCTION JOINT

NOTES

DETAILS ON THIS DRAWING APPLY TO ALL DRAWINGS UNLESS

2. WORK THIS DRAWING WITH THE STANDARD CONCRETE REINFORCING

AT WALL JOINTS AND AT WALL BASE JOINTS, SECURE ALL ELASTOMERIC WATERSTOPS IN THE CORRECT POSITION USING HOG RINGS OR GROMMETS SPACED AT 12 INCHES ALONG THE LENGTH OF

THE WATERSTOP AND WIRE TIE TO ADJACENT REINFORCING STEEL.

4. AT SLAB JOINTS AND FOOTING JOINTS, ENSURE SPACE BENEATH AND AROUND WATERSTOP IS COMPLETELY FILLED WITH CONSOLIDATED CONCRETE DURING OPERATION MAKE VISUAL INSPECTION OF ENTIRE WATERSTOP AREA. LIMIT CONCRETE PLACEMENT TO ELEVATION OF

WATERSTOP IN FIRST LIFT. RAISE ELASTOMERIC WATERSTOPS TO CONFIRM FULL CONSOLIDATION WITHOUT VOIDS. PLACE REMAINING

EXTEND SUFFICIENT FOR SPLICE

WATERSTOP AT SLAB JT

SECURELY BOLT, SCREW OR SPOT WELD

- WATERSTOP FOR WALL


- KEYWAY FOR WALL

CONCRETE TO FULL DEPTH OF SLAB.

OTHERWISE NOTED.

WATERSTOP FOR WALL-ADDITIONAL PIECE OF WATERSTOP

WATERSTOP AT SLAB JT -

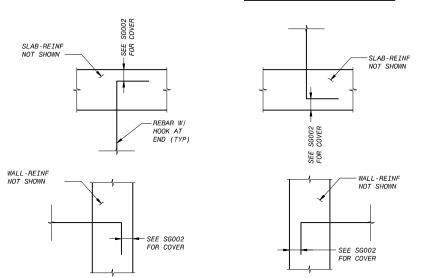

NOTE: ALL REINFORCING BARS WITH HOOK AT END SHALL TERMINATE AT FAR SIDE OF SLAB OR WALL AS SHOWN IN THIS DETAIL UNLESS NOTED OTHERWISE.

SACRAMENTO REGIONAL COUNTY

SANITATION DISTRICT

EXPANSION PROJECT - PHASE II

TERMINATION LOCATION OF REBARS W/ HOOK

CONTRACT NUMBER

PRELIMINARY - NOT FOR CONSTRUCTION



(TYP)

METAL EXP CAP -- GREASE THIS HALF OF BAR

CAULK W/ BACKUP MATERIAL ON BONDBREAKER TAPE; ALL EXPOSED FACES

EXPANSION JOINT MATERIAL

ELASTOMERIC WATERSTOP

-SHEAR BARS

<u>WALLS</u> EXPANSION JOINTS

"EJ" W/ WS" - WITH ELASTOMERIC WATERSTOP
"EJ" - WITHOUT ELASTOMERIC WATERSTOP

			REVISIONS				LINE IS 2 INCHES
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1. TYPICAL CONTROL JOINT NOTES 1 THRU 3 NOT APPLICABLE. 2. "SJ" - NO WATERSTOP 3. JOINT FORMED WITH TOOL OR INSERT STRIP MAY BE SUBSTITUTED FOR SAWED TYPE ONLY WITH PRIOR ACCEPTANCE BY THE ENGINEER.

OF SACRAMENTO COUNTY, CALIFORNIA

SACRAMENTO REGIONAL

WASTEWATER TREATMENT PLANT

WATER RECLAMATION FACILITY

STRUCTURAL
STANDARD CONCRETE JOINT DETAILS


NONE

DRAWING NUMBER

SG501

SHEET NUMBER

29 OF 236

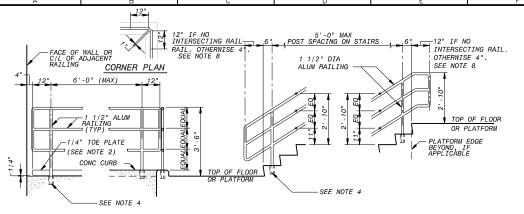


END TERMINATION AND CORNER ELEVATION

STAIR RAILING ELEVATION

1. CONCRETE CURB OR TOE PLATE IS REQUIRED FOR ALL GUARDRAILS WHETHER IT IS SHOWN OR NOT ON SPECIFIC SECTION OR


2. TOE PLATE SHALL BE USED AT GRATED PLATFORM AREAS.

THREE RAIL TYPE

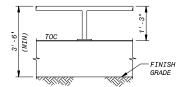

NOTE: FOR DETAILS REFER TO THREE RAIL TYPE




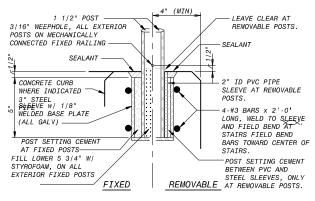


NOTES:

1. FIXED AND REMOVABLE DETAILS SIMILAR EXCEPT AS NOTED.


2. PROVIDE 1/4" STEEL THREAD PL COVER FOR EACH REMOVABLE HANDRAIL POST ANCHORAGE.

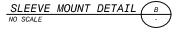

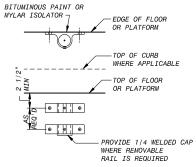

THOMPSON CAST ALLIMINUM BRACKET TYPE A (#TSM-1.50), OR ACCEPTABLE EQUAL; W/ 4-1/2" SS EXPANSION OR ADHESIVE ANCHORS.

ALUMINUM RAILING

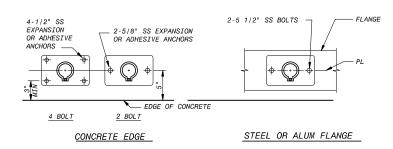

THOMPSON CAST ALUMINUM BASE FLANGE TYPE B (#TBF-3.4 FOR 4 BOLTS, #TBF-3.2 FOR 2 BOLTS), OR ACCEPTABLE EQUAL.

THOMPSON CAST ALUMINUM BASE FLANGE TYPE FOR G B (#TBF-2.4 OR #ABF-1) FOR 2 BOLTS, OR ACCEPTABLE EQUAL.

ALUMINUM RAILING

BASE FLANGE MOUNT (D

SIDE MOUNT DETAIL C

NOTES FOR RAILING:

- 1. ALL RAILING SHALL BE THREE RAIL TYPE UNLESS INDICATED OTHERWISE ON THE DESIGN DRAWINGS. RAILING MATERIAL AND FABRICATION SHALL BE AS INDICATED ON THE DESIGN DRAWINGS AND IN THE PROJECT SPECIFICATIONS FOR HANDRAILING AND GUARDRAILING.
- 2. GUARDRAILING SHALL BE DESIGNED TO WITHSTAND LOADING AS SPECIFIED IN SECTION 05520.
- GUARDRAILING AND HANDRAILING SHALL BE DESIGNED AND FABRICATED IN CONFIGURATIONS REQUIRED TO FIT THE LOCATIONS INDICATED ON THE DESIGN DRAWINGS. CONTRACTOR SHALL VERIFY FINAL
- 4. REMOVABLE RAILING AT LOCATIONS SPECIFICALLY INDICATED AS REMOVABLE RAILING, GUARDRAILING,

AND MOUNTING DETAILS SHALL BE MODIFIED AS FOLLOWS:

-RAILING SHALL BE DETAILED IN SHORT LENGTHS THAT CAN BE LIFTED BY A PERSON. EACH REMOVABLE PIECE SHALL INCLUDE AT LEAST TWO, BUT NOT MORE THAN THREE POSTS. RAIL ENDS SHALL BE TERMINATED SIMILAR TO THE END TERMINATION DETAILS ON THIS SHEET.

-MOUNTING DETAILS SHALL BE MODIFIED TO PERMIT RAILING PIECES TO BE REMOVED AND REINSTALLED WITHOUT USE OF TOOLS.

-REMOVABLE RAILING IN CONCRETE SHALL UTILIZE SLEEVE MOUNTS PER DETAIL C, THIS SHEET.

- 5. ALUMINUM RAILING ON GALVANIZED STEEL STAIR STRINGERS SHALL BE ATTACHED TO THE STRINGER FLANGE WITH A SKEWED BASE FLANGE MOUNT AND STAINLESS STEEL BOLTS.
- NOT USED.
- THE INBOARD RAILING AT SWITCHBACK STAIR LANDING MUST BE CONTINUOUS FROM ONE STAIR RUN TO THE NEXT. ADJUST DIMENSIONS AS REQUIRED TO CONNECT RAILINGS.

PRELIMINARY - NOT FOR CONSTRUCTION



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							CHECKED _	

OF SACRAMENTO COUNTY, CALIFORNIA SACRAMENTO REGIONAL WASTEWATER TREATMENT PLANT WATER RECLAMATION FACILITY

EXPANSION PROJECT - PHASE II

CONTRACT NUMBER


SACRAMENTO REGIONAL COUNTY


SANITATION DISTRICT

STANDARD MISCELLANEOUS DETAILS

STRUCTURAL

NONE DRAWING NUMBER SG502 SHEET NUMBER 30 OF 236

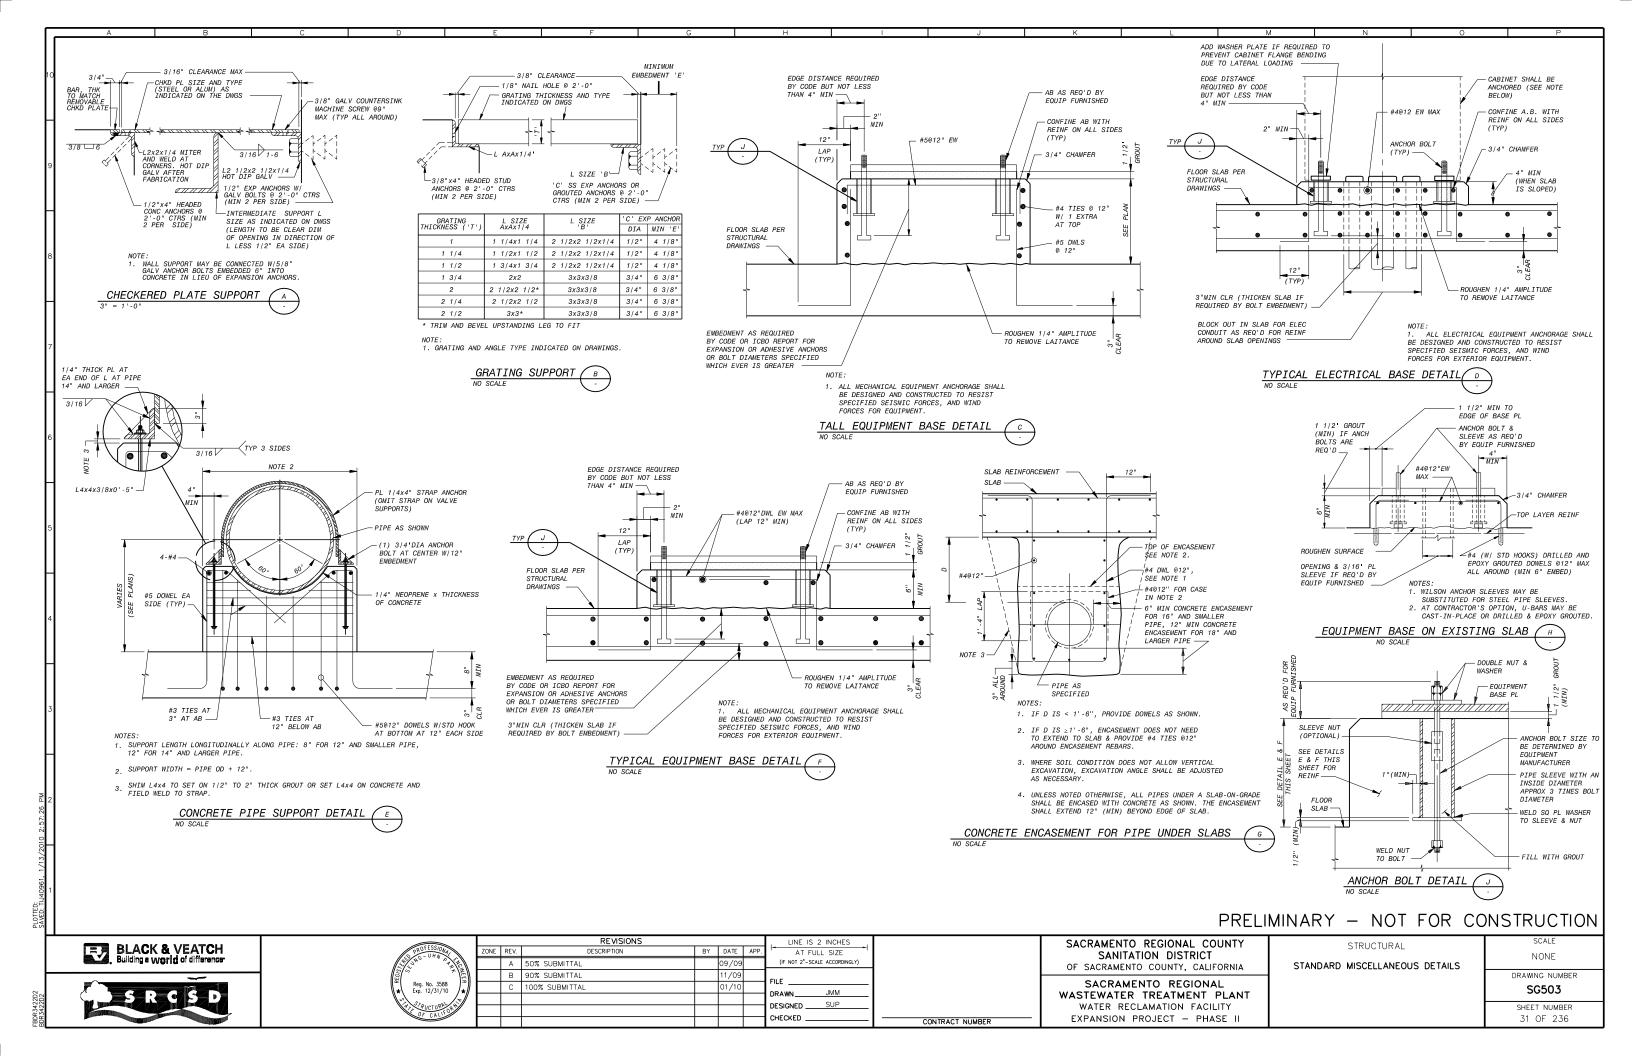

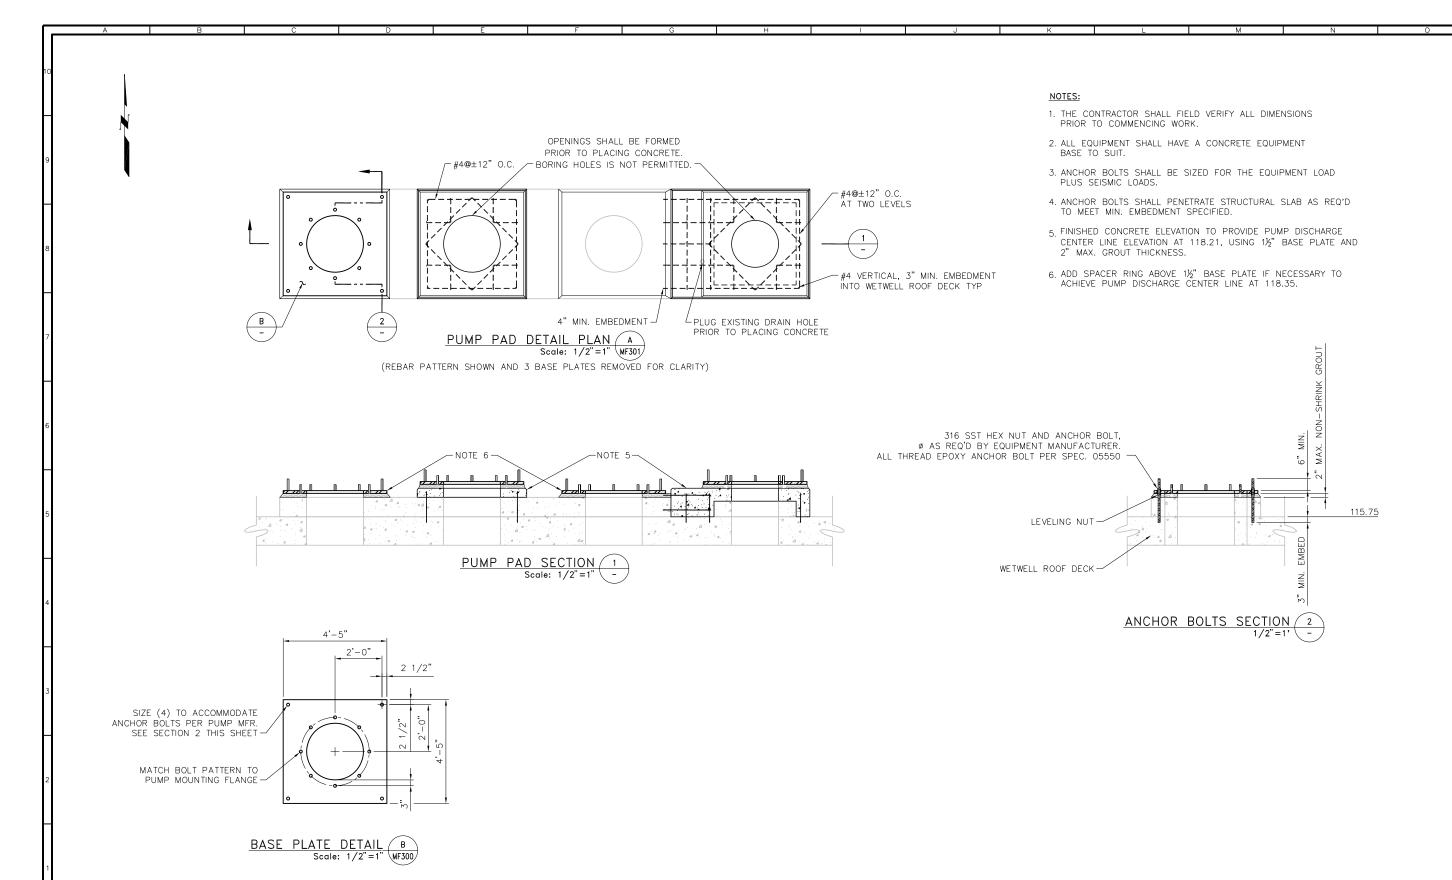

PRELIMINARY - NOT FOR CONSTRUCTION









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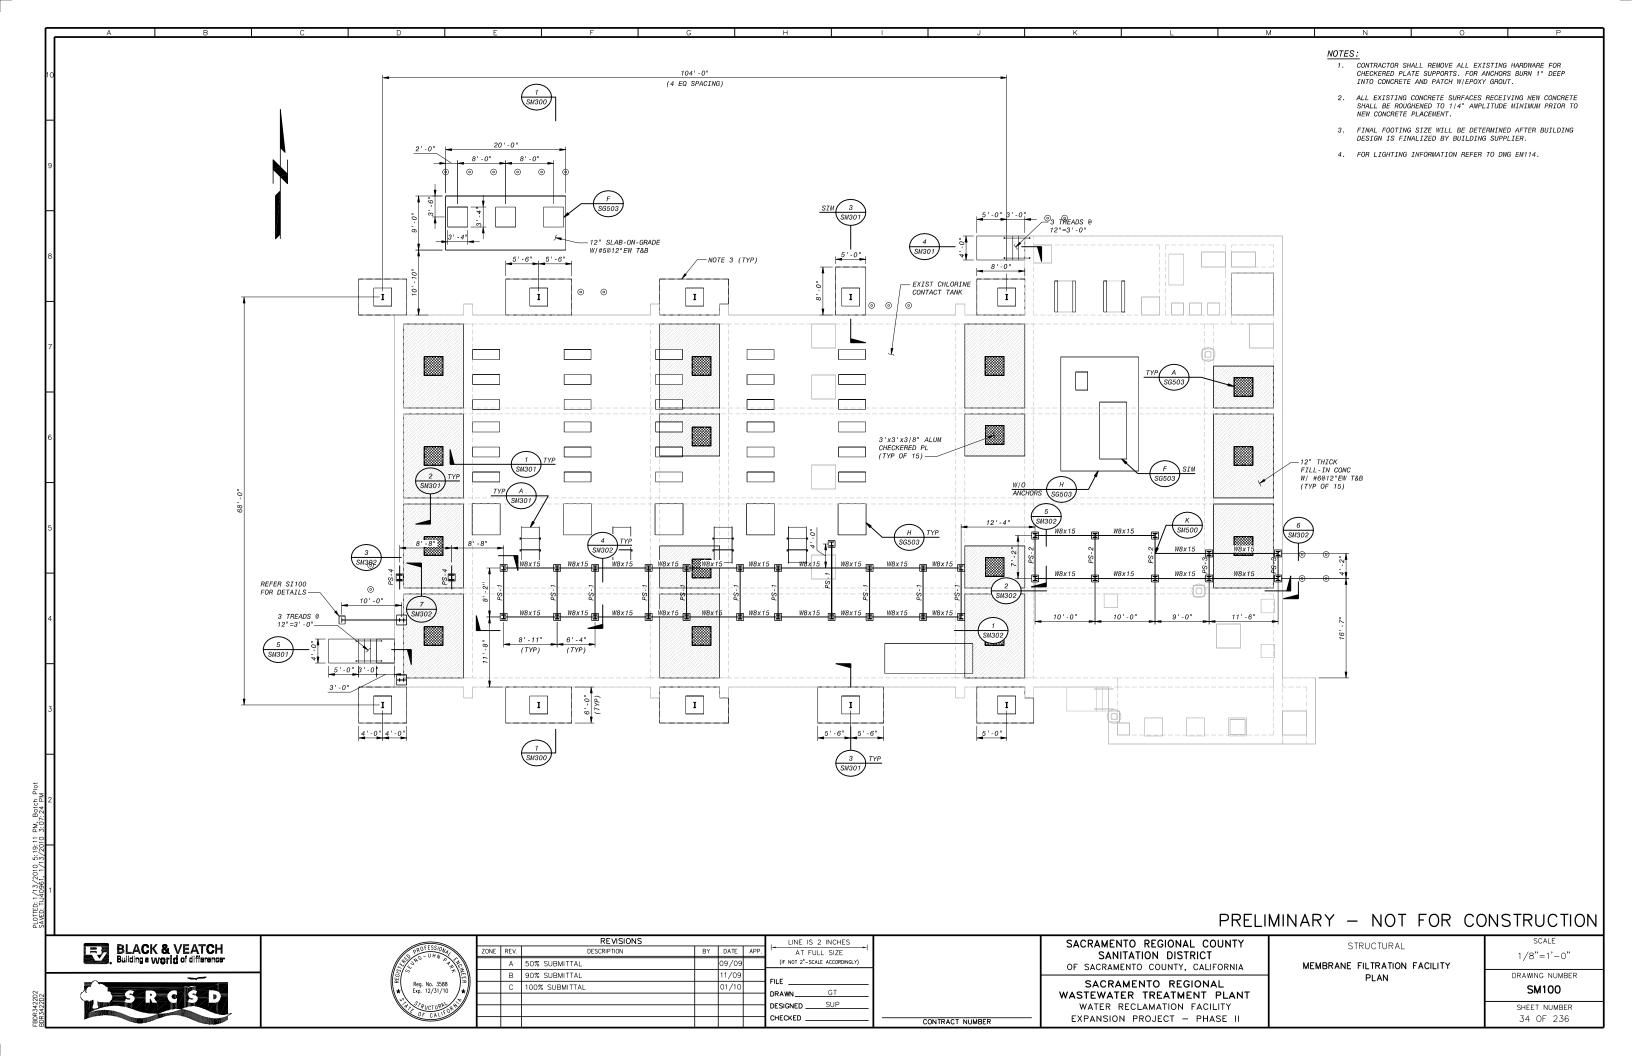
TBD CONTRACT NUMBER SACRAMENTO REGIONAL COUNTY SANITATION DISTRICT OF SACRAMENTO COUNTY, CALIFORNIA


SACRAMENTO REGIONAL WASTEWATER TREATMENT PLANT STRUCTURAL


FILTER FEED PUMP STATION CONCRETE BASE SECTION


1/2" = 1'DRAWING NUMBER SF300


SHEET NUMBER 33 OF 236




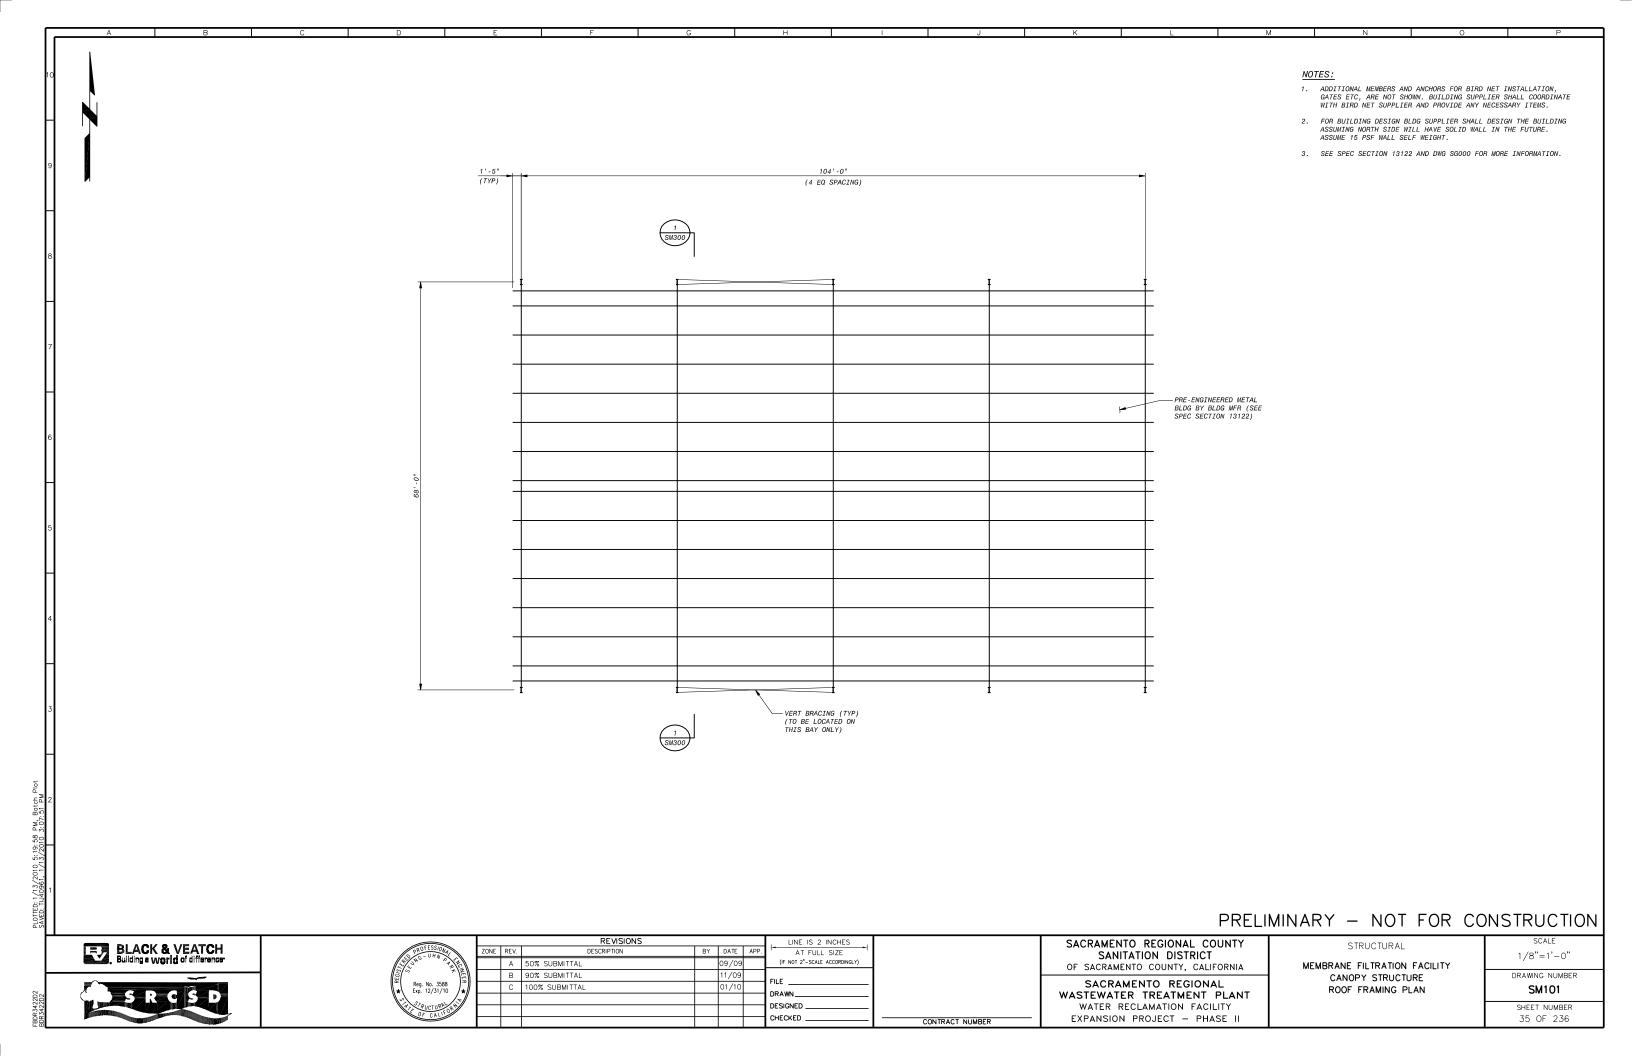

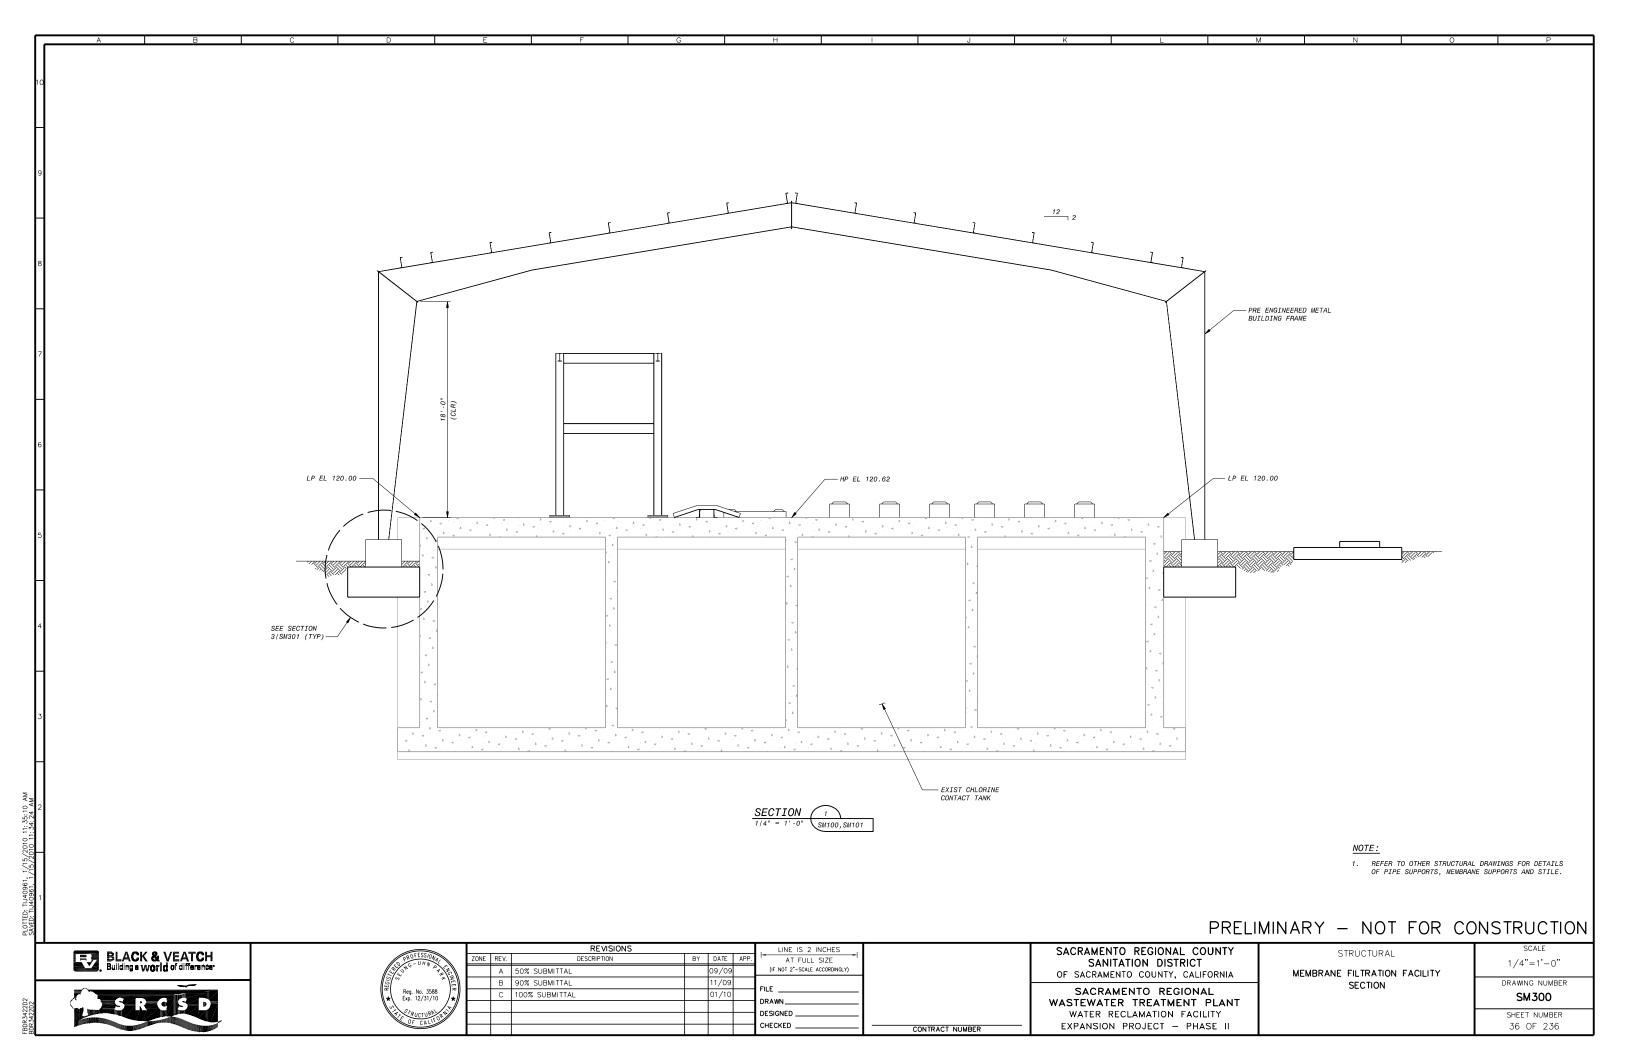

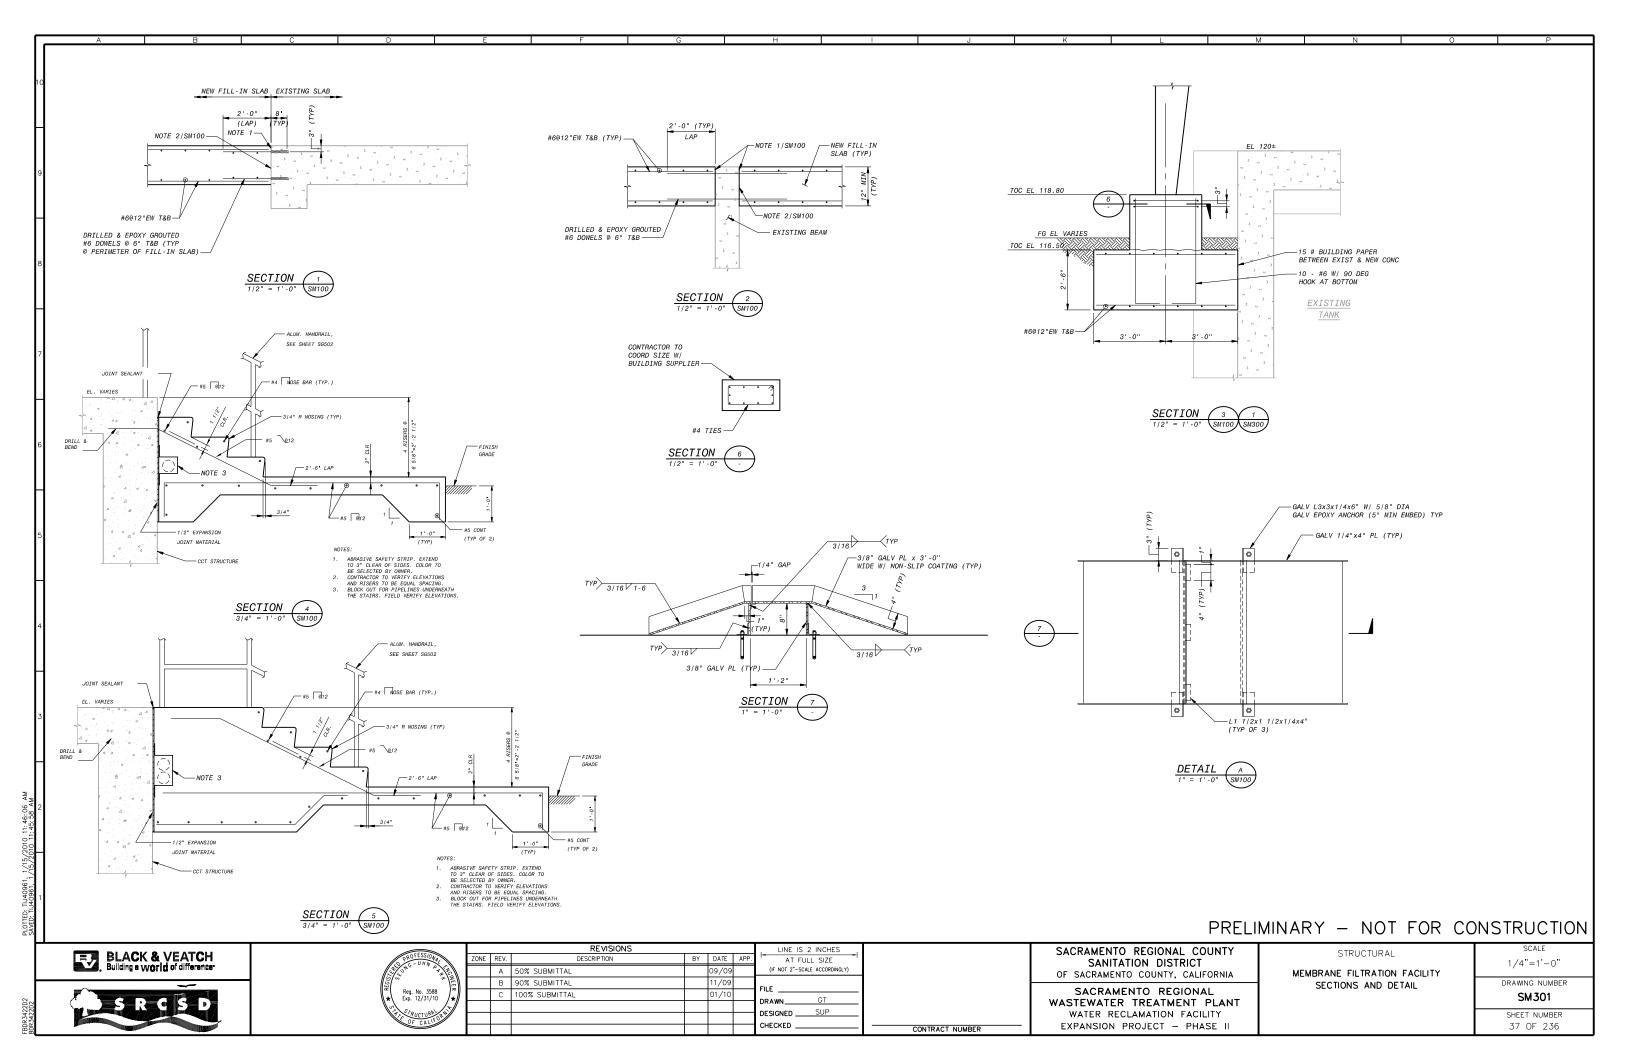

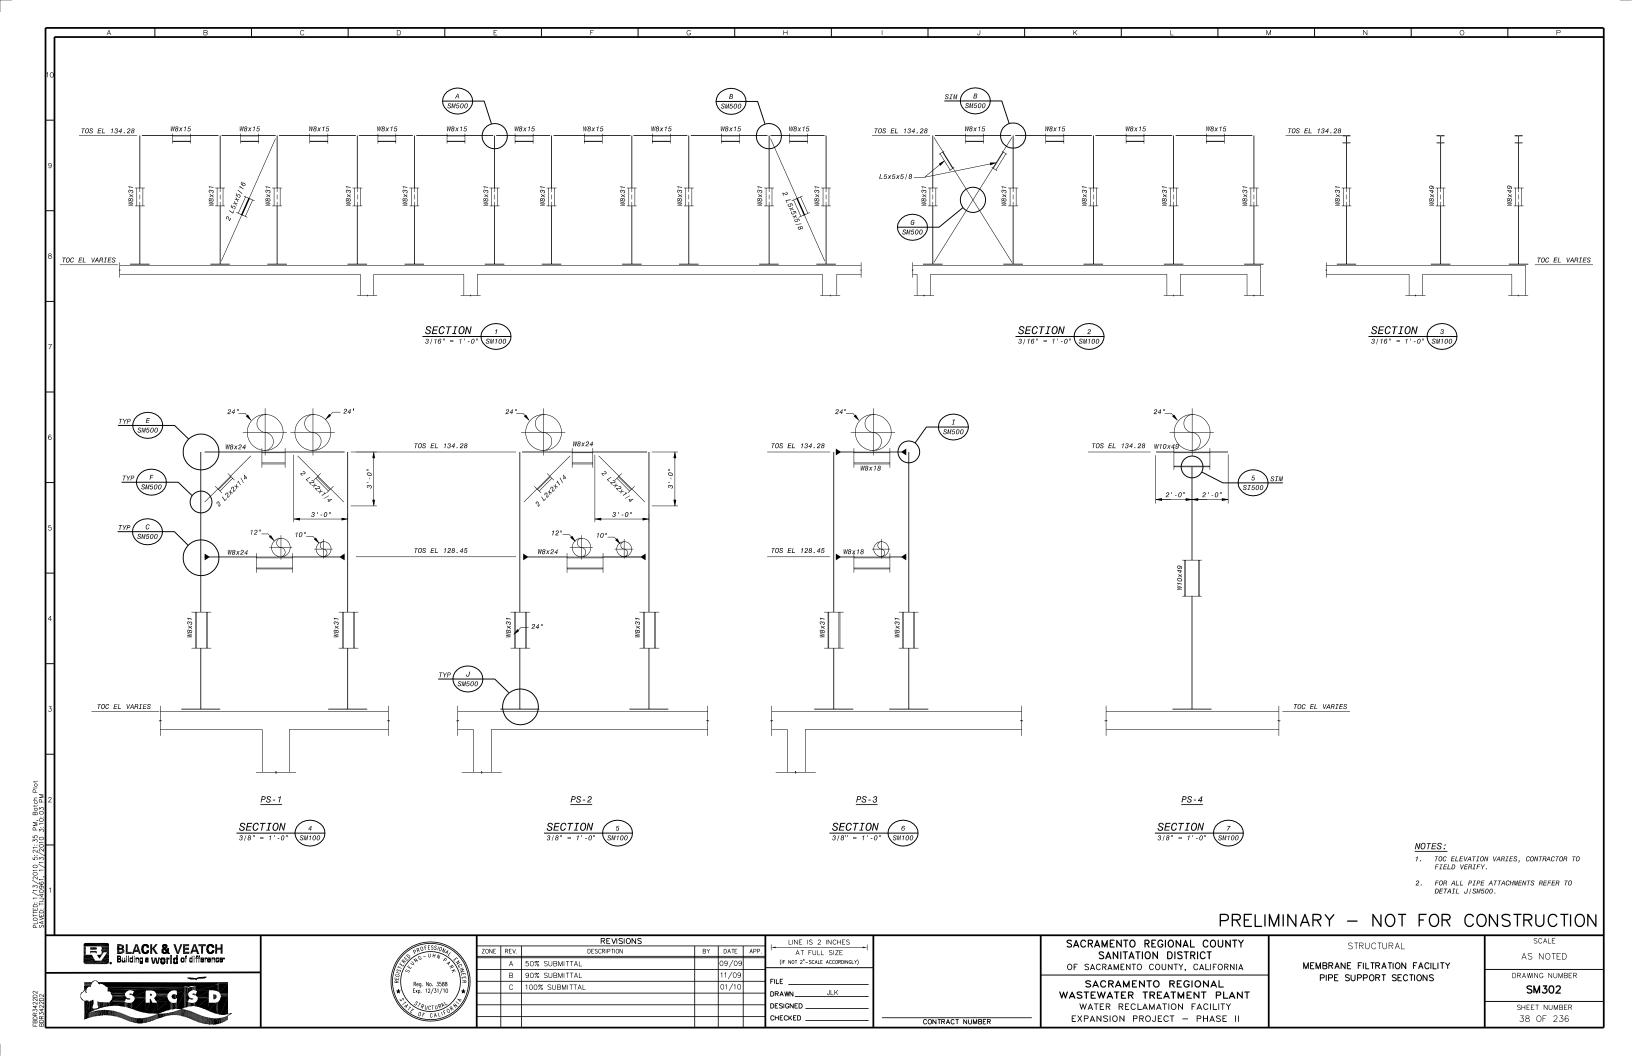

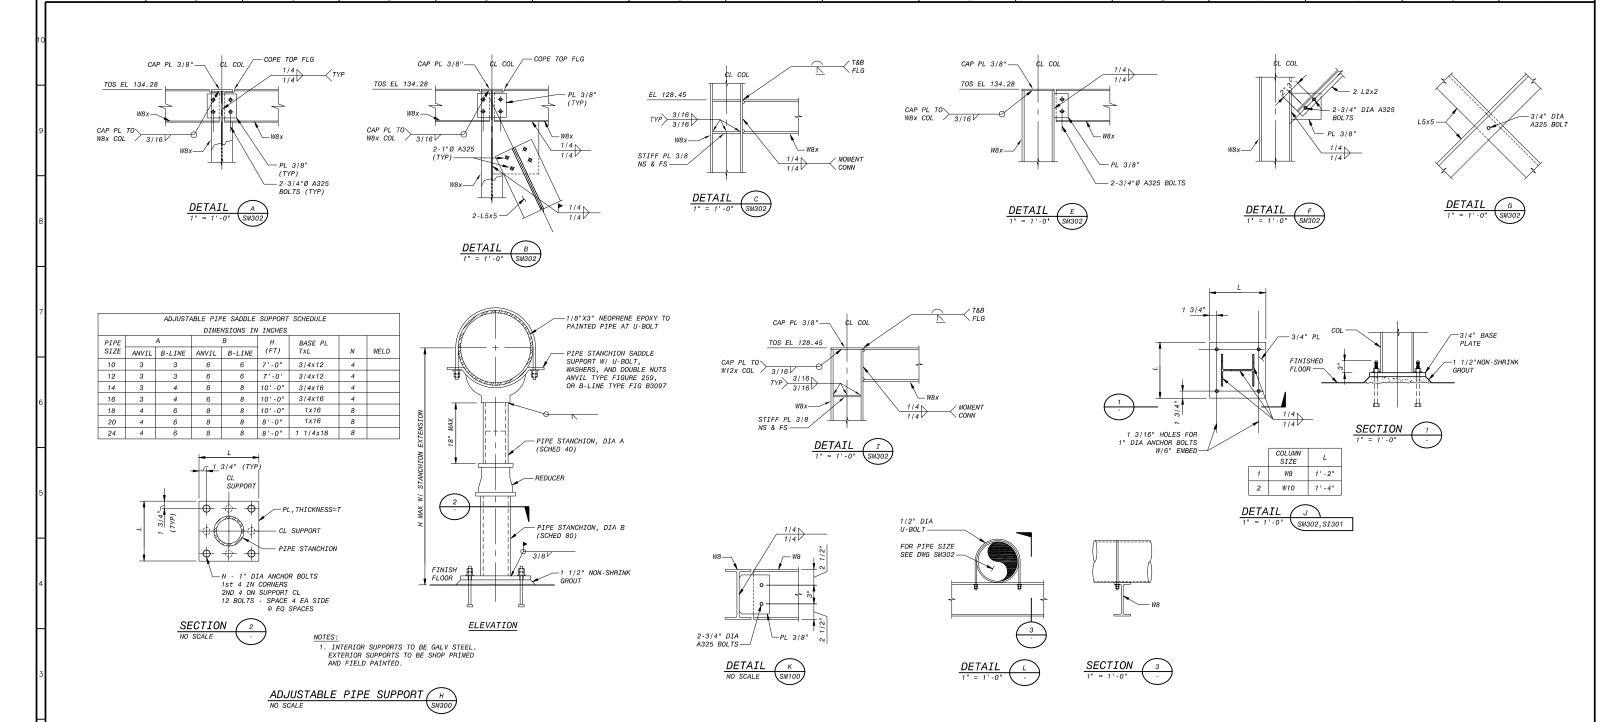

PRELIMINARY - NOT FOR CONSTRUCTION



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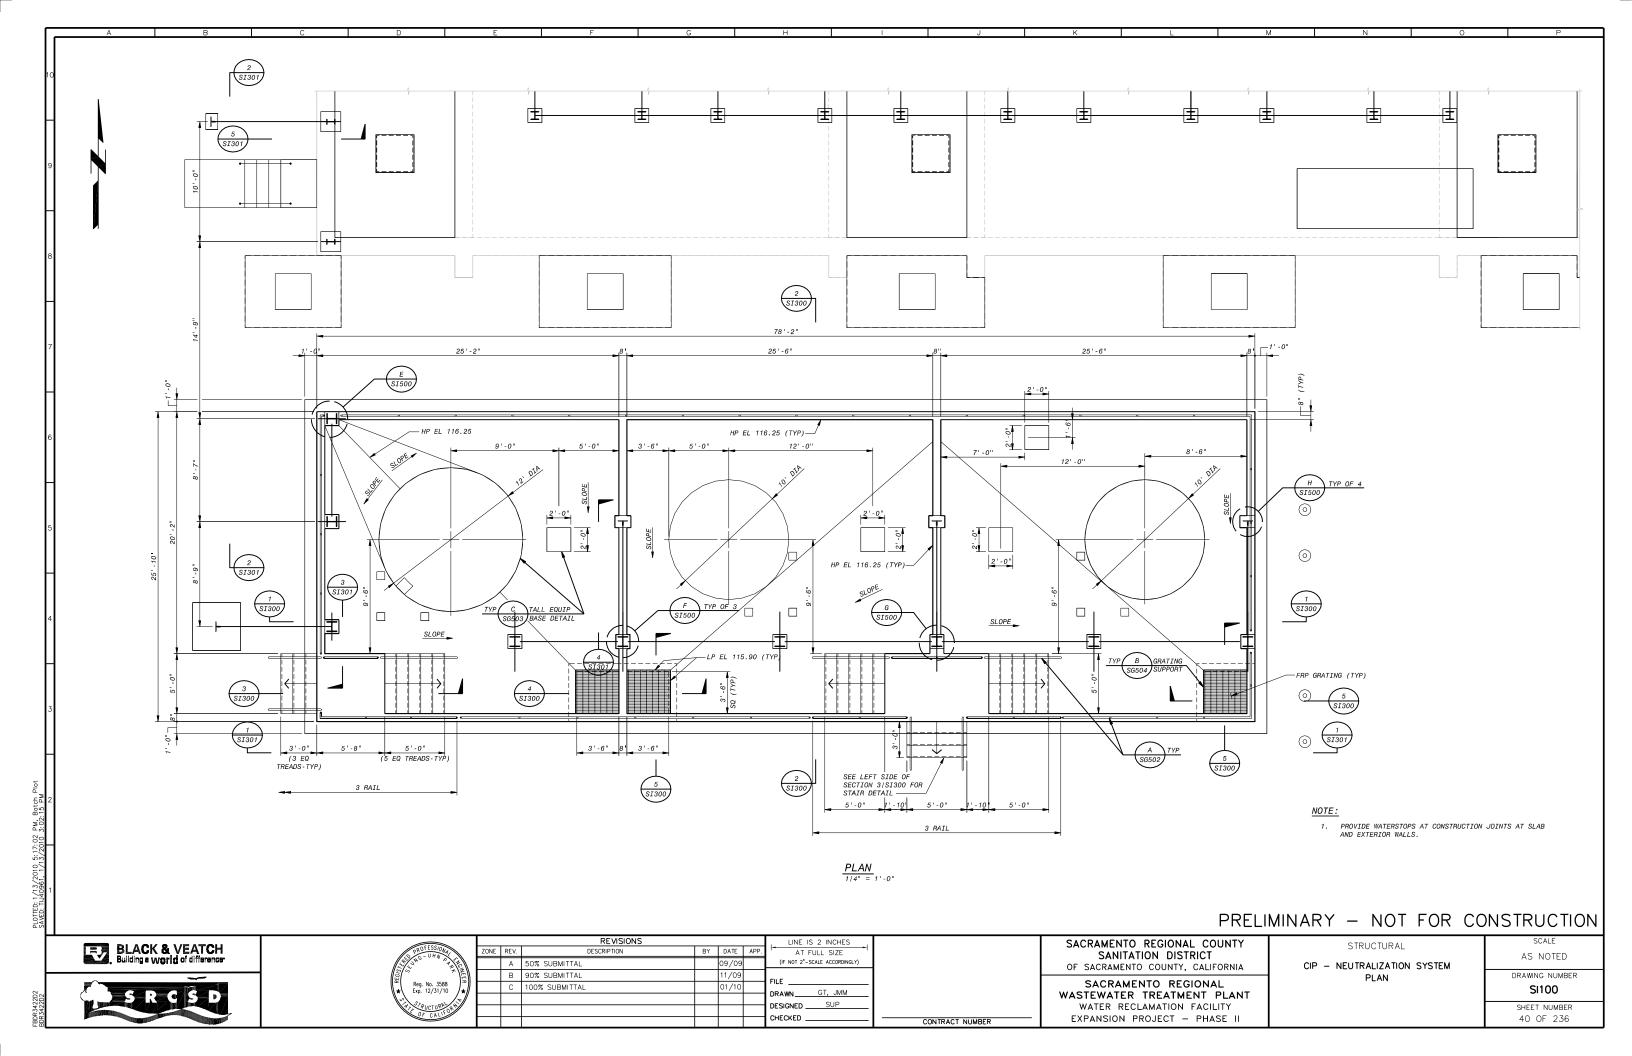
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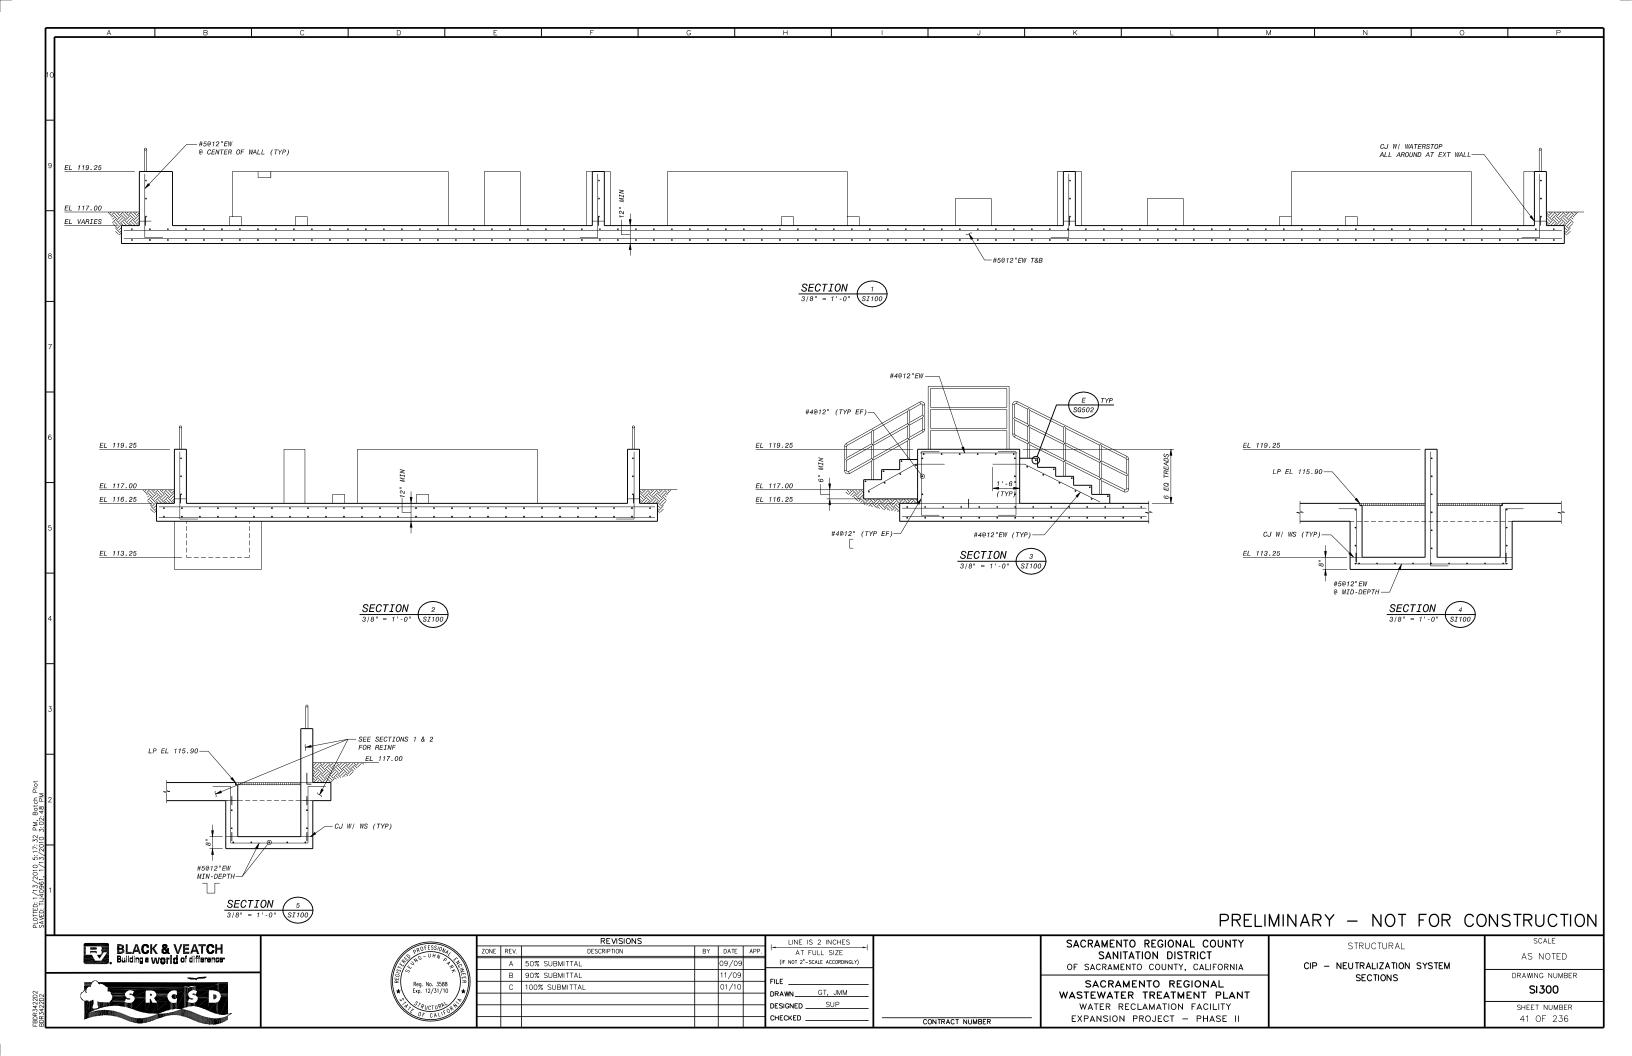
SACRAMENTO REGIONAL COUNTY SANITATION DISTRICT OF SACRAMENTO COUNTY, CALIFORNIA


SACRAMENTO REGIONAL WASTEWATER TREATMENT PLANT WATER RECLAMATION FACILITY EXPANSION PROJECT - PHASE II


STRUCTURAL MEMBRANE FILTRATOION FACILITY PIPE SUPPORT DETAILS

AS NOTED DRAWING NUMBER SM500 SHEET NUMBER 39 OF 236





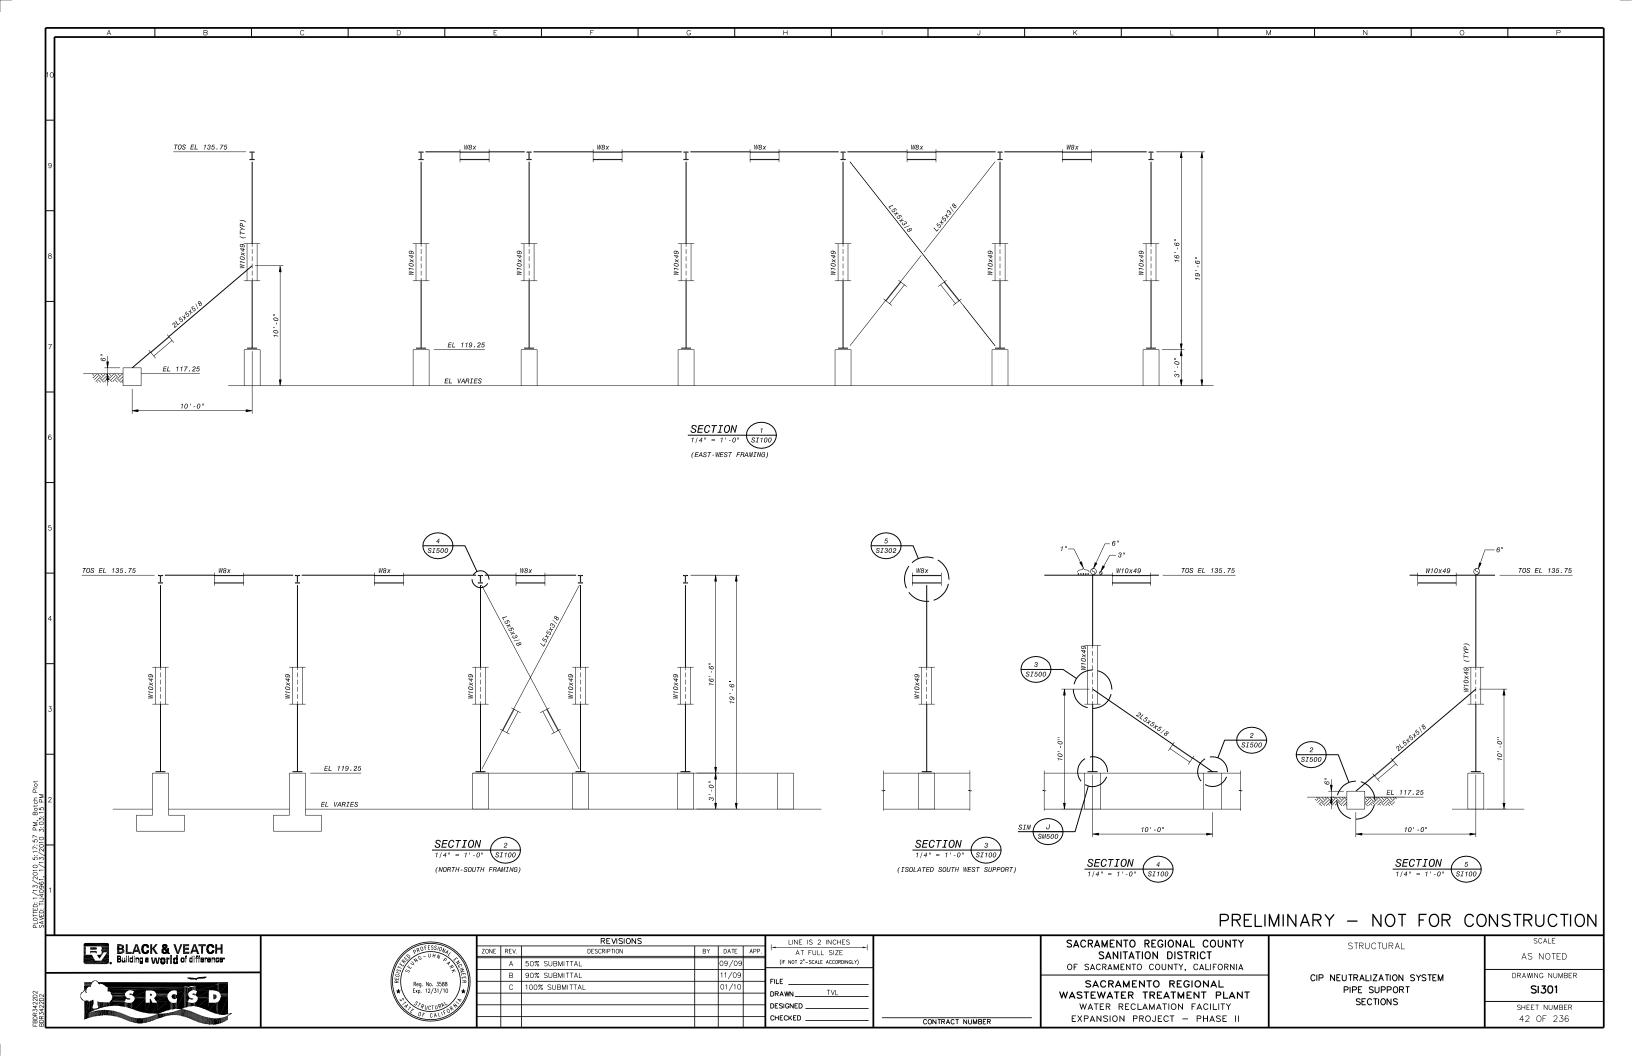

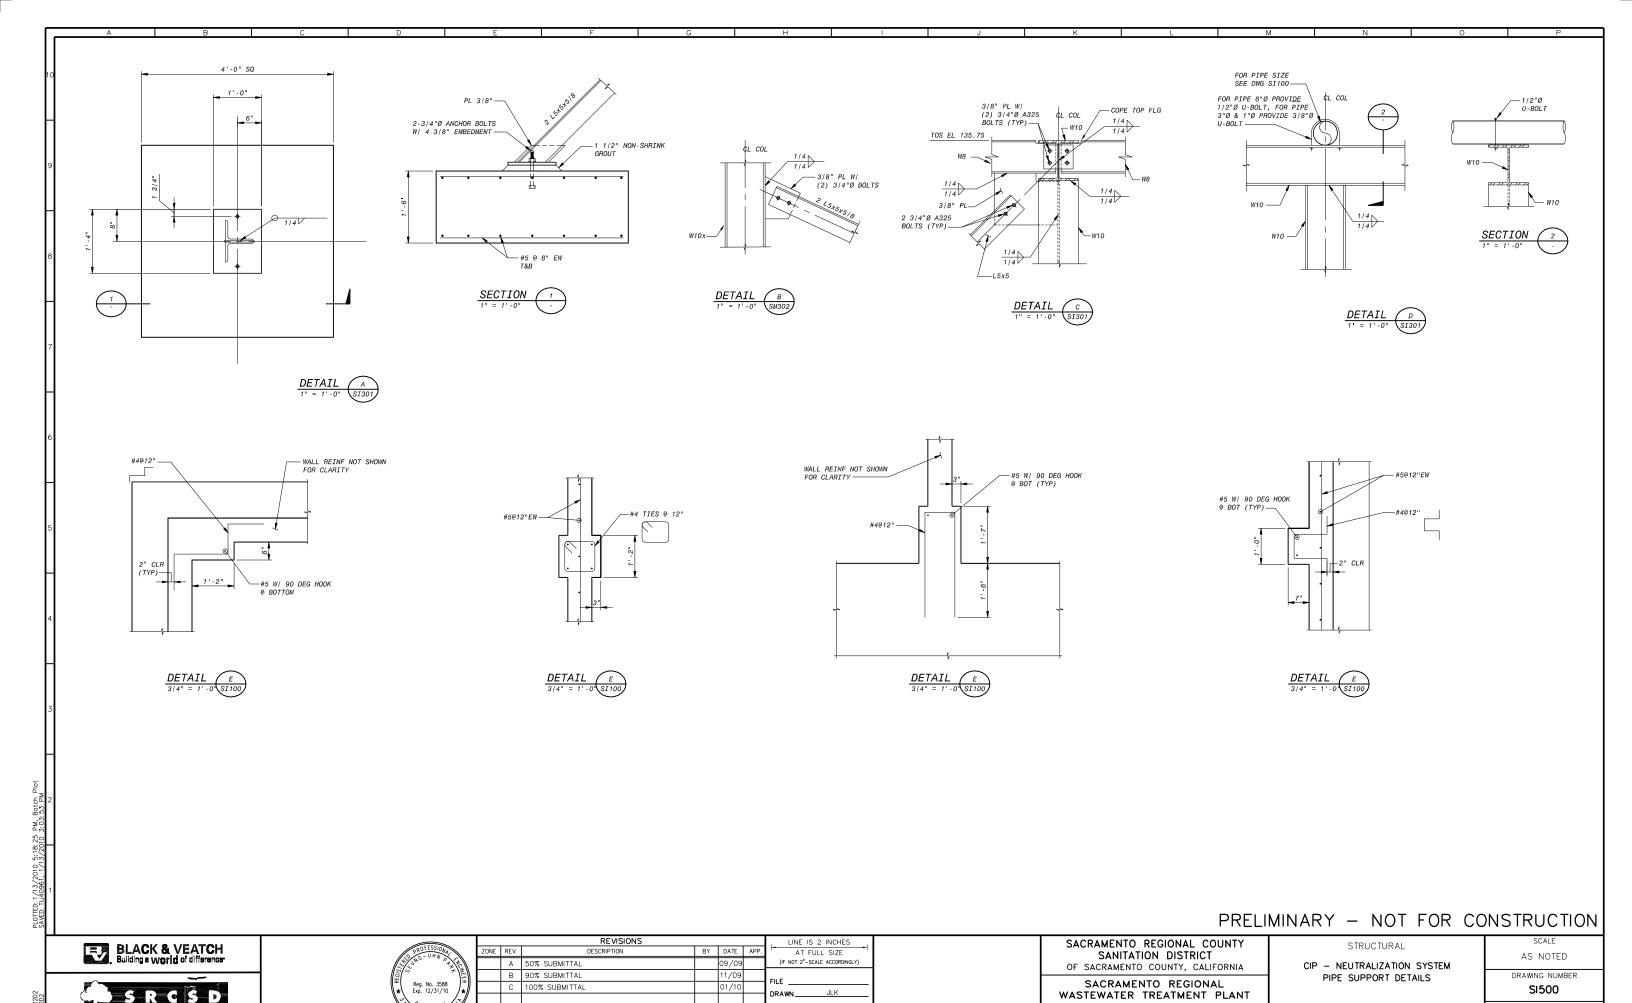

DRAWN_ DESIGNED .

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CONTRACT NUMBER

WATER RECLAMATION FACILITY


EXPANSION PROJECT - PHASE II


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SHEET NUMBER

43 OF 236

100% SUBMITTAL




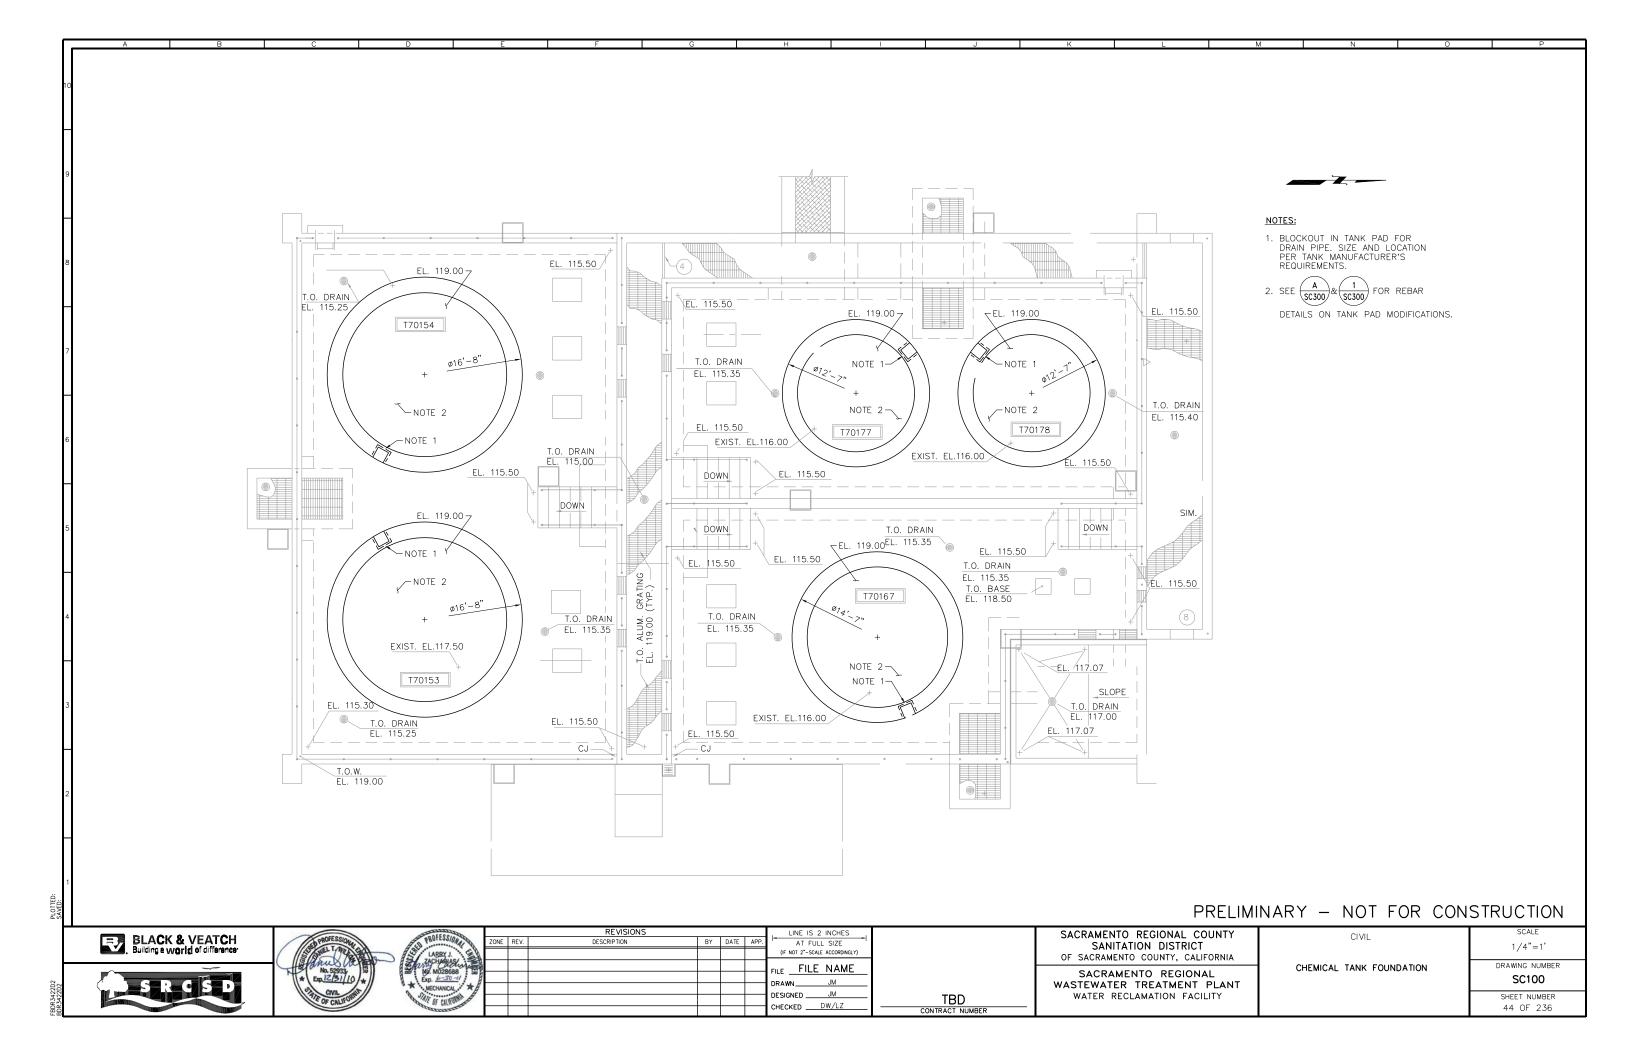

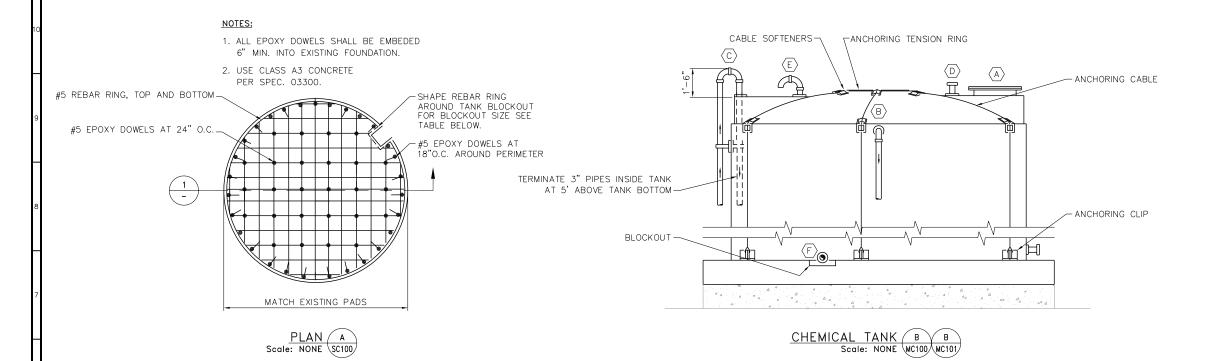TANK FITTINGS	REMARKS
(A) 24" TOP ACCESS MANWAY	SEE SPECS.
B 6" OVERFLOW	ELEVATION AS SHOWN
C 3" FILL LINE	ELEVATION AS SHOWN
D 4" LEVEL SENSOR FITTING	ELEVATION AS SHOWN
(E) 3" GOOSE NECK VENT	ELEVATION AS SHOWN
F 4" PUMP SUPPLY/ DRAIN CONNECTION	

NOTES:

- 1. SEE DWGS. MC100 AND MC101 FOR FITTINGS LOCATIONS.
- 2. PROVIDE CHEMICAL HAZARD LABEL PER NFPA 704.
- 3. SEISMIC RESTRAINT SYSTEM TO BE DESIGNED BY TANK MANUFACTURER. ANCHORING CLIPS TO BE INSTALLED 3" FROM TANK WALL.

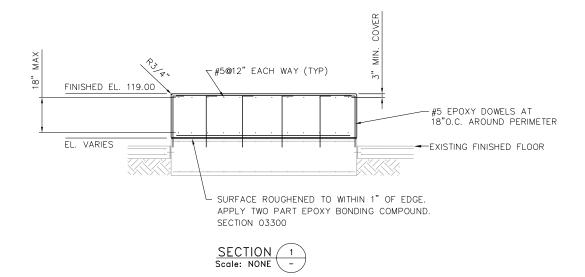

TANK ID BLOCKOUT SIZE LxWxH

T70153 SCLS | 15.5" x 17" x 6"

T70154 NAOH | 28.0" x 17" x 6"

T70167 SBIS | 15.5" x 17" x 6"

T70177 CTA | 15.5" x 17" x 6" T70178 ALM | 15.5" x 17" x 6"

PRELIMINARY - NOT FOR CONSTRUCTION

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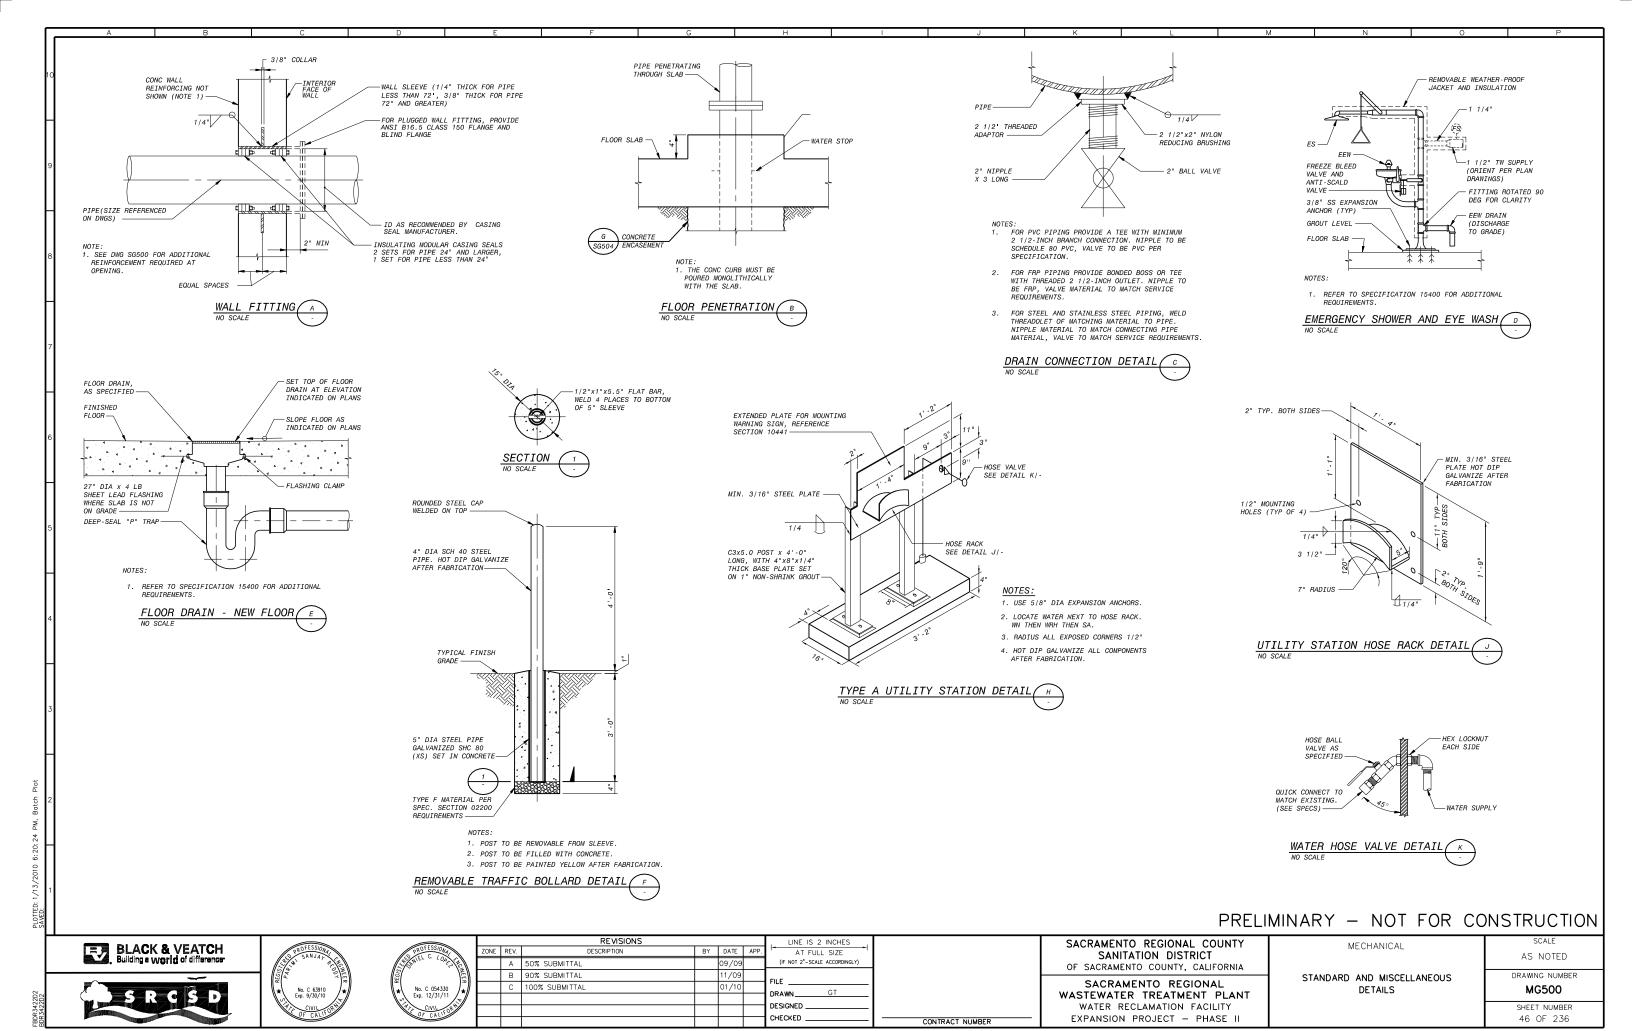
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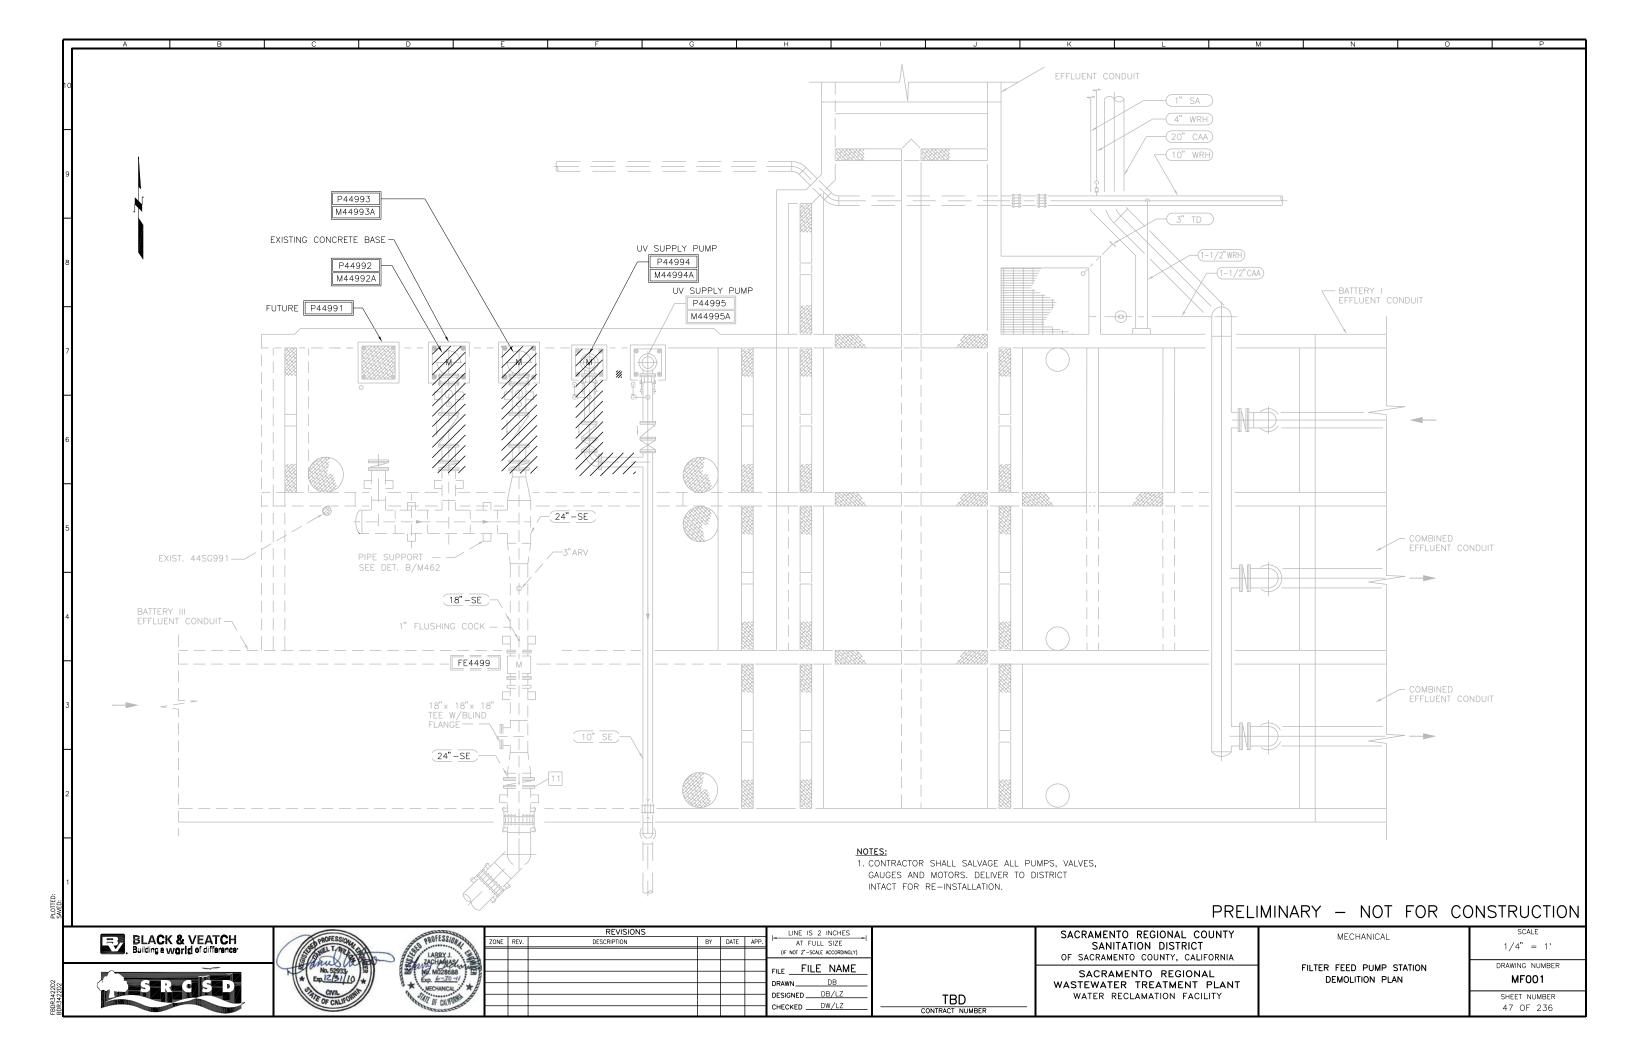
SACRAMENTO REGIONAL COUNTY SANITATION DISTRICT OF SACRAMENTO COUNTY, CALIFORNIA SACRAMENTO REGIONAL


WASTEWATER TREATMENT PLANT WATER RECLAMATION FACILITY


TANK MODIFICATION DETAILS

NO SCALE DRAWING NUMBER SC300 SHEET NUMBER 45 OF 236





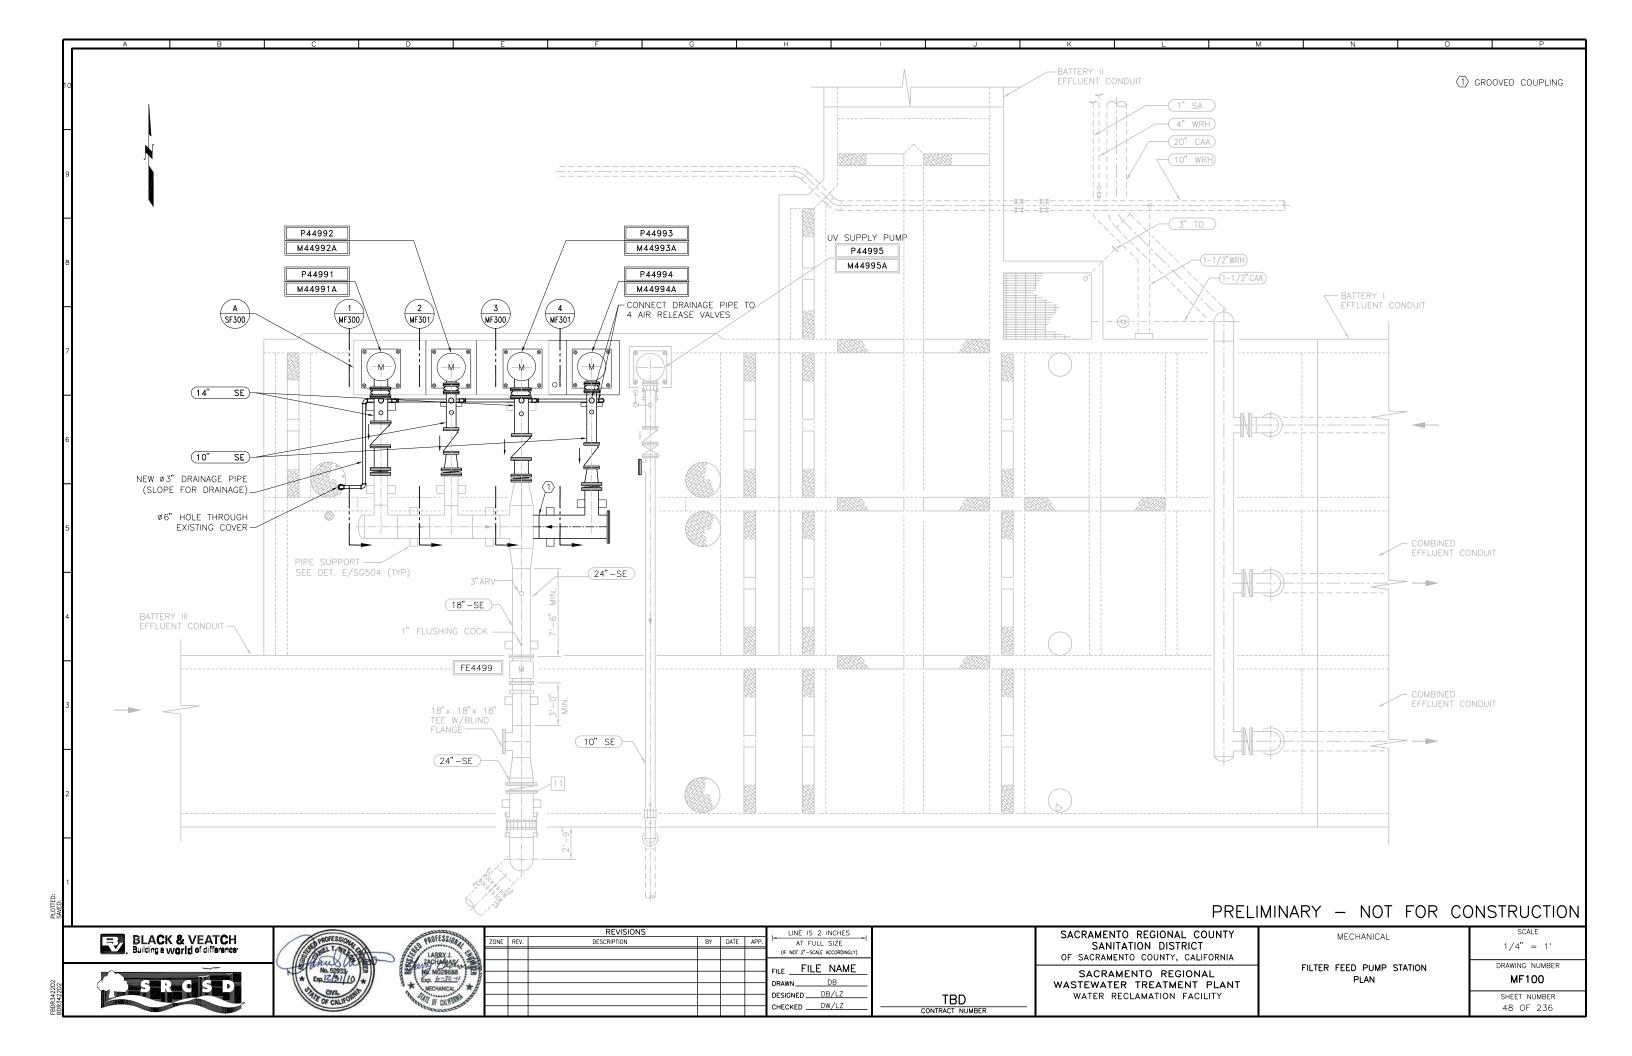

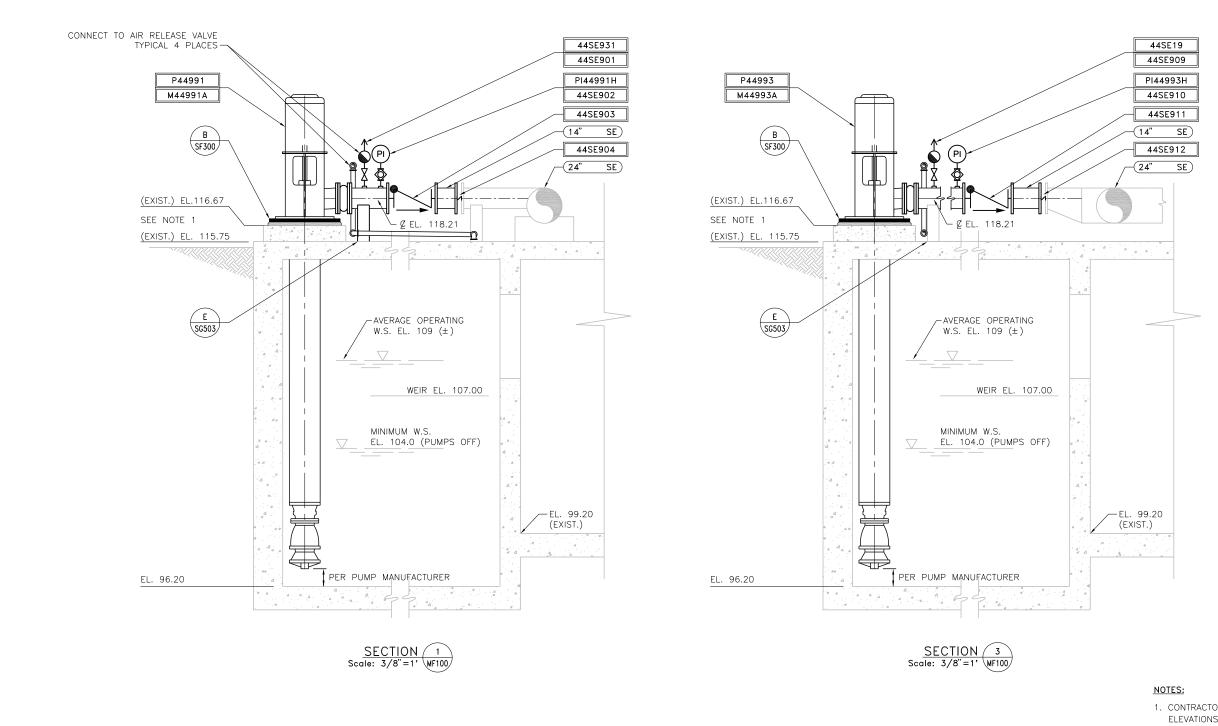

1. CONTRACTOR SHALL FIELD VERIFY DIMENSIONS AND ELEVATIONS OF EXISTING CONSTRUCTION PRIOR TO FABRICATION.

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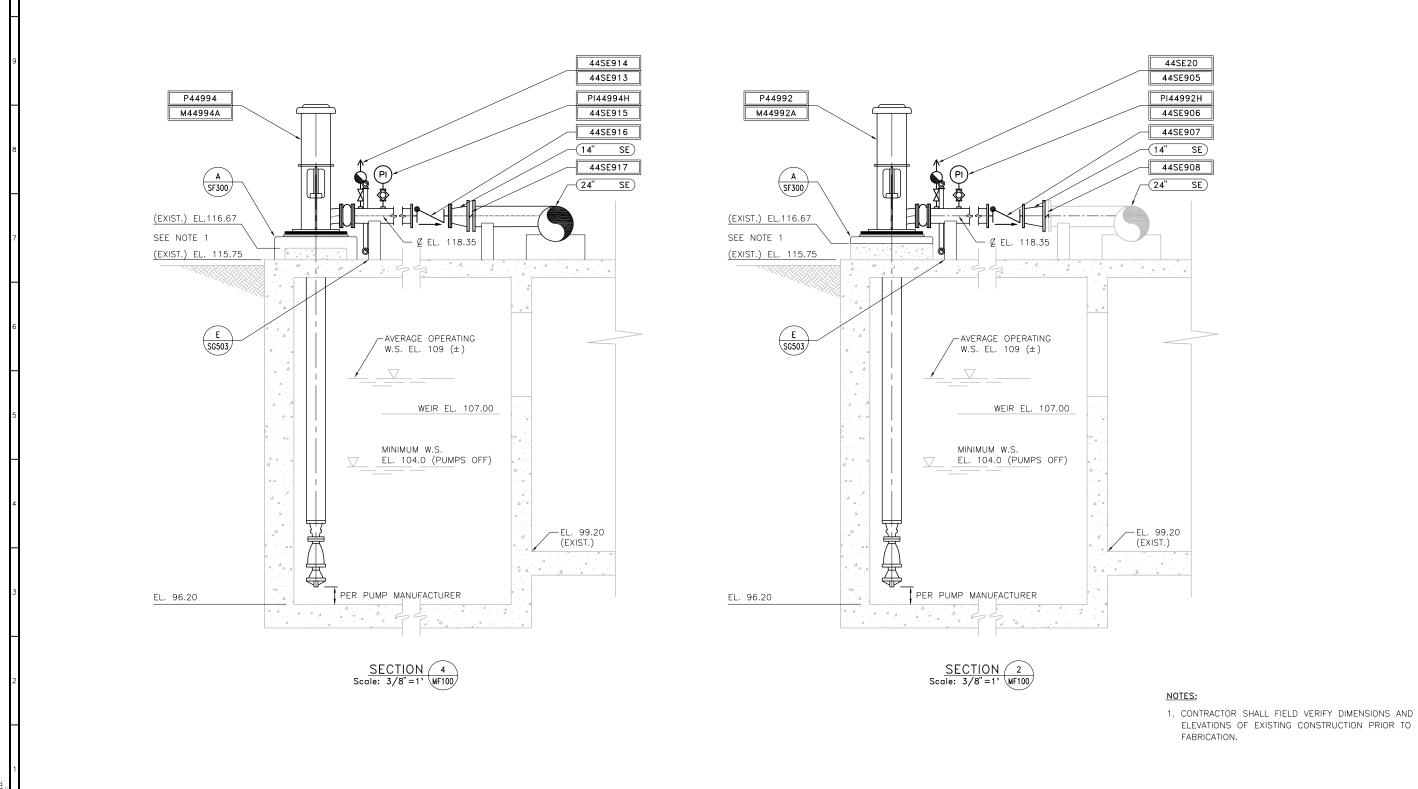
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SACRAMENTO REGIONAL COUNTY SANITATION DISTRICT OF SACRAMENTO COUNTY, CALIFORNIA

SACRAMENTO REGIONAL WASTEWATER TREATMENT PLANT MECHANICAL

FILTER FEED PUMP STATION 14" PIPE SECTION

3/8"=1' DRAWING NUMBER MF300 SHEET NUMBER 49 OF 236



PRELIMINARY - NOT FOR CONSTRUCTION







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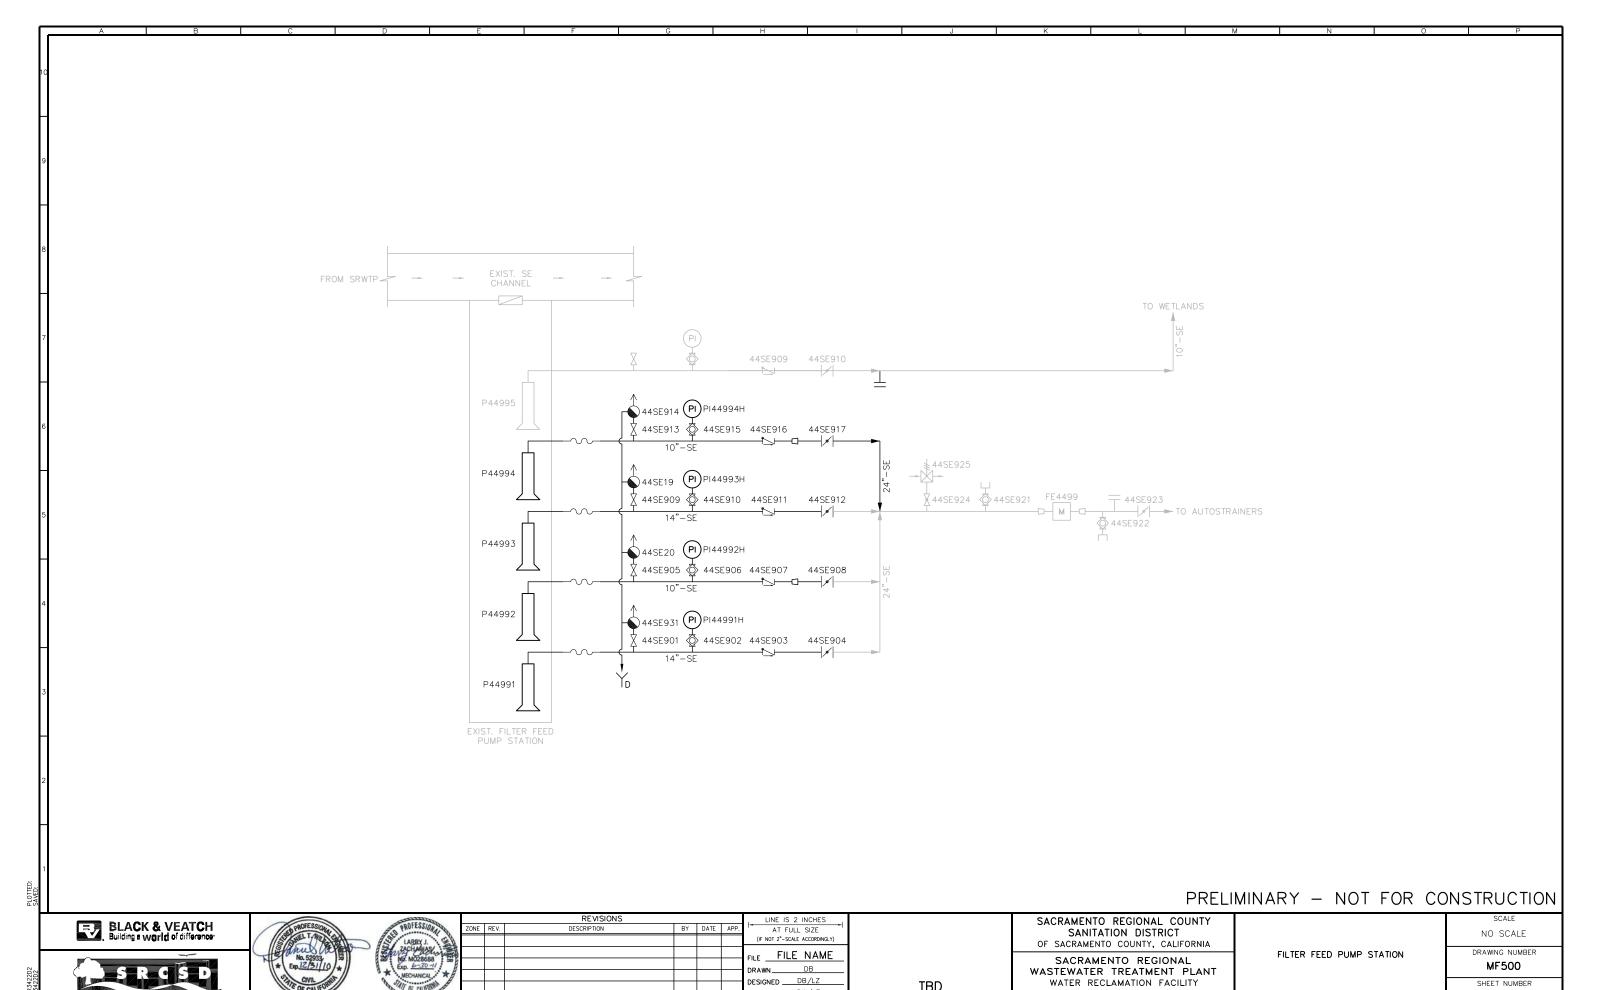
SACRAMENTO REGIONAL COUNTY SANITATION DISTRICT OF SACRAMENTO COUNTY, CALIFORNIA

SACRAMENTO REGIONAL WASTEWATER TREATMENT PLANT WATER RECLAMATION FACILITY

MECHANICAL

FILTER FEED PUMP STATION 10" PIPE SECTION

3/8"=1' DRAWING NUMBER MF301 SHEET NUMBER 50 OF 236




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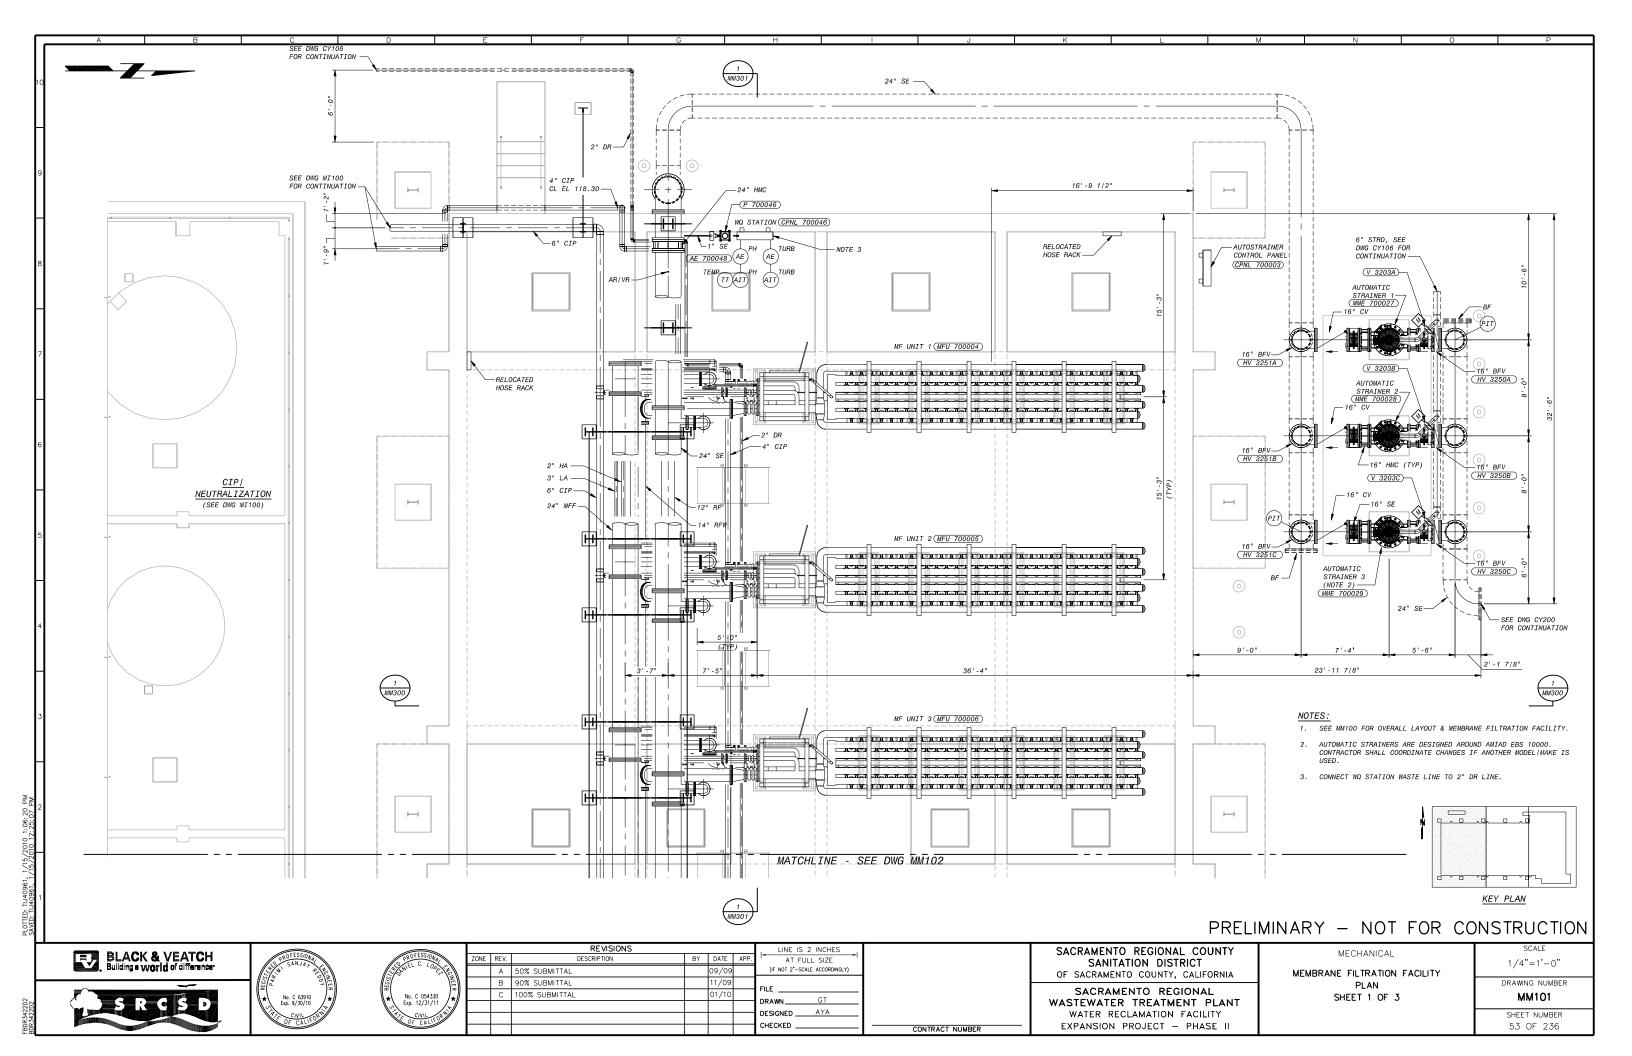
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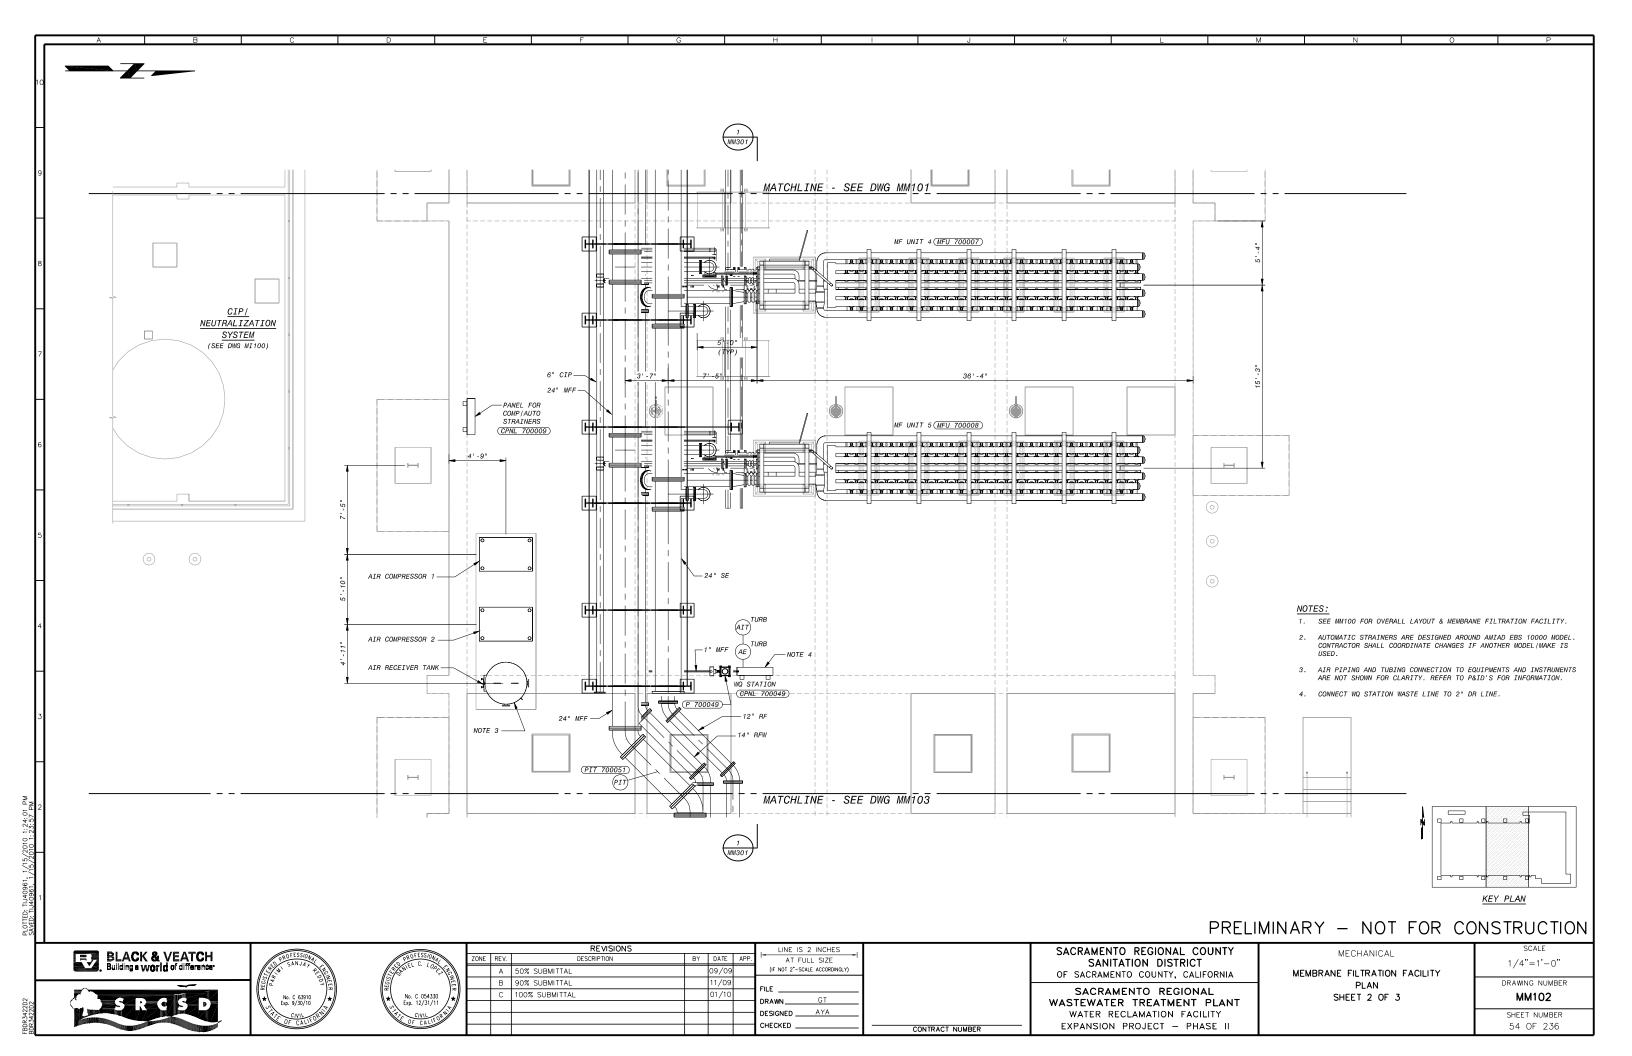
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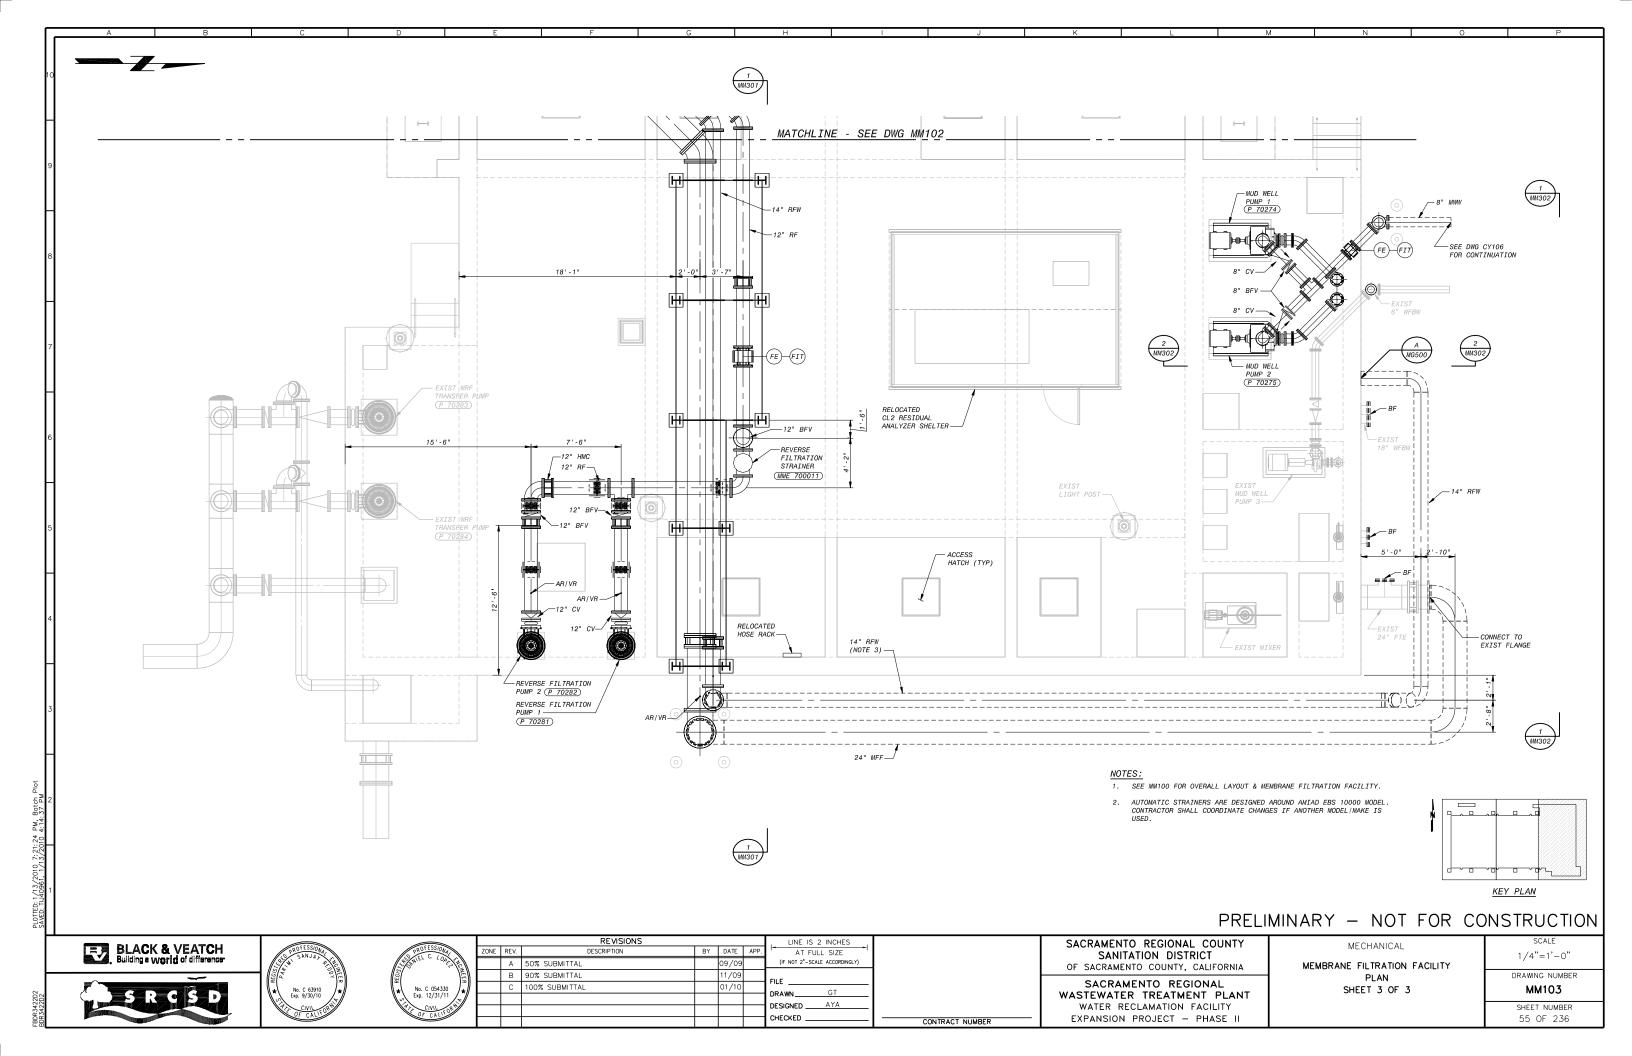
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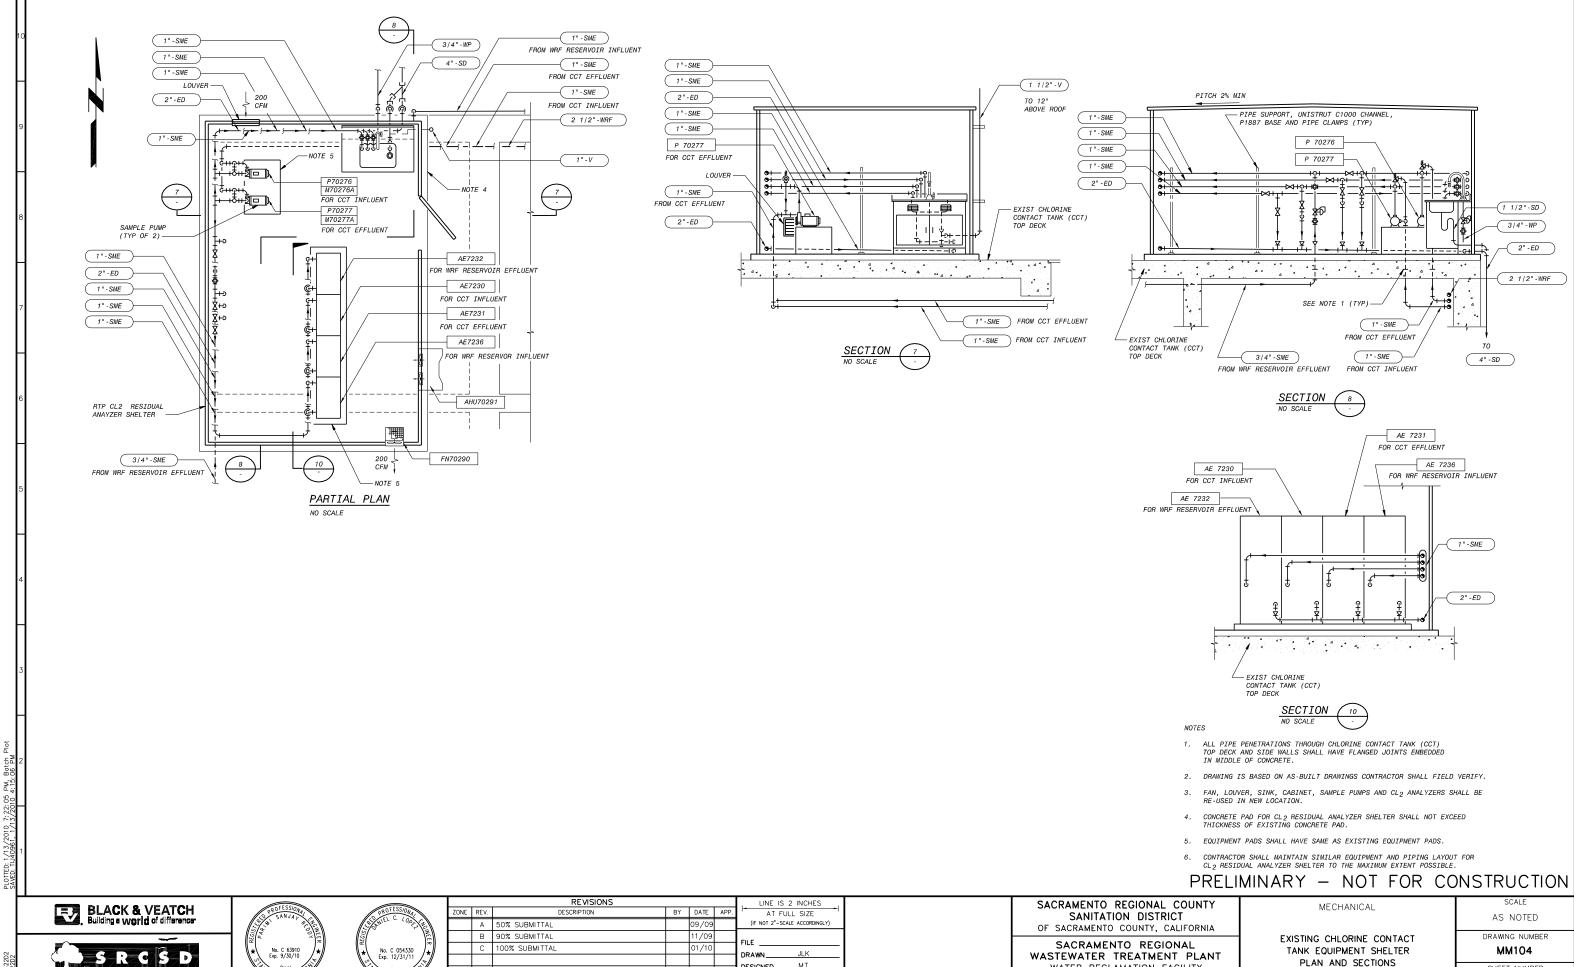
51 OF 236









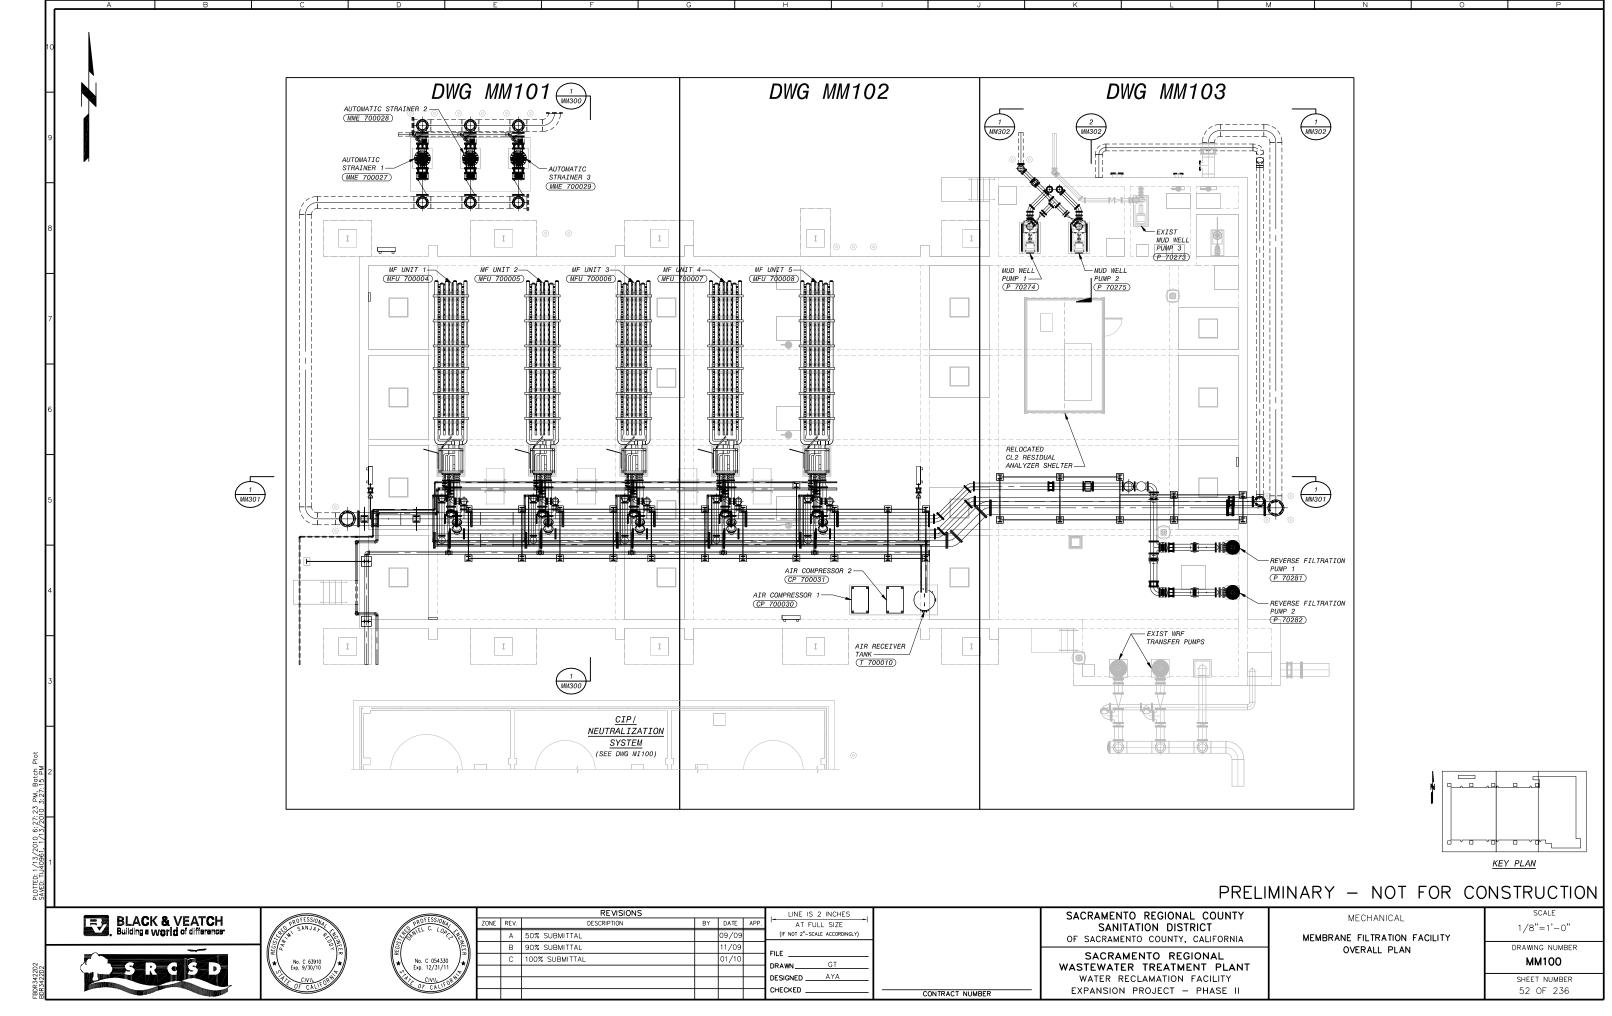

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CONTRACT NUMBER

WATER RECLAMATION FACILITY

EXPANSION PROJECT - PHASE II

SHEET NUMBER

56 OF 236

DESIGNED _

CHECKED _

SAMPLE LINES FROM CCT DETAIL A
NO SCALE



CONTRACT NUMBER

SAMPLE LINE FROM WRF DETAIL B
NO SCALE

PRELIMINARY - NOT FOR CONSTRUCTION







		REVISIONS				LINE IS 2 INCHES
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SACRAMENTO REGIONAL COUNTY
SANITATION DISTRICT
OF SACRAMENTO COUNTY, CALIFORNIA

SACRAMENTO REGIONAL
WASTEWATER TREATMENT PLANT
WATER RECLAMATION FACILITY
EXPANSION PROJECT — PHASE II

EXISTING CHLORINE CONTACT TANK EQUIPMENT SHELTER DETAILS

MECHANICAL

SCALE
AS NOTED

DRAWING NUMBER

MM105 SHEET NUMBER 57 OF 236

BDR3422D2 DR3422D2





NORTH WALL OF CL2 RESIDUAL ANALYZER SHELTER DETAIL
NO SCALE

NORTH CCT DETAIL
NO SCALE

PRELIMINARY - NOT FOR CONSTRUCTION







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SACRAMENTO REGIONAL COUNTY SANITATION DISTRICT
OF SACRAMENTO COUNTY, CALIFORNIA

SACRAMENTO REGIONAL WASTEWATER TREATMENT PLANT WATER RECLAMATION FACILITY EXPANSION PROJECT - PHASE II


CONTRACT NUMBER

EXISTING CHLORINE CONTACT TANK EQUIPMENT SHELTER DETAILS

MECHANICAL

AS NOTED DRAWING NUMBER

MM106 SHEET NUMBER 58 OF 236

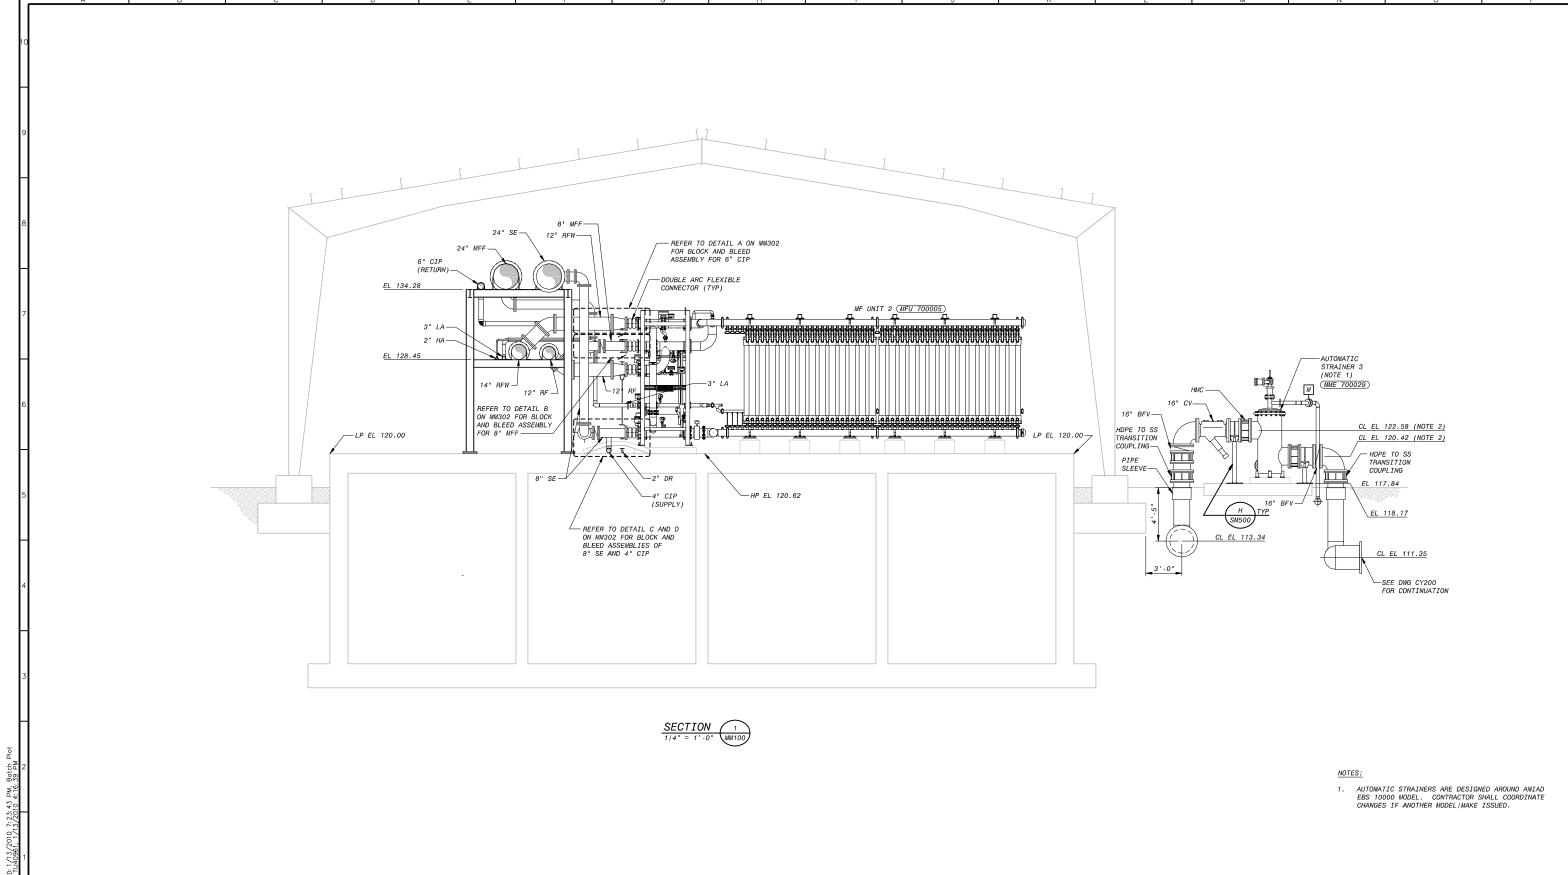

PRELIMINARY - NOT FOR CONSTRUCTION

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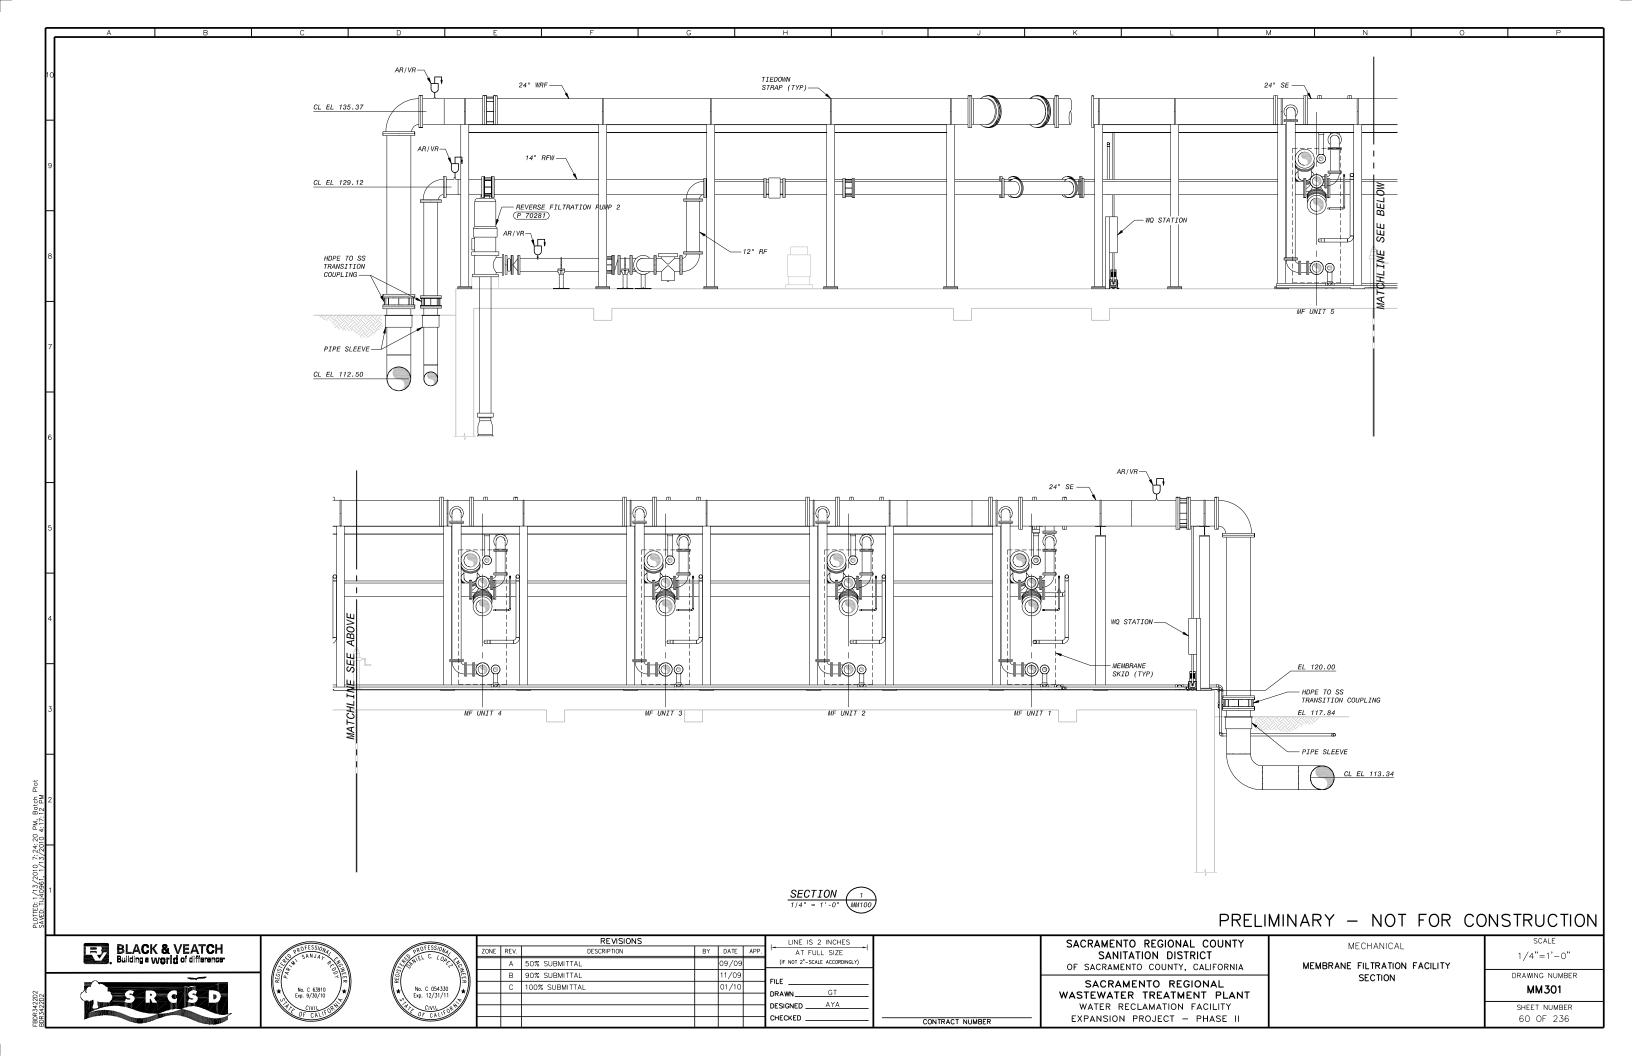
SACRAMENTO REGIONAL COUNTY SANITATION DISTRICT OF SACRAMENTO COUNTY, CALIFORNIA


SACRAMENTO REGIONAL WASTEWATER TREATMENT PLANT WATER RECLAMATION FACILITY EXPANSION PROJECT - PHASE II

MECHANICAL MEMBRANE FILTRATION FACILITY SECTION

1/4"=1'-0" DRAWING NUMBER MM300 SHEET NUMBER

59 OF 236



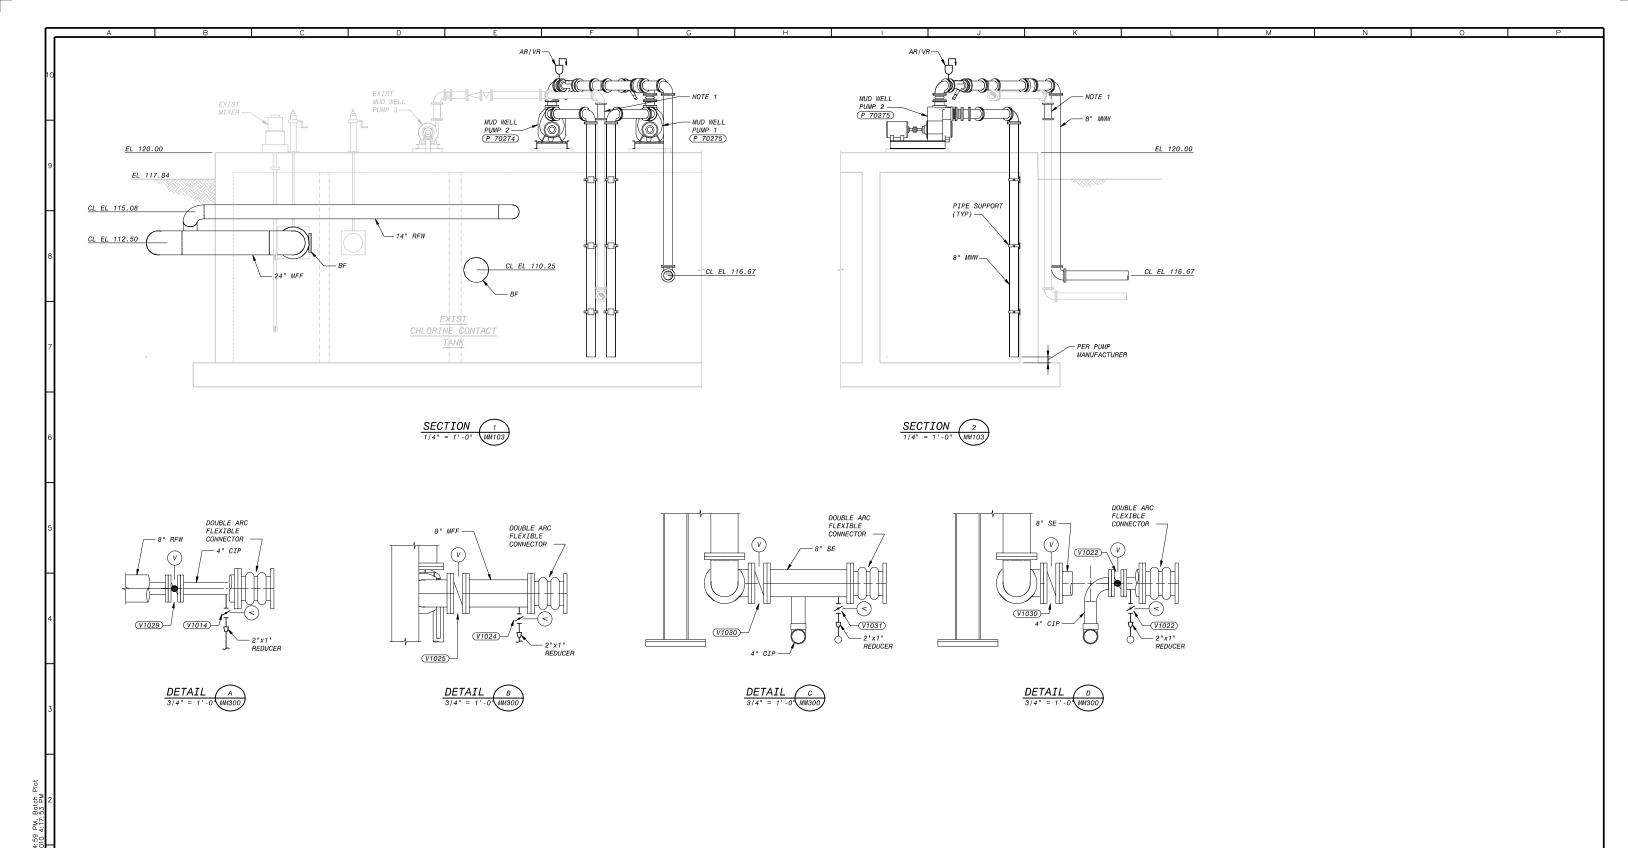

1. REPLACE EXISTING TEE WITH NEW SPOOL PIECE.

PRELIMINARY - NOT FOR CONSTRUCTION







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OF SACRAMENTO COUNTY, CALIFORNIA
SANITATION DISTRICT
SACRAMENTO REGIONAL COUNTY


SACRAMENTO REGIONAL
VASTEWATER TREATMENT PLANT
WATER RECLAMATION FACILITY
EXPANSION PROJECT - PHASE II


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SECTIONS AND DETAILS	


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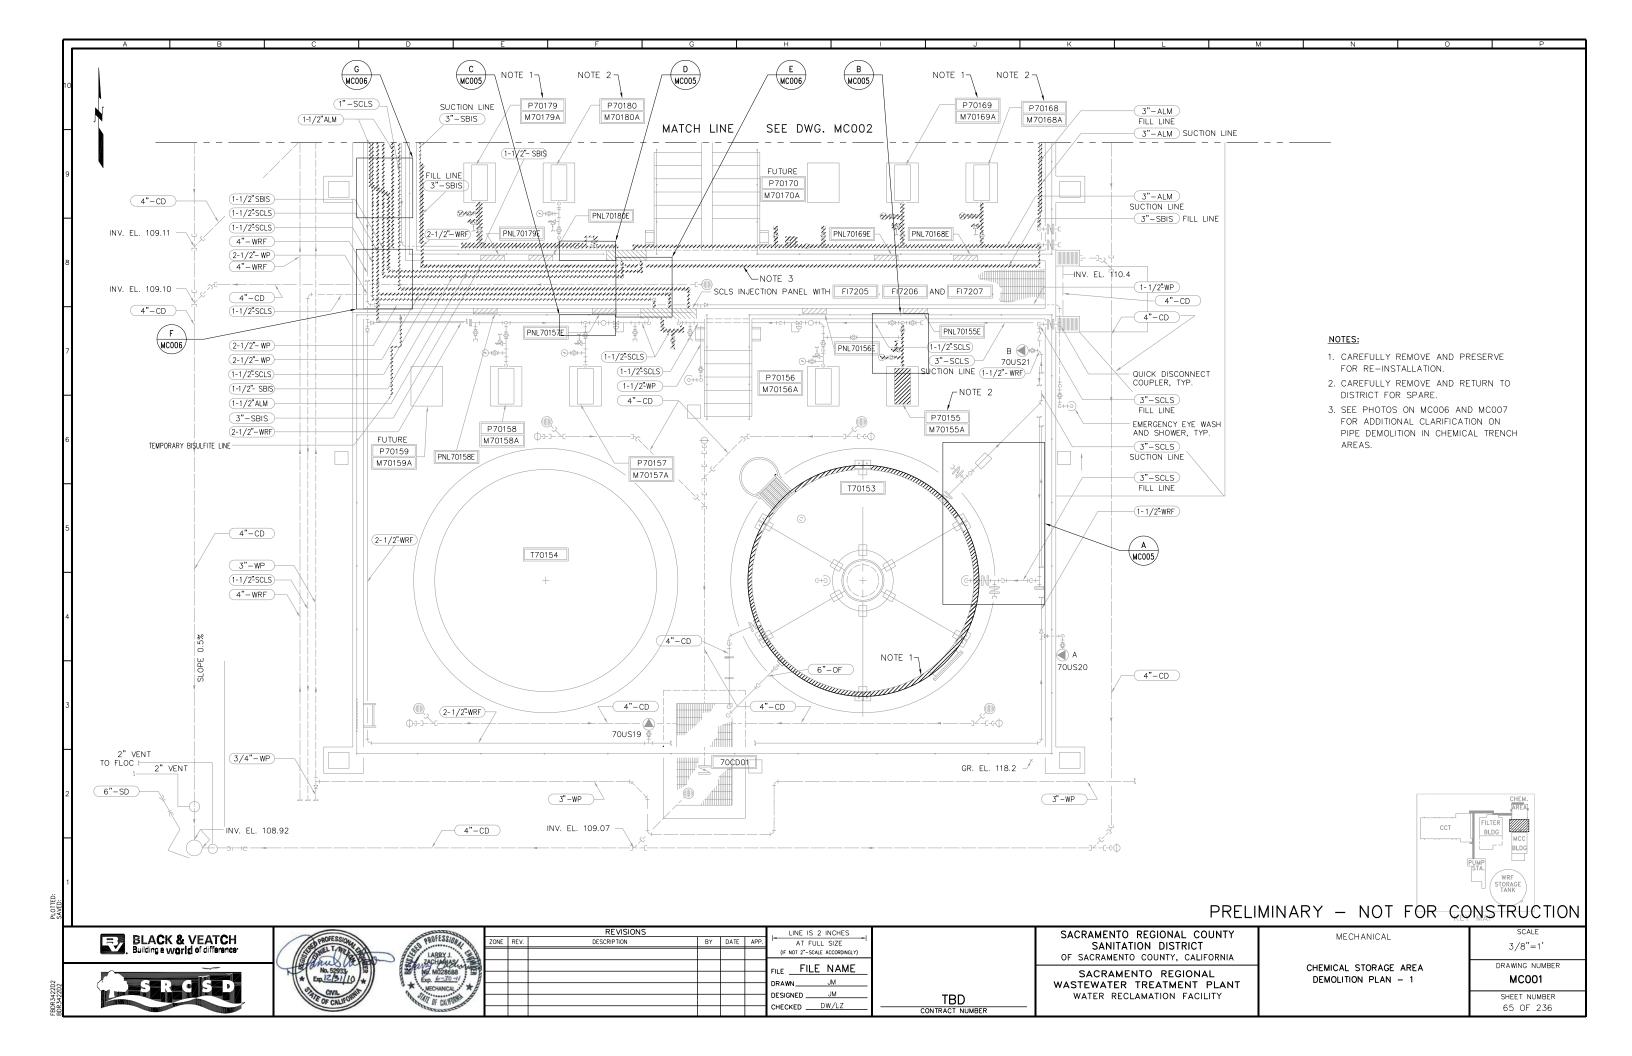
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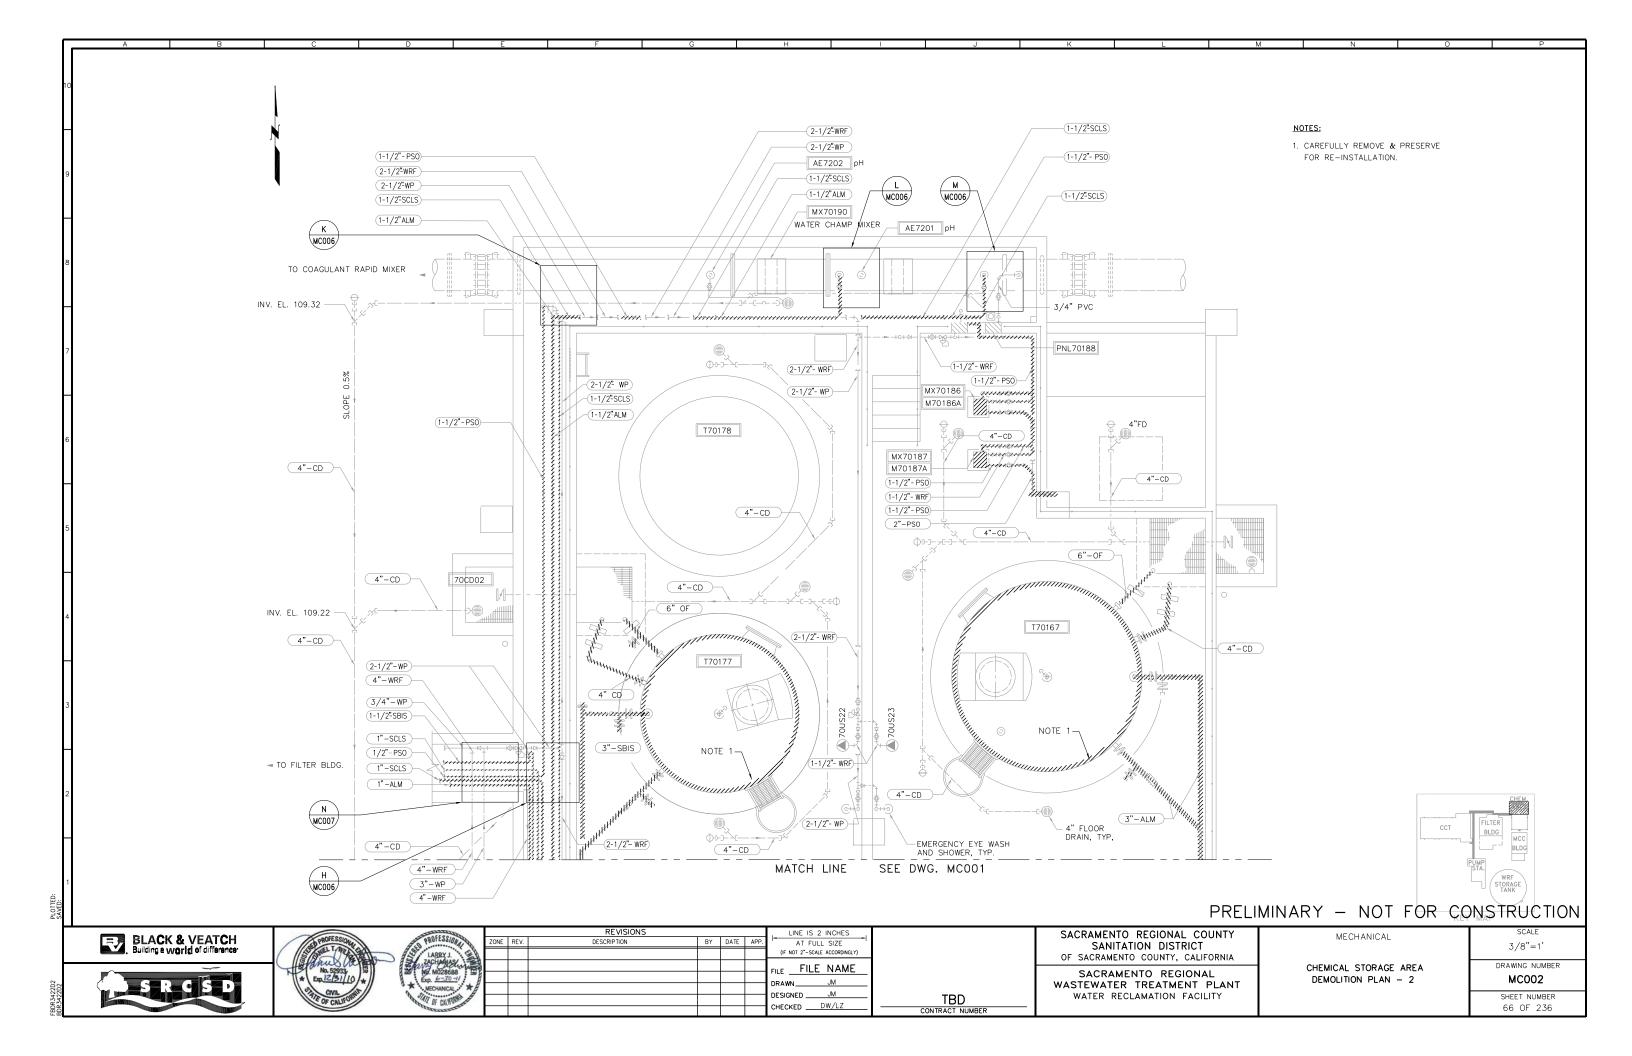
MM302 SHEET NUMBER 61 OF 236







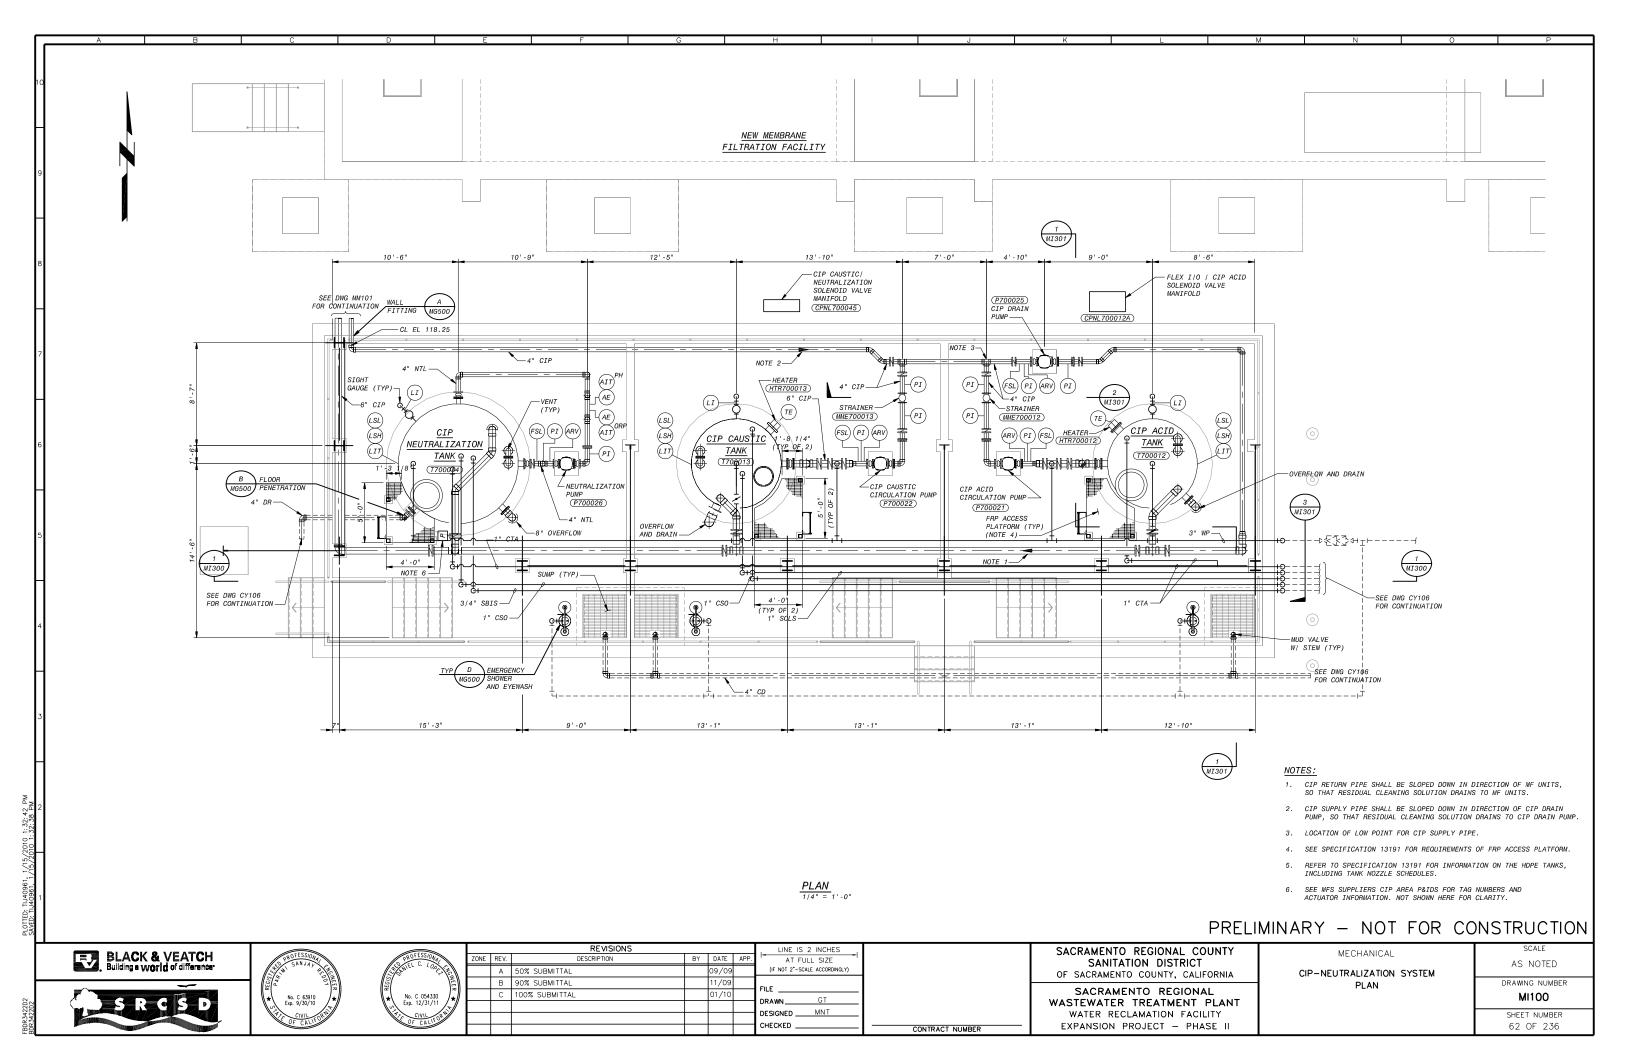


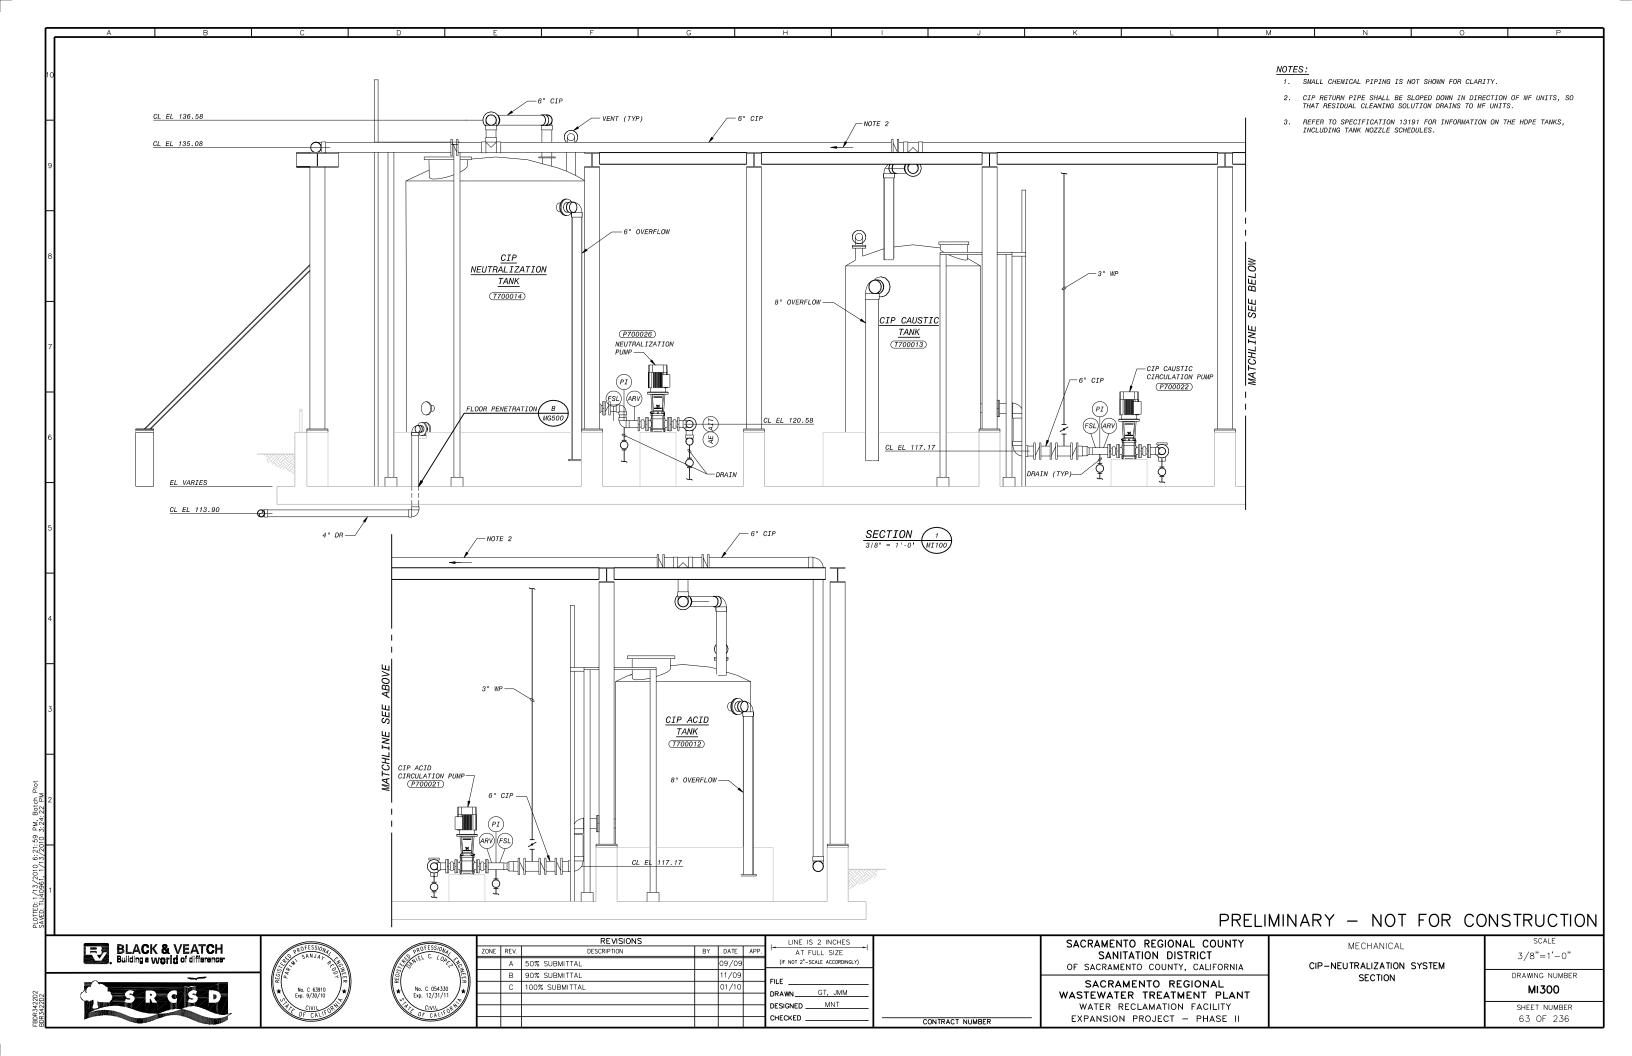

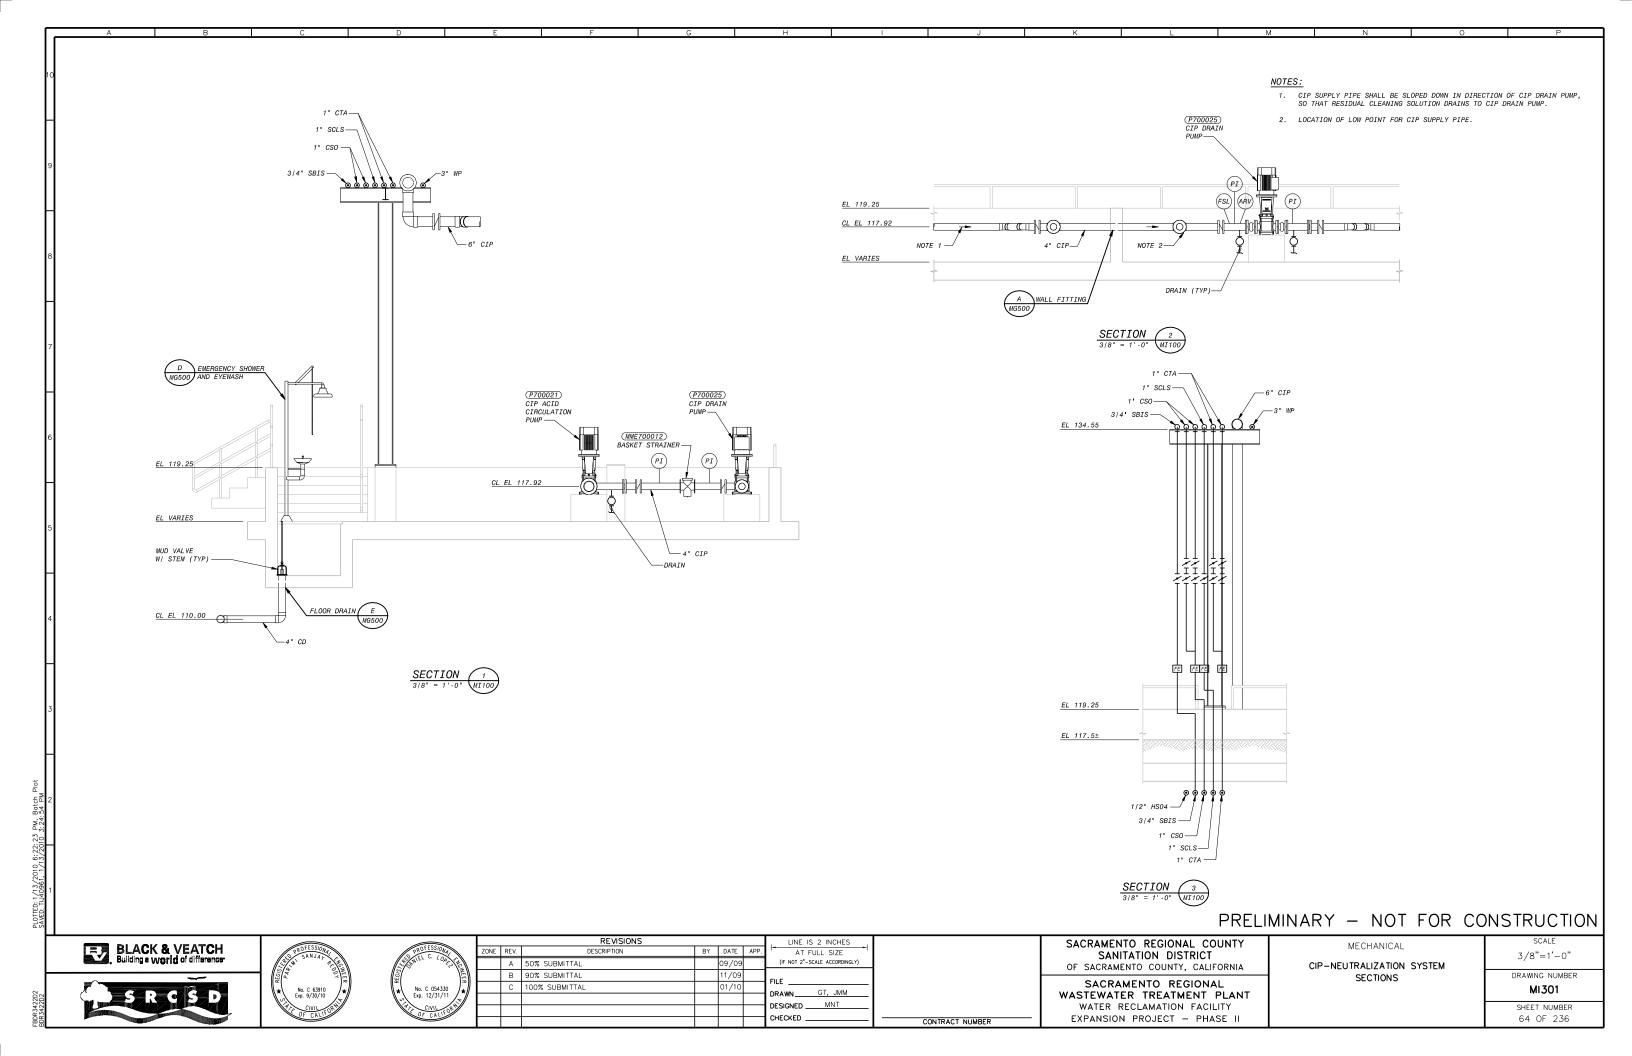

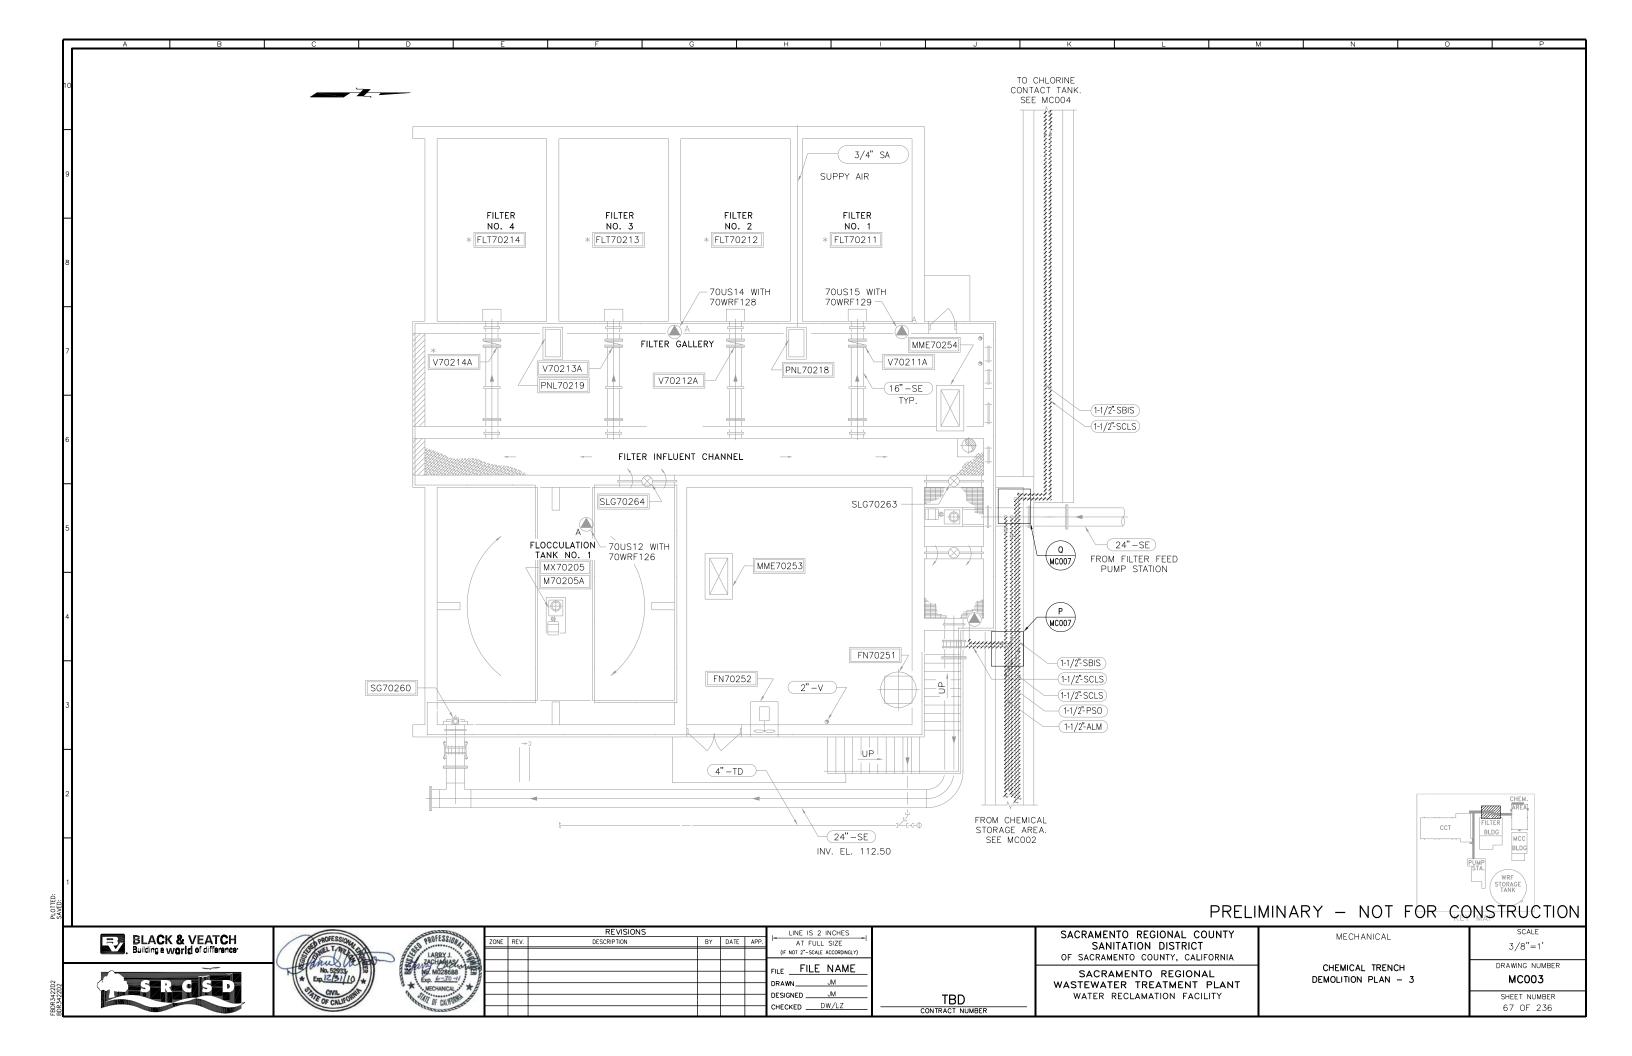

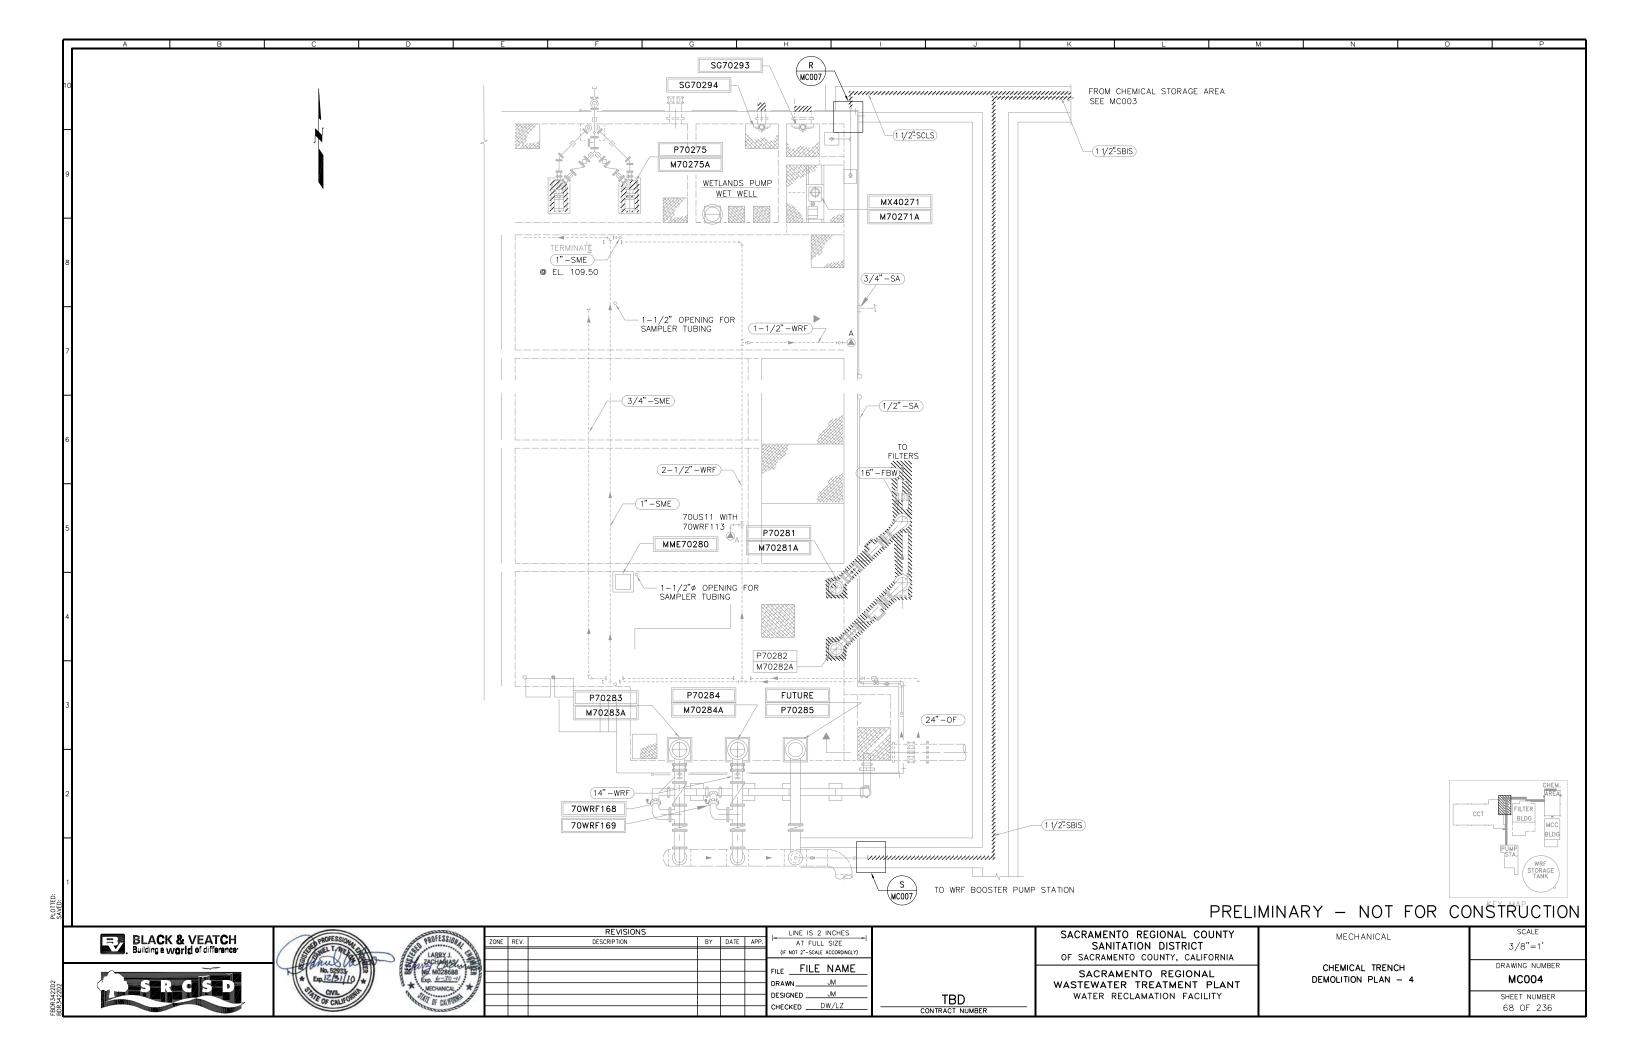

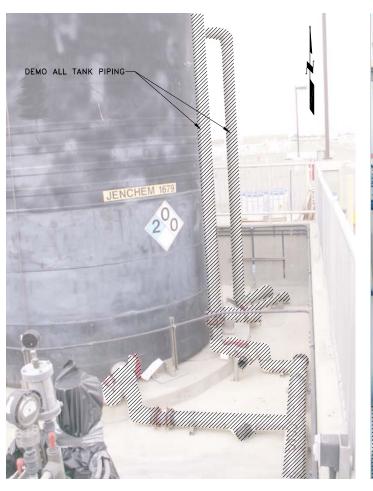



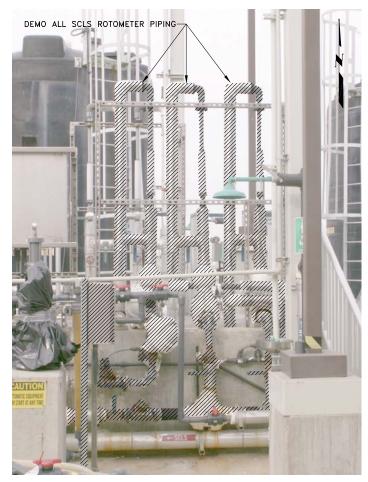




PHOTO A
Scale: NO SCALE MC001

PHOTO B
Scale: NO SCALE MC001

PHOTO C Scale: NO SCALE MC001

PHOTO D
Scale: NO SCALE MC001

PRELIMINARY - NOT FOR CONSTRUCTION

BLACK & VEATCH
Building a World of difference





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SACRAMENTO REGIONAL COUNTY SANITATION DISTRICT OF SACRAMENTO COUNTY, CALIFORNIA

SACRAMENTO REGIONAL
WASTEWATER TREATMENT PLANT
WATER RECLAMATION FACILITY

MECHANICAL

CHEMICAL STORAGE AREA DEMOLITION PHOTOS -1

SCALE NO SCALE

DRAWING NUMBER MC005

SHEET NUMBER 69 OF 236












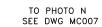


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Scale: NO SCALE MC001



PHOTO H Scale: NO SCALE MC002





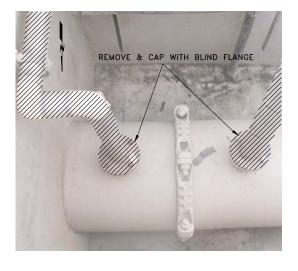

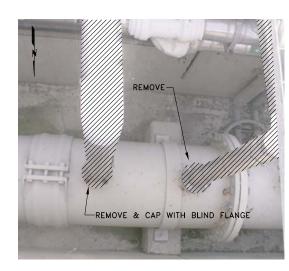




PHOTO E Scale: NO SCALE MC001

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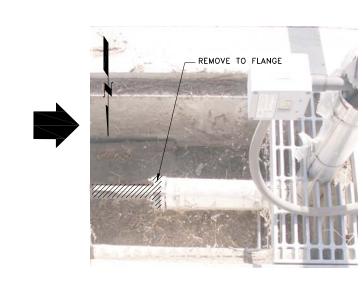
SACRAMENTO REGIONAL COUNTY SANITATION DISTRICT OF SACRAMENTO COUNTY, CALIFORNIA

SACRAMENTO REGIONAL
WASTEWATER TREATMENT PLANT
WATER RECLAMATION FACILITY

MECHANICAL CHEMICAL TRENCH DEMOLITION PHOTOS - 2

NO SCALE DRAWING NUMBER MC006

> SHEET NUMBER 70 OF 236







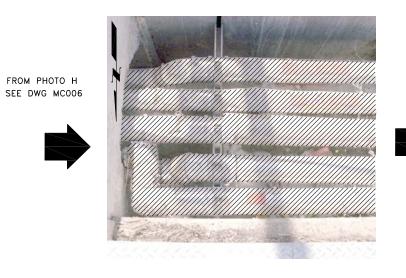








PHOTO P Scale: NO SCALE MC003

PHOTO Q
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PRELIMINARY - NOT FOR CONSTRUCTION





PHOTO N Scale: NO SCALE MC002



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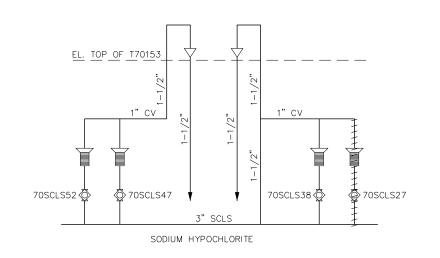
SACRAMENTO REGIONAL COUNTY SANITATION DISTRICT OF SACRAMENTO COUNTY, CALIFORNIA


SACRAMENTO REGIONAL
WASTEWATER TREATMENT PLANT
WAYER RECLAMATION FACILITY


MECHANICAL CHEMICAL TRENCH DEMOLITION PHOTOS - 3

SCALE NO SCALE DRAWING NUMBER MC007

> SHEET NUMBER 71 OF 236



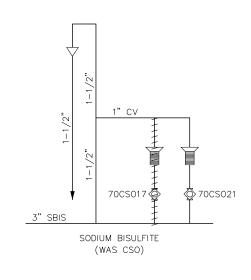

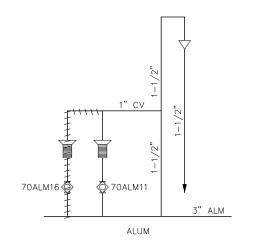

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BLACK & VEAT[^]
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PROFESSIONAL BENEFIT OF CALIFORNIA



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SANITATION DISTRICT
OF SACRAMENTO COUNTY, CALIFORNIA

SACRAMENTO REGIONAL
WASTEWATER TREATMENT PLANT
WATER RECLAMATION FACILITY


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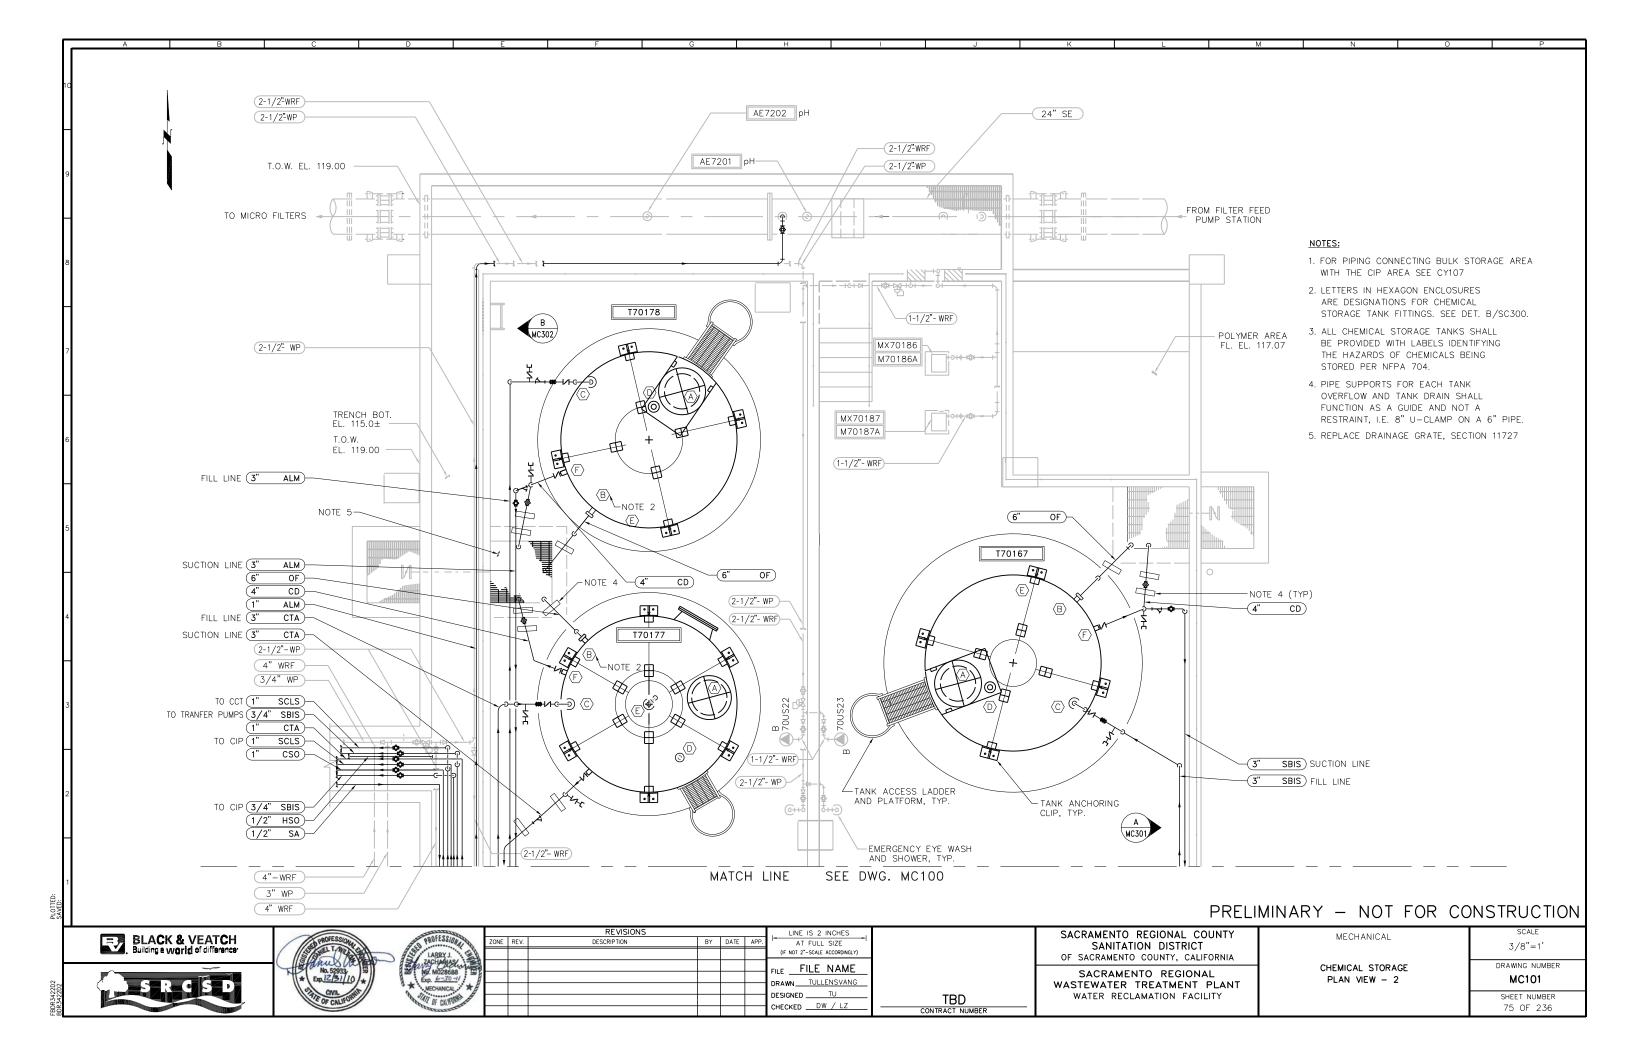
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CHEMICAL VENT SYSTEMS SCHEMATICS
DEMOLITION


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SHEET NUMBER
73 OF 236


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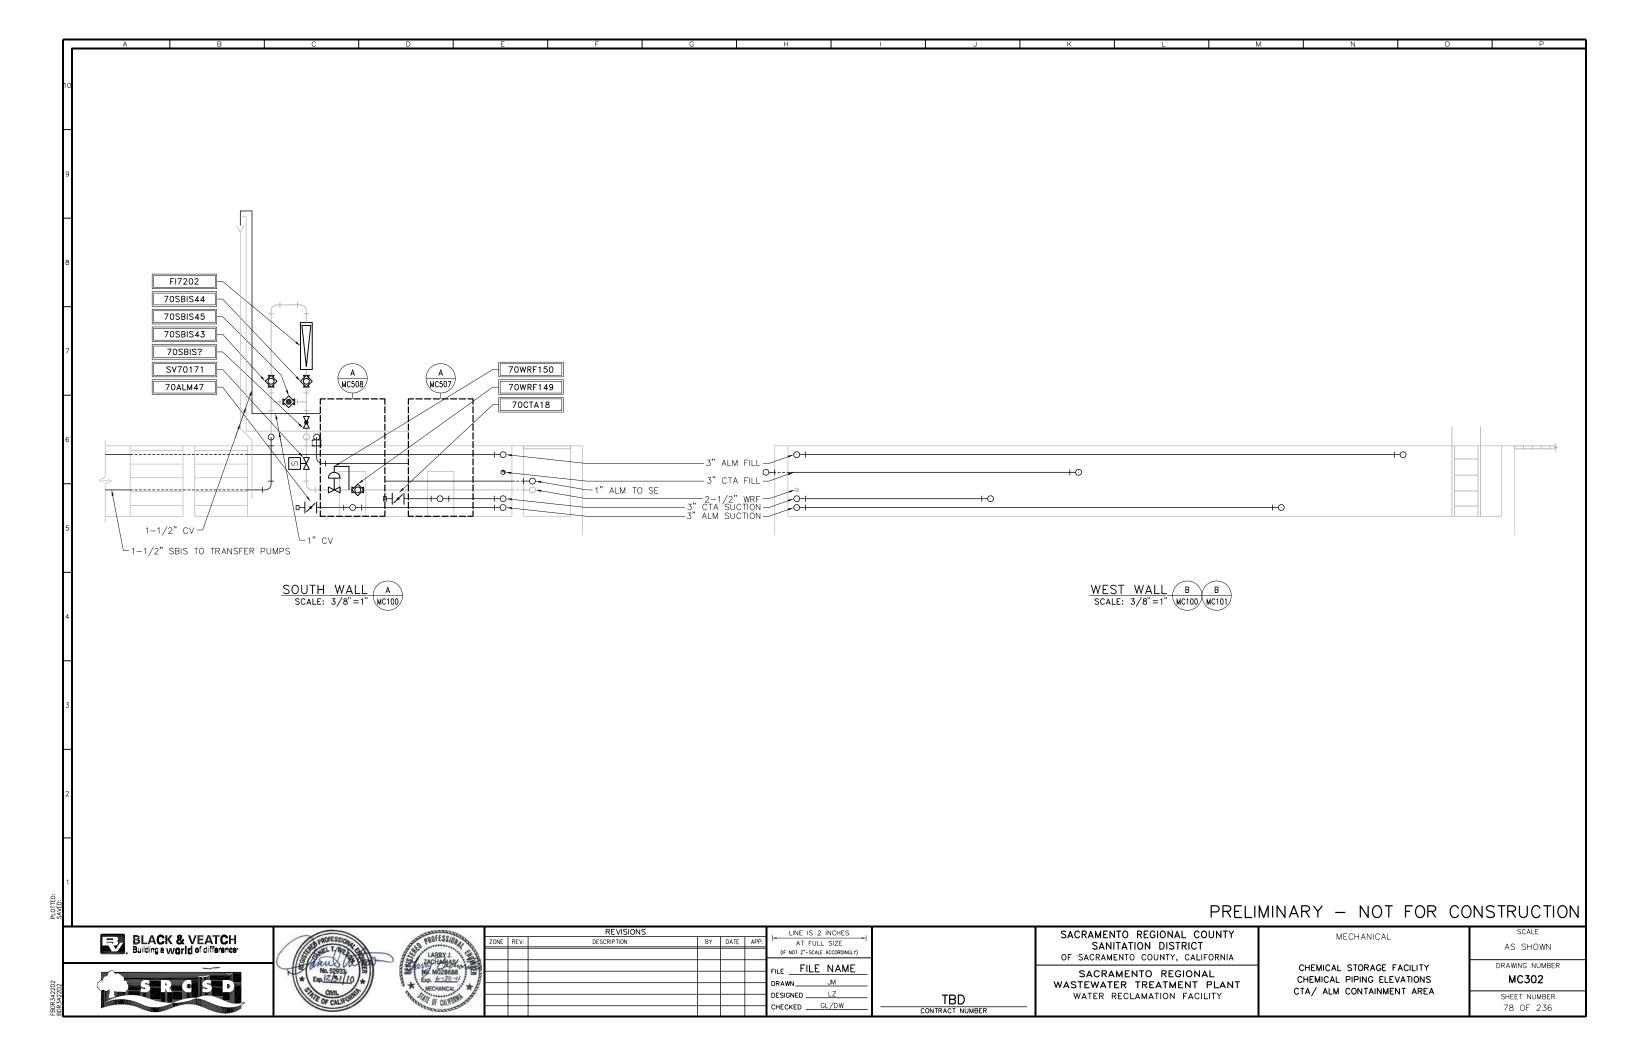
Black & Veatch Corporation
Walnut Creek, California







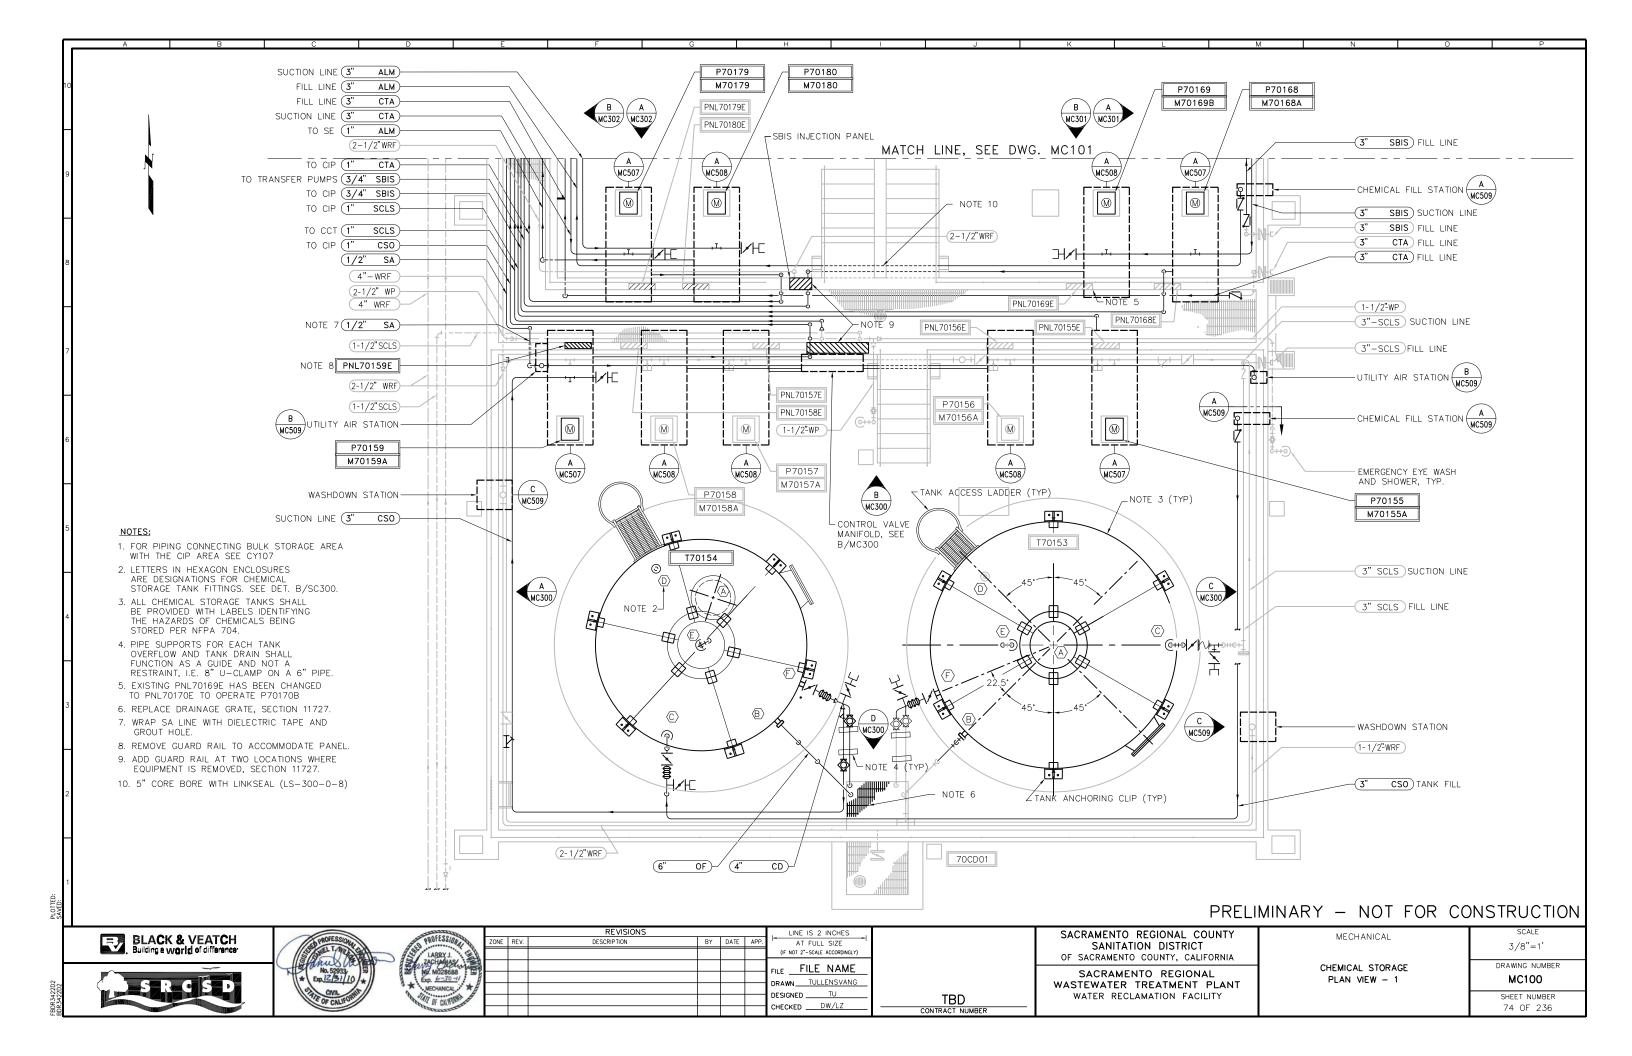


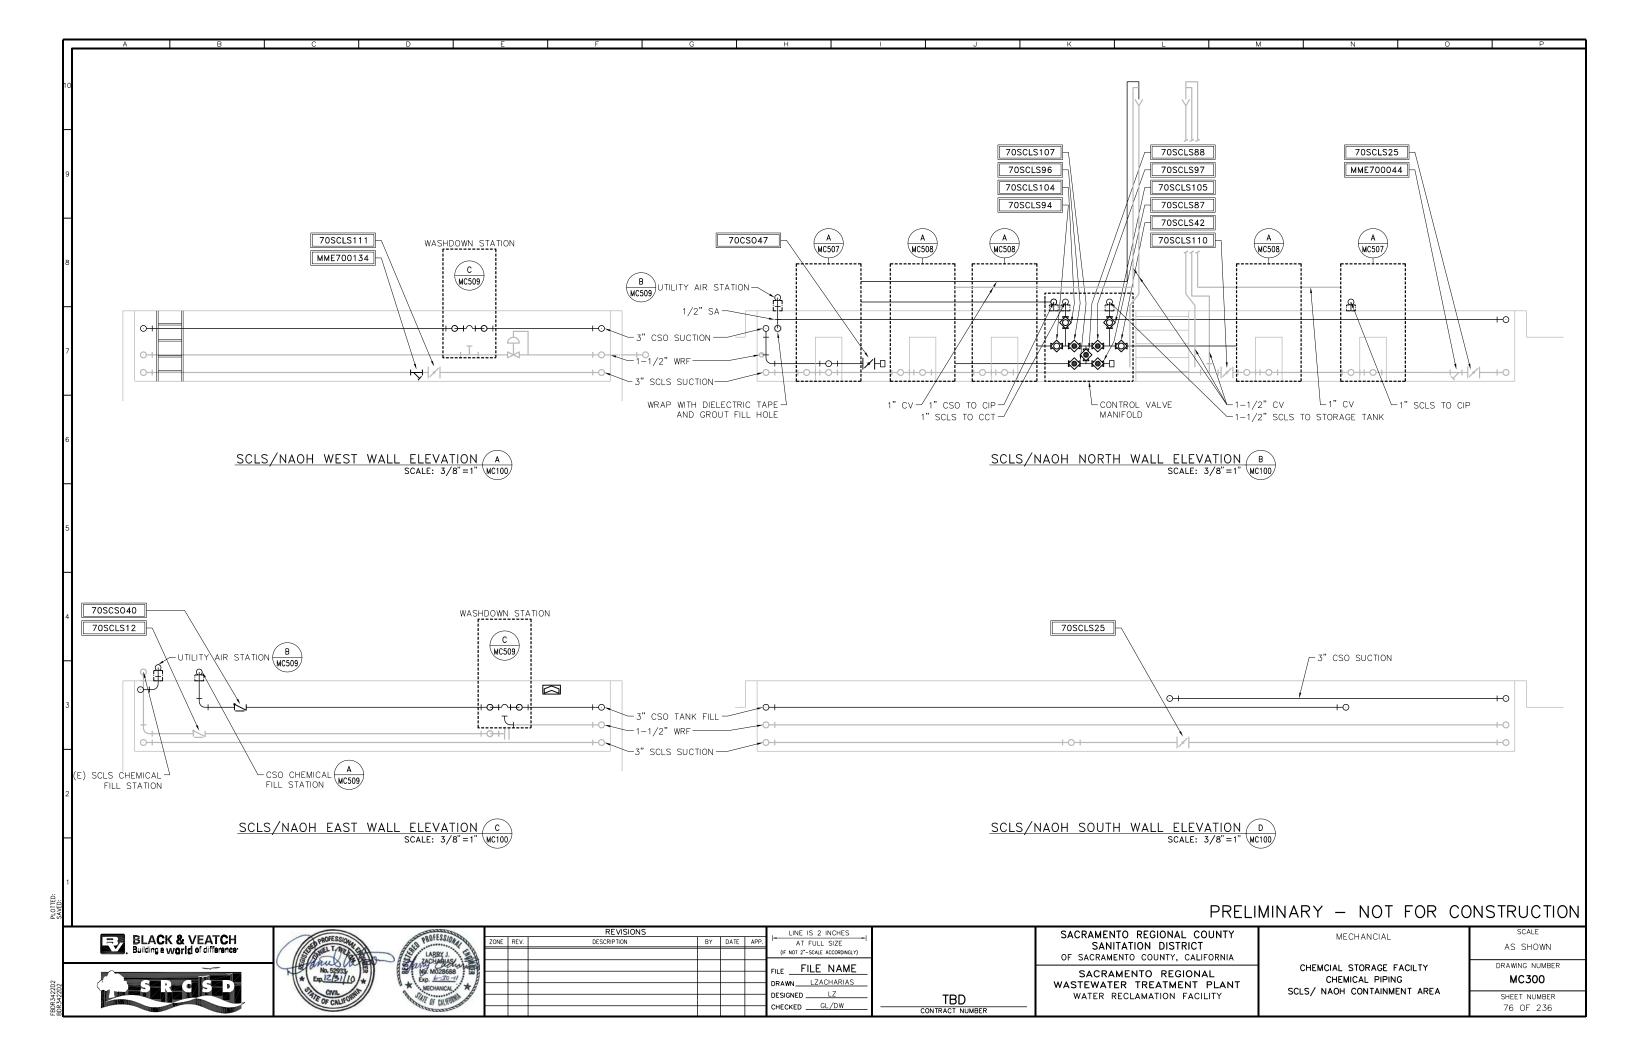


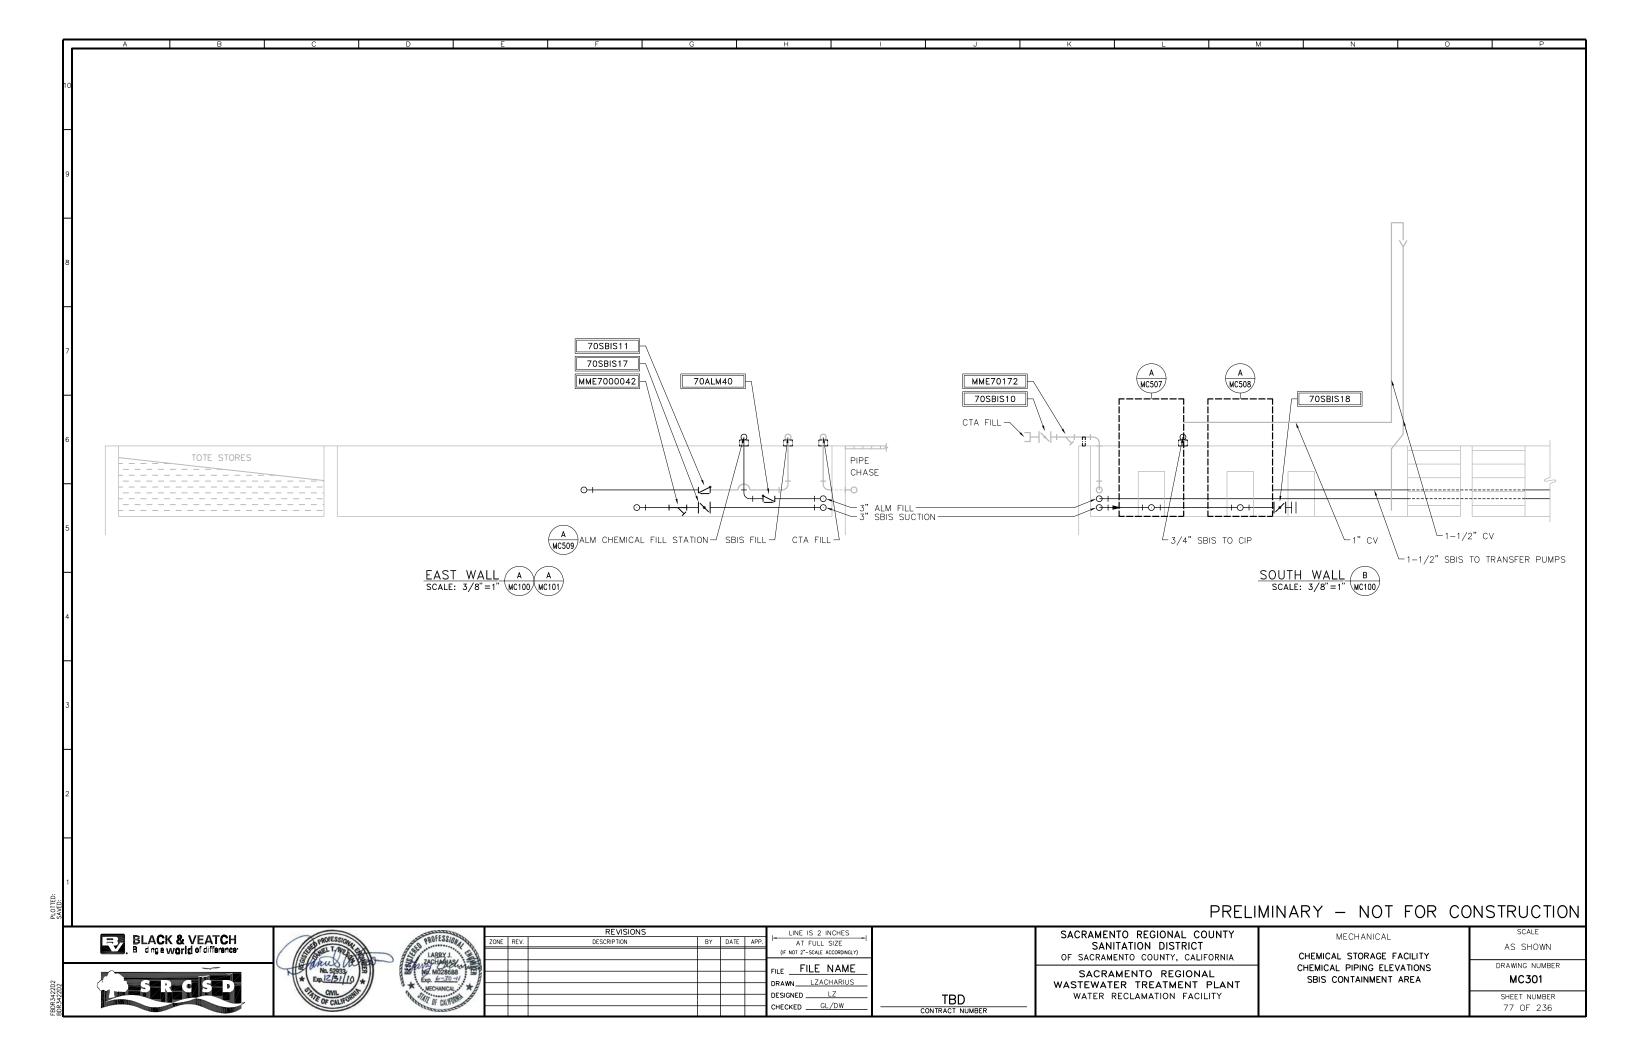


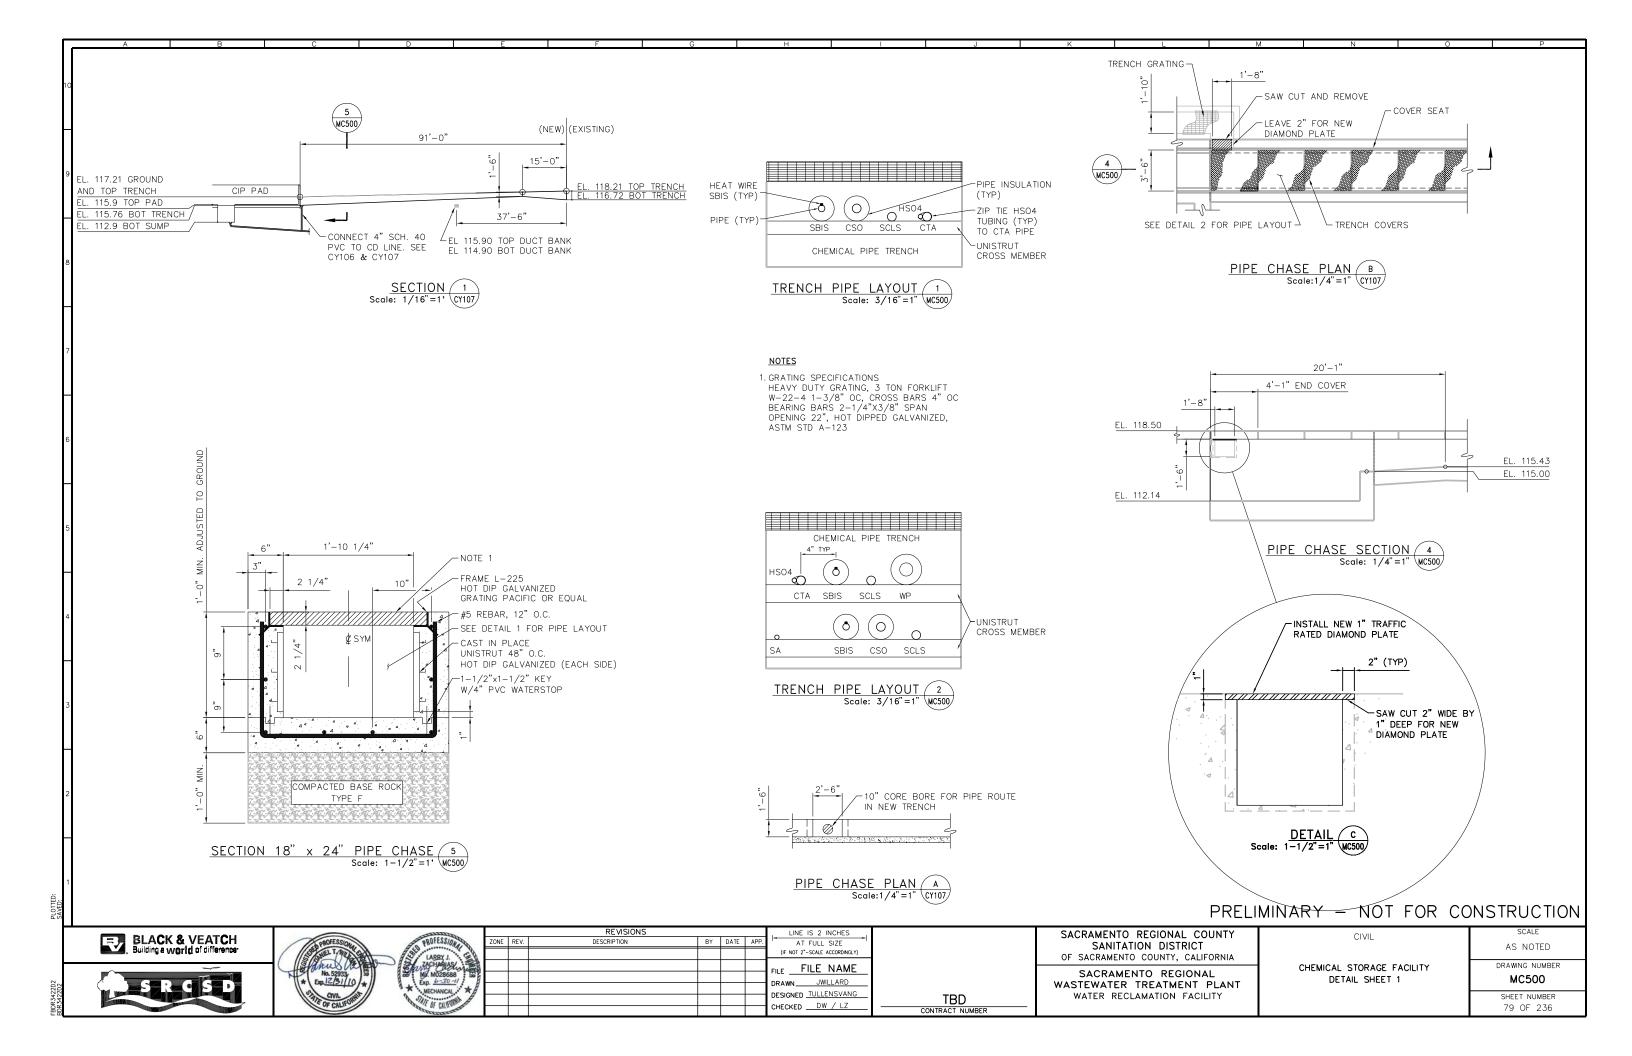


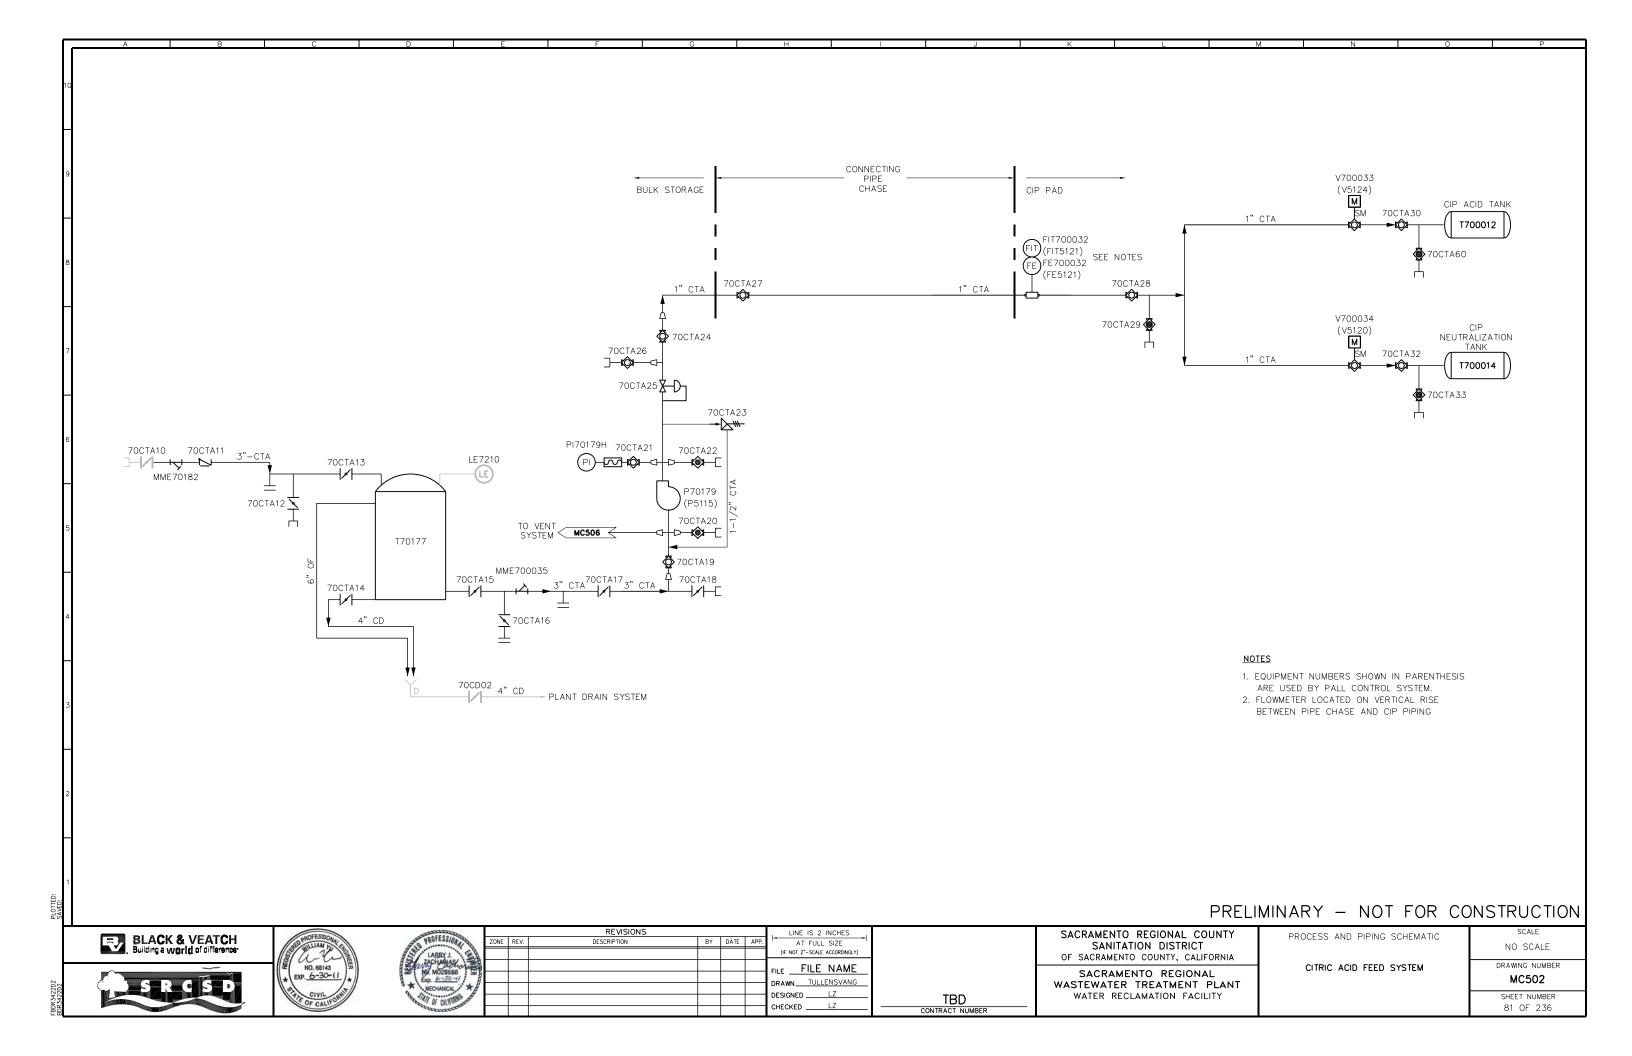


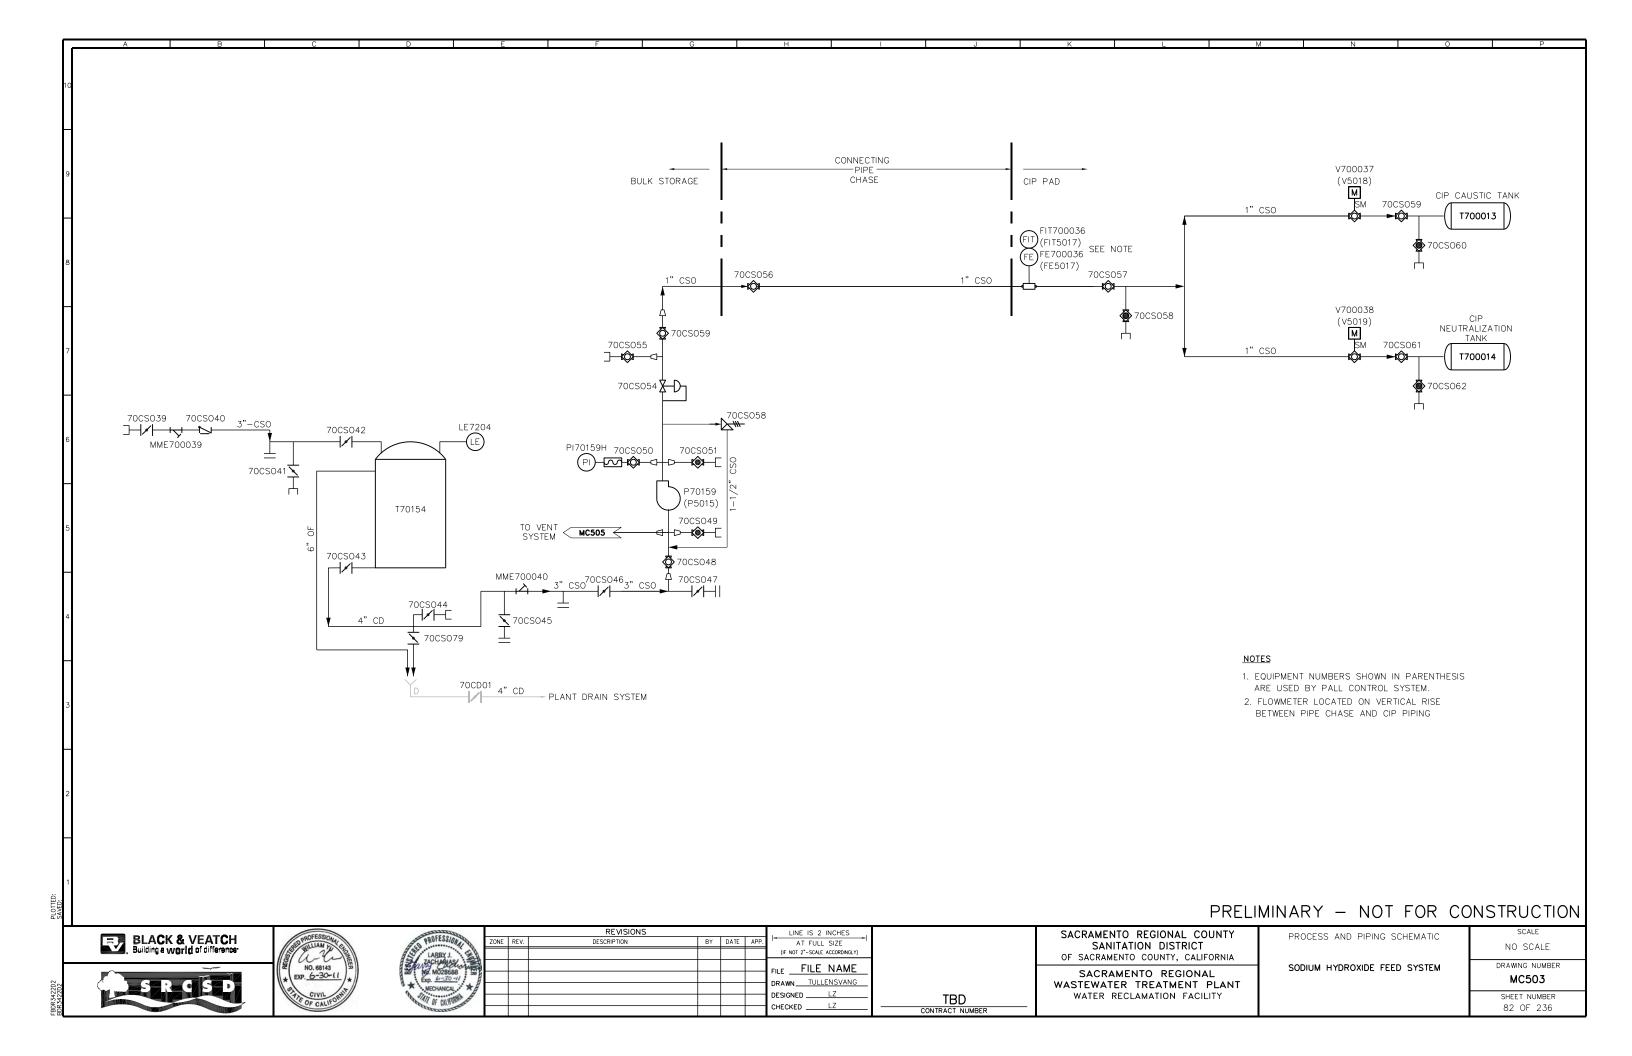

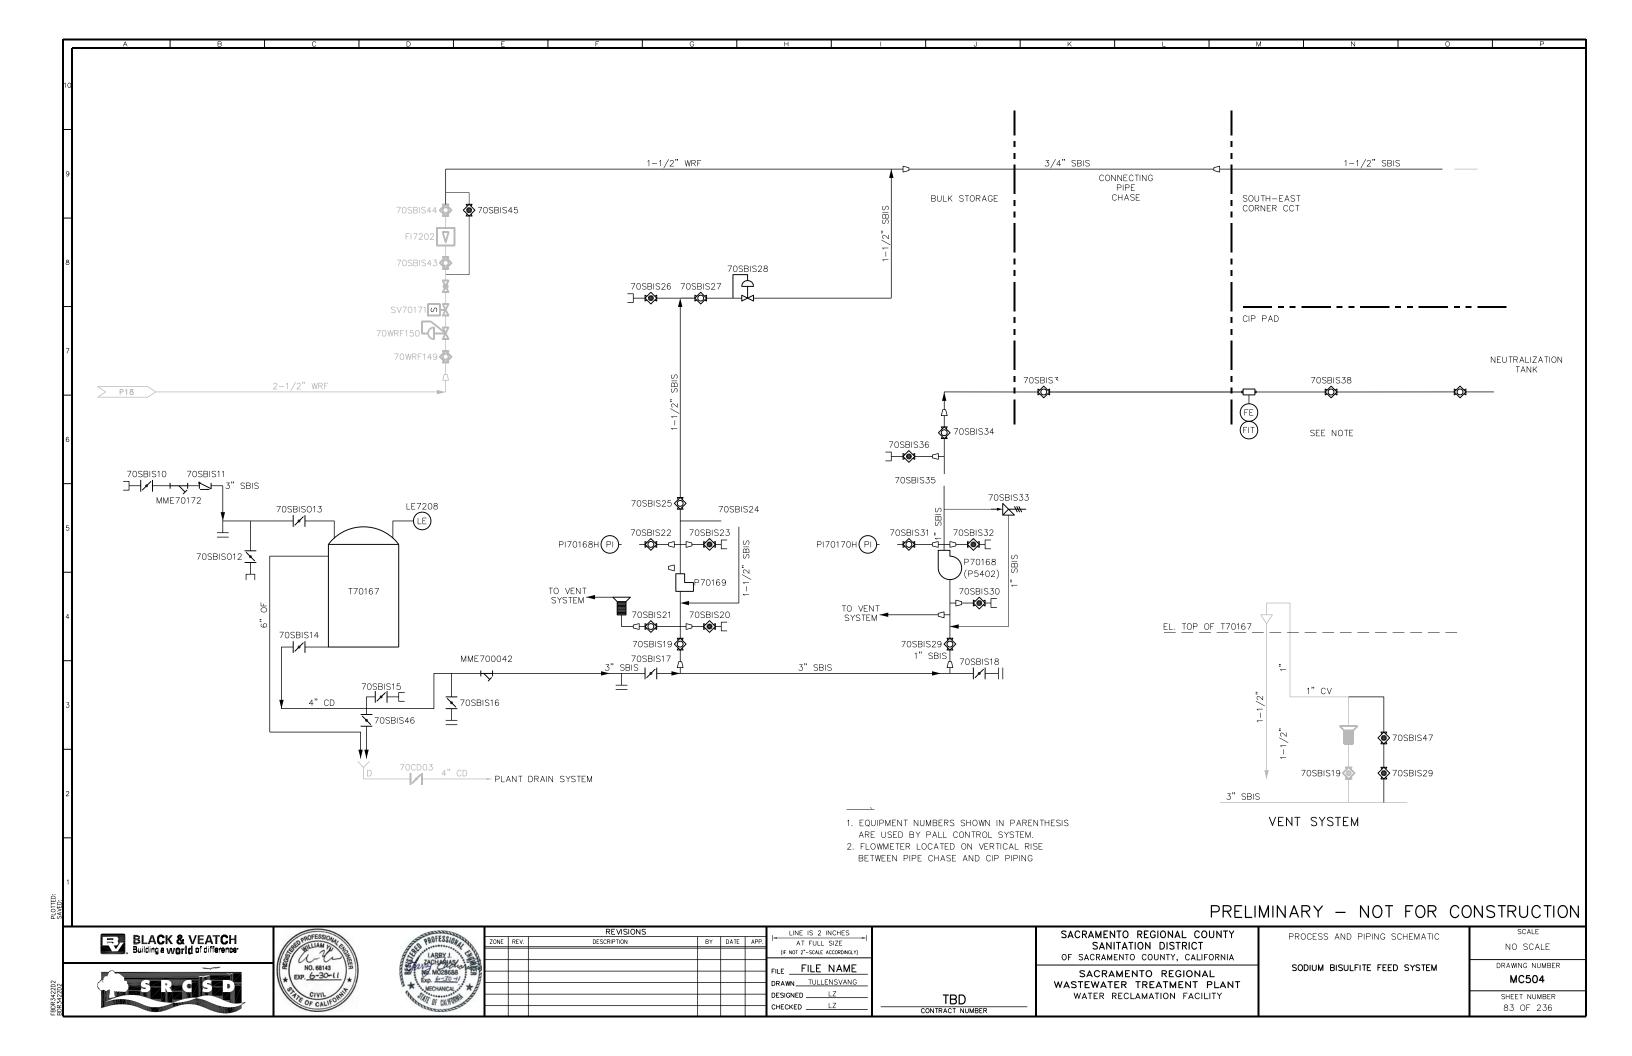

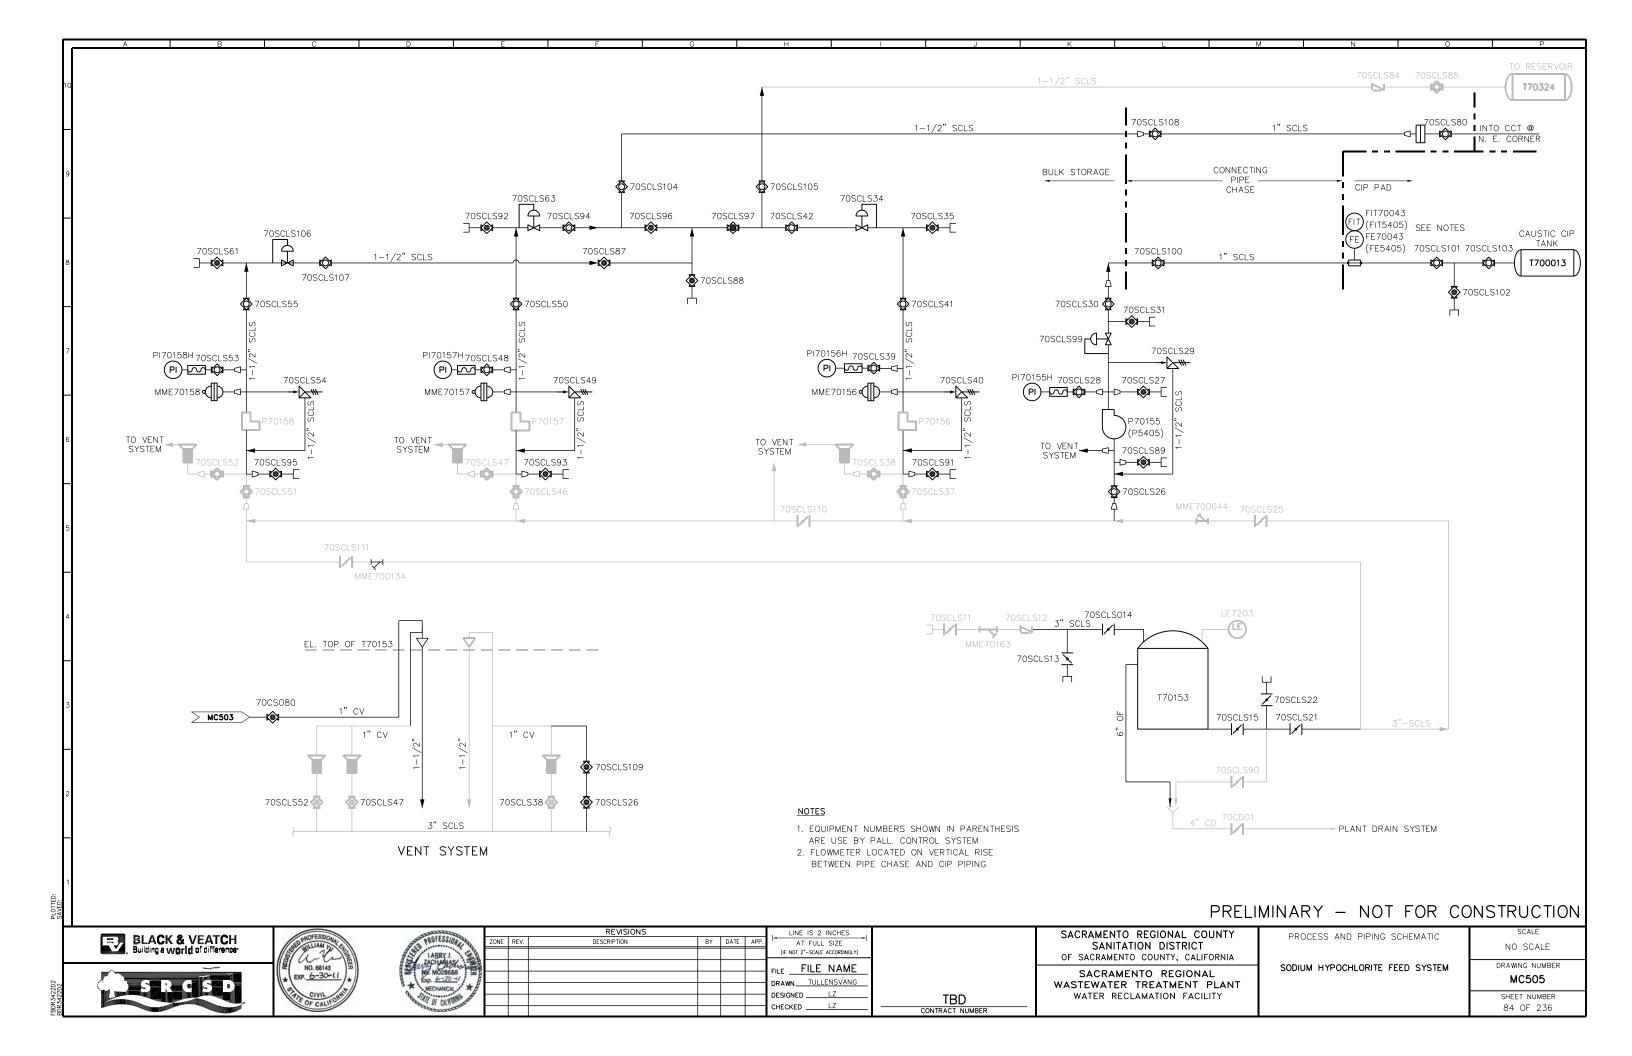

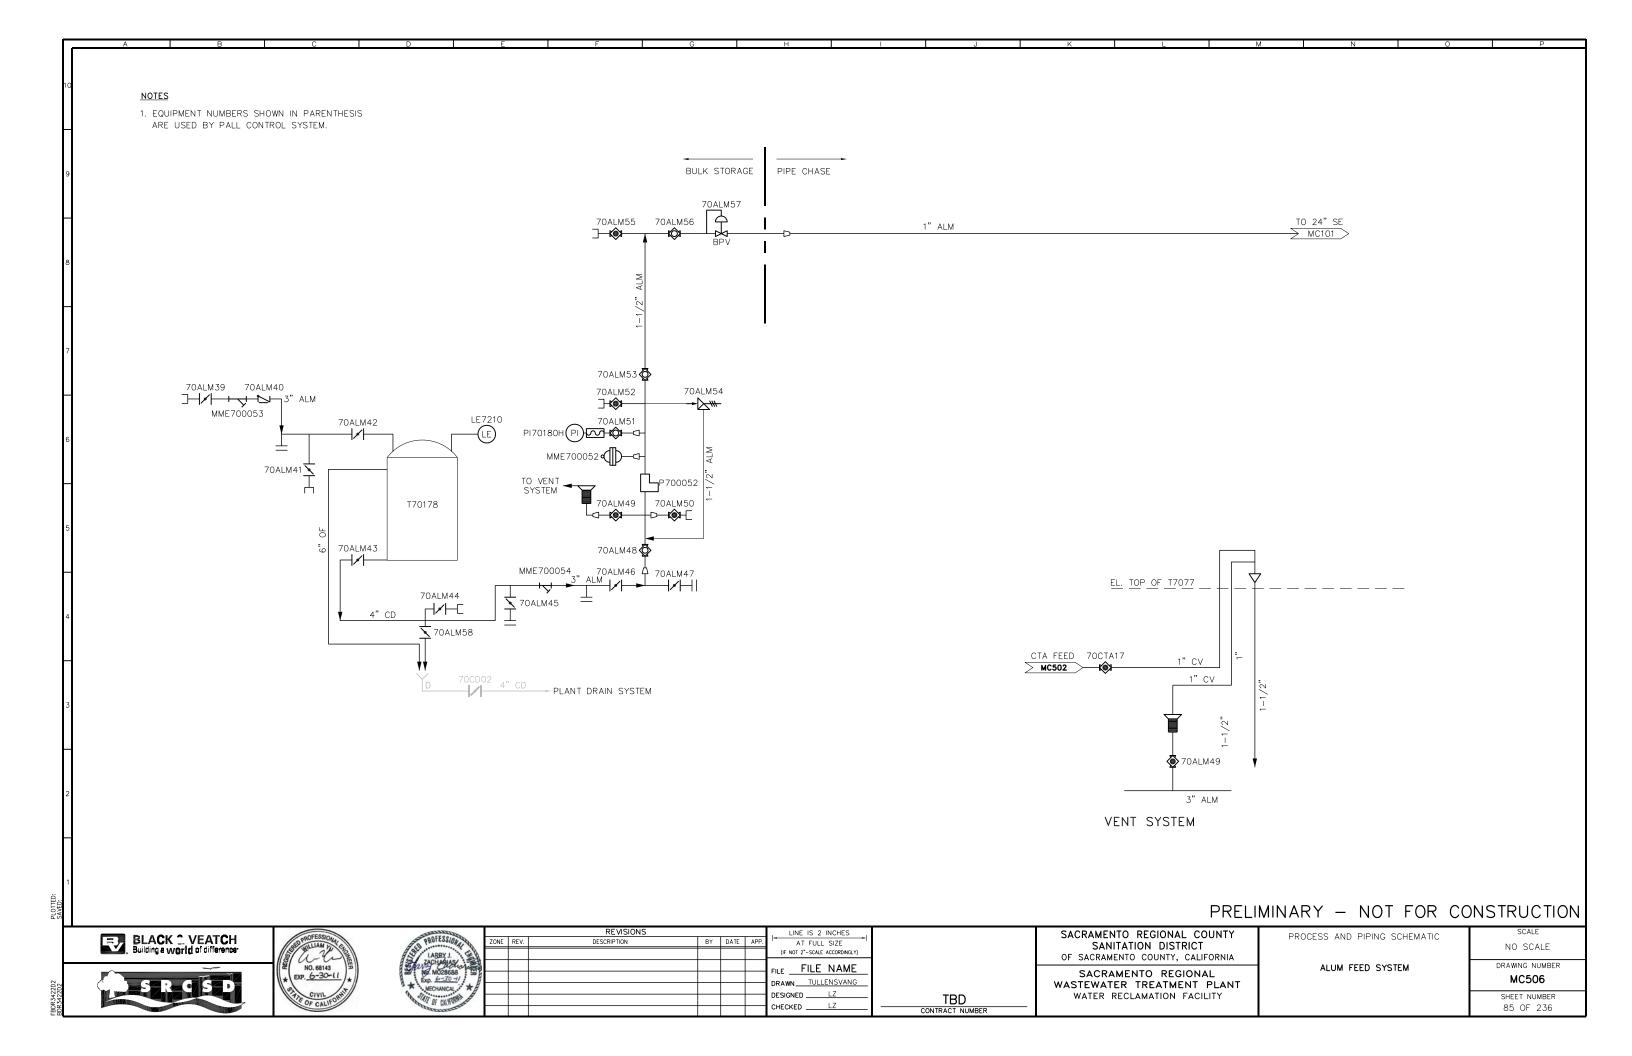

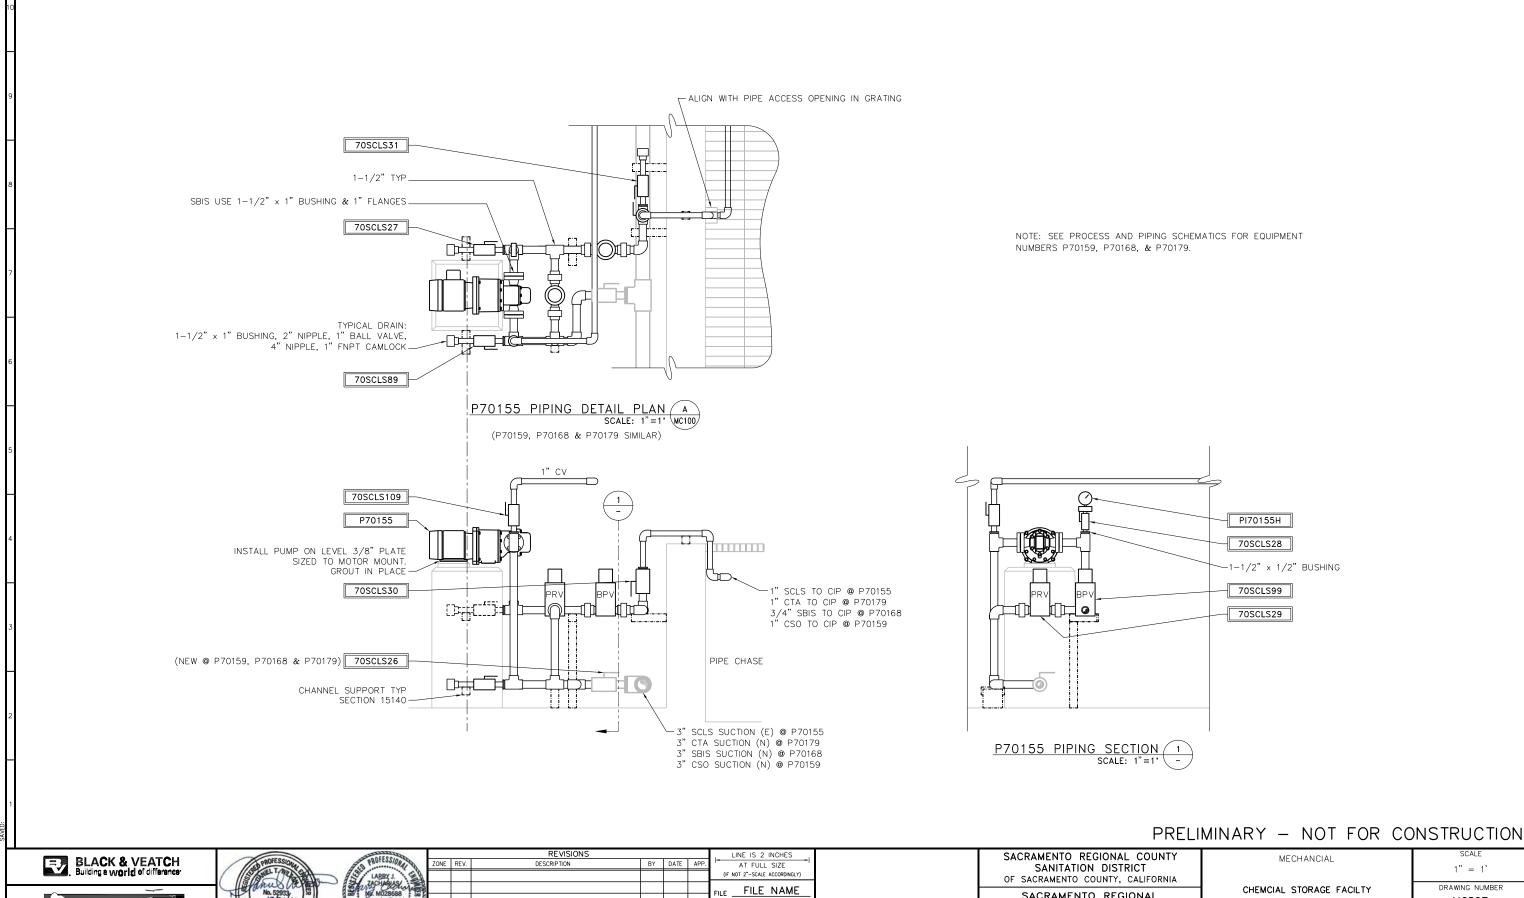

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1" = 1'

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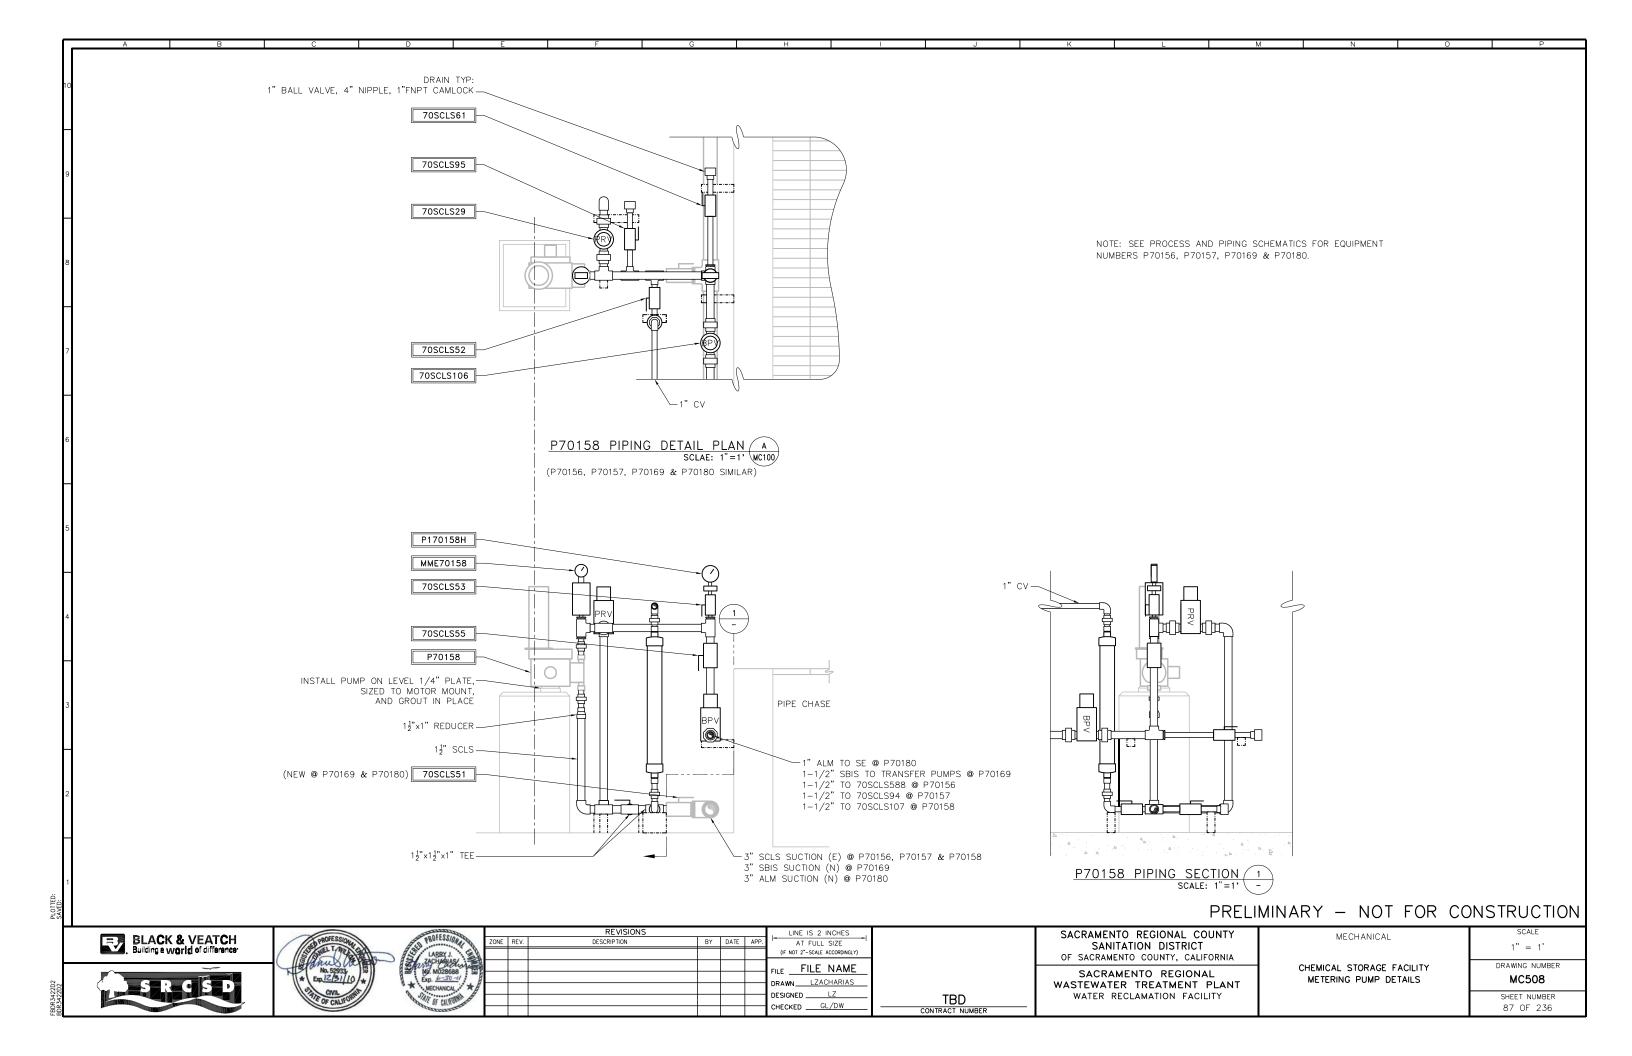
86 OF 236


METERING PUMP DETAILS

SACRAMENTO REGIONAL

WASTEWATER TREATMENT PLANT

WATER RECLAMATION FACILITY



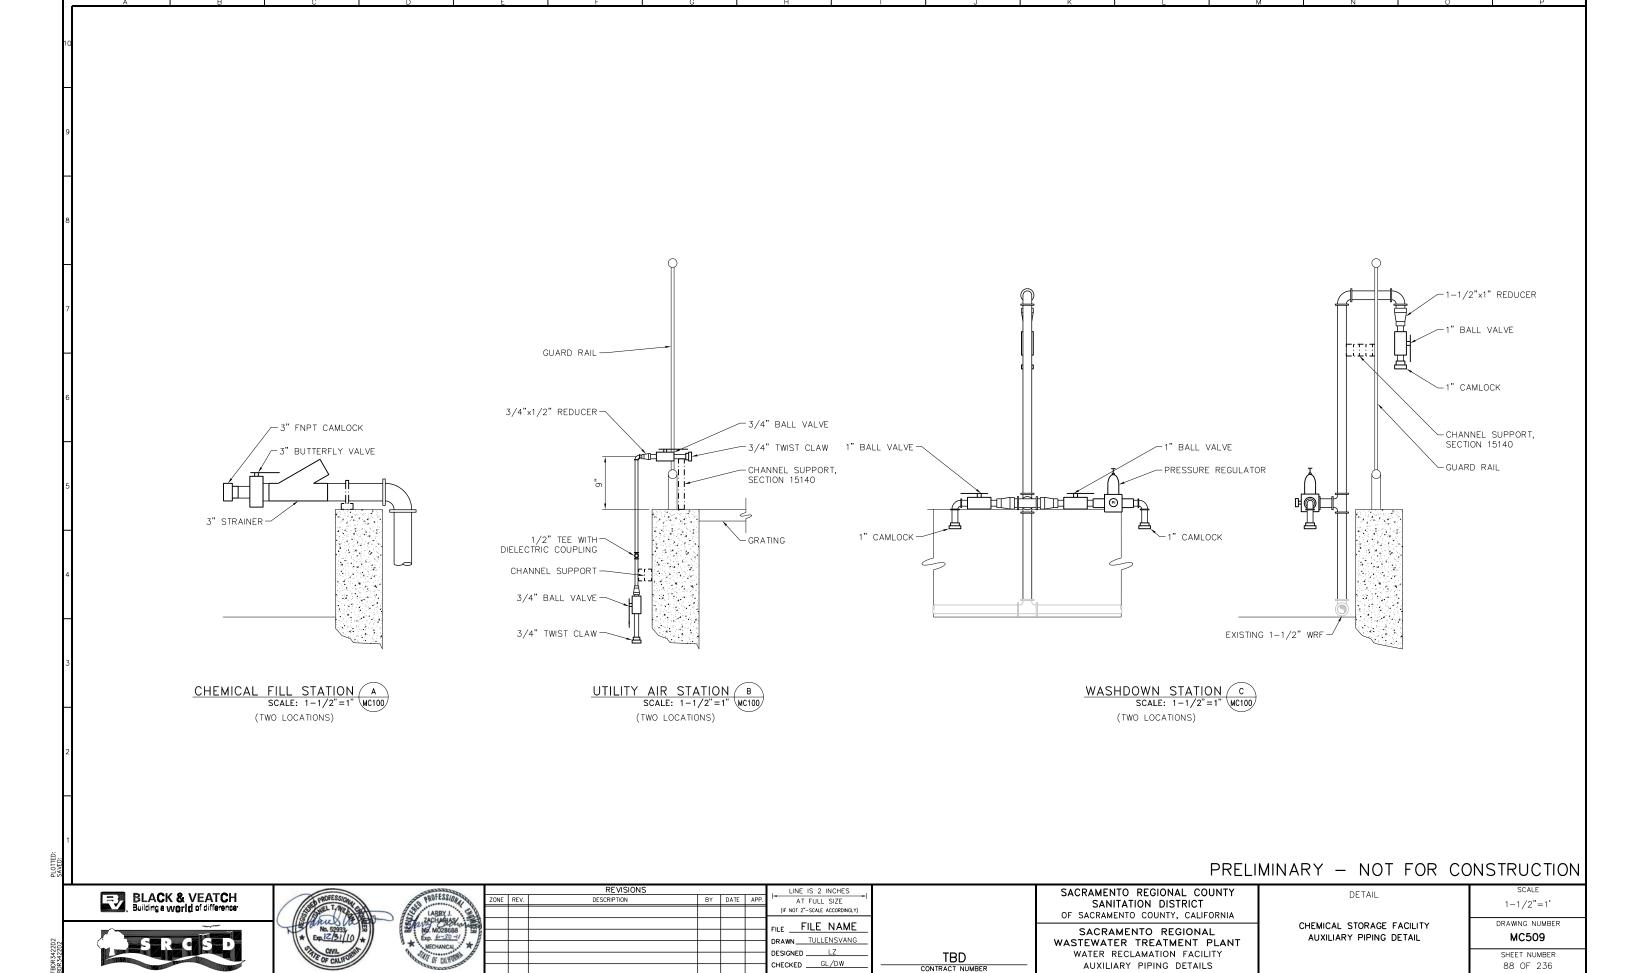

ELECTRICAL ABBREVIATIONS
THE FOLLOWING LIST IS IN ADDITION TO THOSE ABBREVIATIONS DEFINED ON OTHER DRAWINGS

RKFAIVLION	DEFINITION	ABBREVIATION	DEFINITION	ABBREVIATION	DEFINITION	ABBREVIATION	DEFINITION	ABBREVIATION DEFINITION	
	AMDEDES AMMETED		EORCED AIR COOLED	l _M	MOTOR, MOTOR CONTACTOR	SCB	SILICON CONTROLLED DECTIFED	Z IMPEDANCE	
0	AMPERES, AMMETER	FA	FORCED AIR COOLED		· · · · · · · · · · · · · · · · · · ·	SCR	SILICON CONTROLLED RECTIFER		IMIT) CWITOLI
	ALTERNATING CURRENT	FDR	FEEDER	MA	MILLIAMPERE		(D-C DRIVE)	ZS POSITION (I	IMIT) SWITCH
	AMPERE FRAME	FIN	FINISHED	MAX	MAXIMUM	SCH	SCHEDULE		
=	ABOVE FINISHED FLOOR	FLEX	FLEXIBLE	MCC	MOTOR CONTROL CENTER	SEC	SECONDARY, SECONDS		
)	AMPERES INTERRUPTING CAPACITY	FM	FREQUENCY METER	MCP	MOTOR CIRCUIT PROTECTOR	SEL	SELECTOR		
	ALUMINUM	FS	FLOW SWITCH	MCM	THOUSAND CIRCULAR MILLS	SH	SHIELDED		
2	ALARM RELAY	FUT	FUTURE	MH	MANHOLE	SP	SET POINT, SINGLE POLE		
S	AMMETER SELECTOR SWITCH	FVNR	FULL VOLTAGE NON REVERSING	MIN	MINIMUM	SPEC	SPECIFICATIONS		
-	AMPERE TRIP	FVR	FULL VOLTAGE REVERSING	MOV	MOTOR OPERATED VALVE	SPDT	SINGLE POLE DOUBLE THROW		
JTO.	AUTOMATIC			MPC	MINI-POWER CENTER	SPST	SINGLE POLE SINGLE THROW		
JX	AUXILIARY			MR	MOTOR CONTACTOR RELAY	ST	SHORT TIME		
NG	AMERICAN WIRE GAUGE			MTD	MOUNTED	s/s	SELECTOR SWITCH		
,,,	TWENTONIX TIME ONOGE	G	GROUND CONDUCTOR, GENERATOR	MTG HT	MOUNTING HEIGHT	SUB	SUBSTATION		
		GALV	GALVANIZED	MTR	MOTOR	SV	SOLENOID VALVE		
		GDR	GROUNDING RESISTOR	MV	MILLIVOLTS	SW	SWITCH		
^	DADE CORRED CONDUCTOR		GENERATOR	IVIV	MILLIVOLIS		SWITCHBOARD		
C	BARE COPPER CONDUCTOR	GEN				SBD			
		GFI	GROUND FAULT INTERRUPTER			SWR	SWITCHGEAR		
		GFR	GROUND FAULT RELAY						
		GND	GROUND	N .	NEUTRAL	1			
:AP	CAPACITOR	GRS	GALVANIZED RIGID STEEL	N/A	NOT APPLICABLE	1			
В	CIRCUIT BREAKER	1		NC	NORMALLY CLOSED	TACH	TACHOMETER		
KT	CIRCUIT	1		NEC	NATIONAL ELECTRIC CODE	TB	TERMINAL BLOCK, TERMINAL BOX		
٧D	CONDUIT	1		NEG	NEGATIVE	TC	TIME CLOCK, TIME CONTROLLER, THERMOCOUPLER		
OMPT	COMPARTMENT	H/A	HAND/AUTO	NF	NON FUSED	TCD	TIME CLOSING ON DEENERGIZATION		
DR	CONDUCTOR	HOA	HAND/OFF/AUTO	NIC	NOT IN CONTRACT	TCE	TIME CLOSING ON ENERGIZATION		
_S	CURRENT LIMITING FUSE	HH	HANDHOLE	NO	NORMALLY OPEN	TDAD	TIME DELAY AFTER DEENERGIZATION (OFF-DELAY)		
_S DAX	COAXIAL CABLE	HID	HIGH INTENSITY DISCHARGE	NP NP	NAMEPLATE	TDAE	TIME DELAY AFTER ENERGIZATION (OFF-DELAY)		
			HORSEPOWER	NTS	NOT TO SCALE	TDR	,		
ONT/CNTL	CONTROL	HP		INID	NOT TO SCALE		TIME DELAY RELAY		
DNTD	CONTINUED	HS	HAND STATION			TEL	TELEPHONE, TELEMETRY		
PNL	CONTROL PANEL	HT	HEIGHT			TEMP	TEMPERATURE		
PT	CONTROL POWER TRANSFORMER	HTR	HEATER			TFR	TRANSFORMER		
R	CONTROL RELAY OR CONDUIT RACK	HV	HIGH VOLTAGE (GENERALLY ABOVE 600V)	OA	SELF COOLED, OUTSIDE AIR	TOD	TIME OPENING ON DEENERGIZATION		
Т	CURRENT TRANSFORMER OR CABLE TRAY	HZ	HERTZ (CYCLES PER SECOND)	OC	OVER CURRENT	TODB	TOP OF DUCT BANK		
U	COPPER	1		OL'S	OVERLOADS	TOE	TIME OPENING ON ENERGIZATION		
		1				TR	TRIAD OR 3 CONDUCTOR		
		1				TSP	TWISTED SHIELDED PAIR		
		INCAND	INCANDESCENT			TYP	TYPICAL		
В	DIRECT BURIAL, DUCT BANK	INST	INSTANTANEOUS	P	POLE, PHASE	1			
C	DIRECT CURRENT	INSTR	INSTRUMENT	PA	PUBLIC ADDRESS				
CP	DIRECT CURRENT POWER SUPPLY	INTLK	INTERLOCK	PB	PULL BOX, PUSH BUTTON	1			
ET	DETAIL	IS	CURRENT SWITCH	PC	PROGRAMMABLE CONTROLLER	UG	UNDERGROUND		
IAG	DIAGRAM	13	COMMENT SWITCH	PCR	PC INTERNAL RELAY EQUIVALENT WITH	UON	UNLESS OTHERWISE NOTED		
		1		FCK	•	UUN	UNLLOS UTHERWISE NUTEU		
ISC	DISCONNECT	1		I 51.5	INTERLOCK OR OUTPUT FUNCTIONS	1			
PDT	DOUBLE POLE DOUBLE THROW	1	WWW.TION DOW	PLC	PROGRAMMABLE LOGIC CONTROLLER	1			
S	DISCONNECT SWITCH	JB	JUNCTION BOX	PNL	PANEL: CONTROL, INSTRUMENT OR DISTRIBUTION				
NG	DRAWING	1		POS	POSITIVE	V	VOLTMETER		
		1		PP	POWER PANEL	VA	VOLT-AMPS		
		1		PR	PAIR	VFC	VARIABLE FREQUENCY CONTROLLER		
		KCMIL	THOUSAND CIRCULAR MILLS	PRI	PRIMARY	VS	VOLTMETER SELECTOR SWITCH		
	ELEVATION	KVA	KILOVOLT-AMPERES	PS	PRESSURE SWITCH	VSC	VARIABLE SPEED COUPLING		
/ER	EMERGENCY	KVAR	KILOVOLT-AMPERES REACTIVE	PT	POTENTIAL TRANSFORMER				
иT	ELECTRICAL METALLIC TUBING	KW	KILOWATTS	PTT	PUSH TO TEST	1			
VCL	ENCLOSURE/ENCLOSED	KWH	KILOWATT HOUR	PVC	POLYVINYLCHLORIDE	1			
PR	ETHYLENE PROPYLENE RUBBER	I IXIIII	MESMAIT HOOK	PWR	POWER	w/	WITH		
		1		F WIL	I OWEN	W/ WM			
QUIP	EQUIPMENT	1					WATTMETER		
ΓM	ELAPSE TIME METER		LIQUEING CONTACTOR			W/O	WITHOUT		
(H	EXHAUST	LC	LIGHTING CONTACTOR	1 _		WP	WEATHERPROOF		
KIST	EXISTING	LO	LUGS ONLY	R	REMOTE	WTD	WINDING TEMPERATURE DETECTOR		
(P	EXPLOSION PROOF	LOR	LOCAL-OFF-REMOTE	RECP	RECEPTACLE	WW	WIREWAY		
		LOS	LOCK-OUT STOP	REQD	REQUIRED	1			
		LP	LIGHTING PANEL	RES	RESISTOR				
		LS	LEVEL SWITCH	RMS	ROOT MEAN SQUARE	1			
		LT	LONG TIME	RTD	RESISTANCE TEMPERATURE DETECTOR	XSW	AUTOMATIC TRANSFER SWITCH		
		LTG	LIGHTING	RVNR	REDUCED VOLTAGE NON-REVERSING	1		GENERAL NOTES:	
		LV	LOW VOLTAGE (GENERALLY BELOW 600V)	1		1		FOR EQUIPMENT NU	IMBER PREFIXES RE
Terada Engir		"	20 VOLINGE (GENERALLI DELON GOOV)			1		DRAWING GG00X.	
1570 The Alame Suite 221						1			
San Jose,Callfor (408) 294-1445	rnla 95126						PRELIMINAR`	- NOT FOR	CONSTRUC
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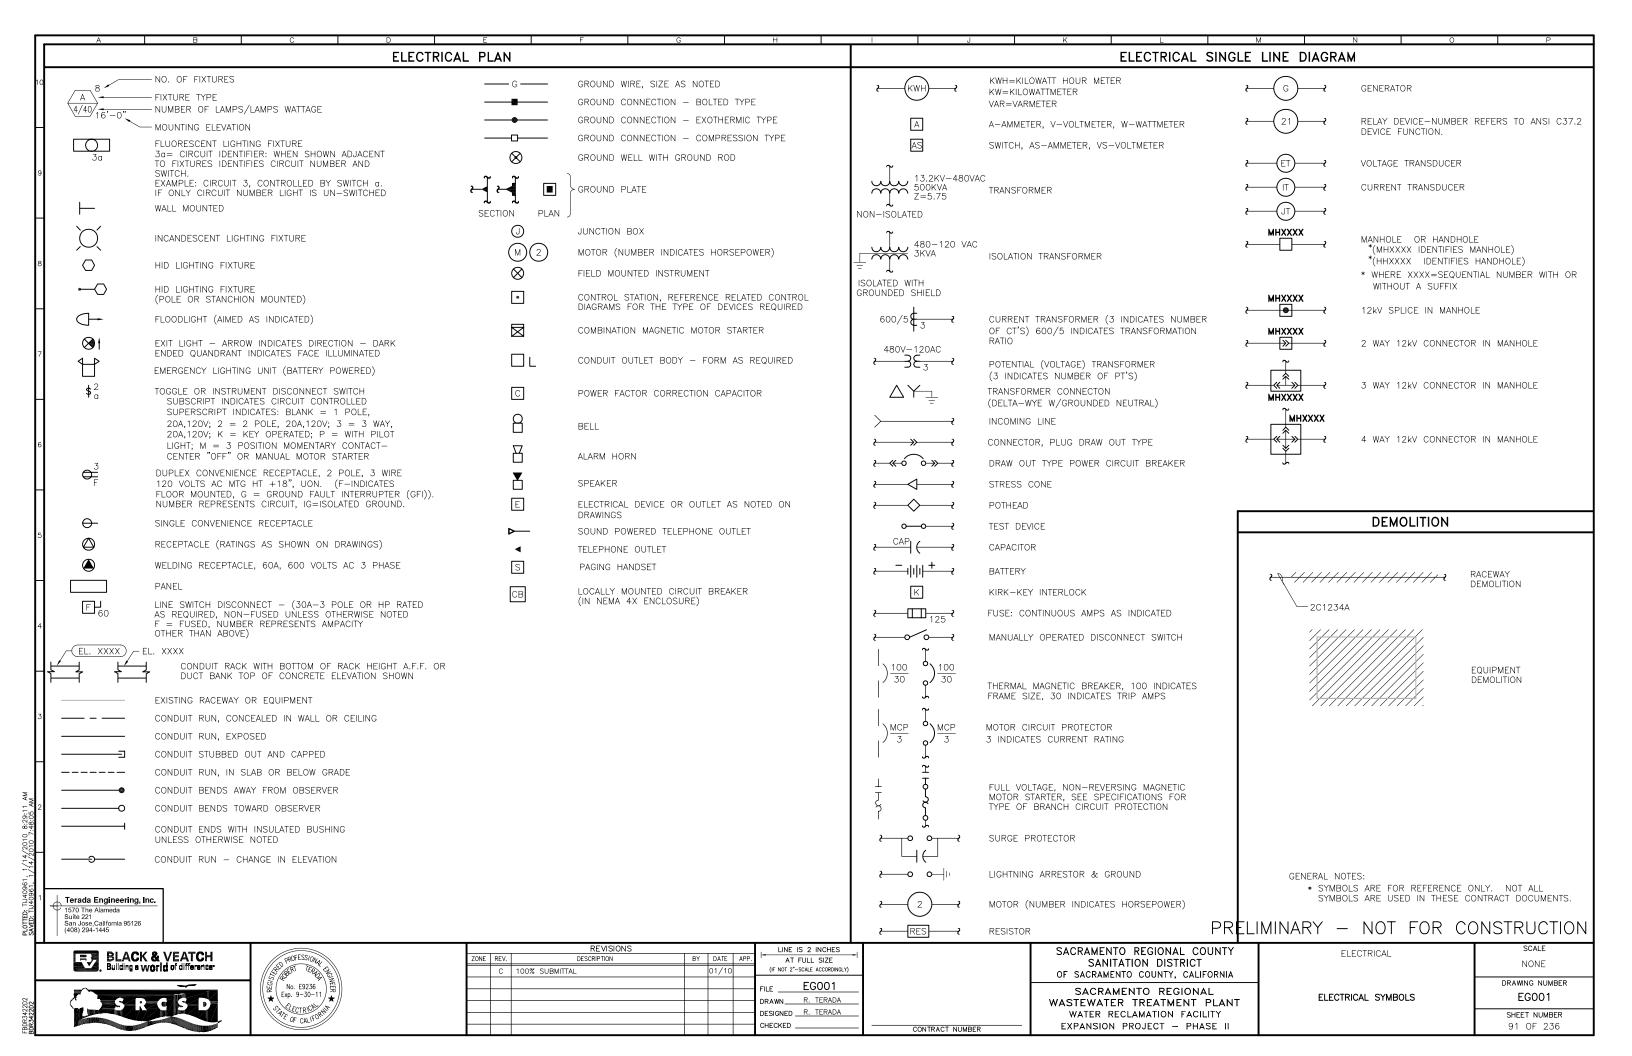
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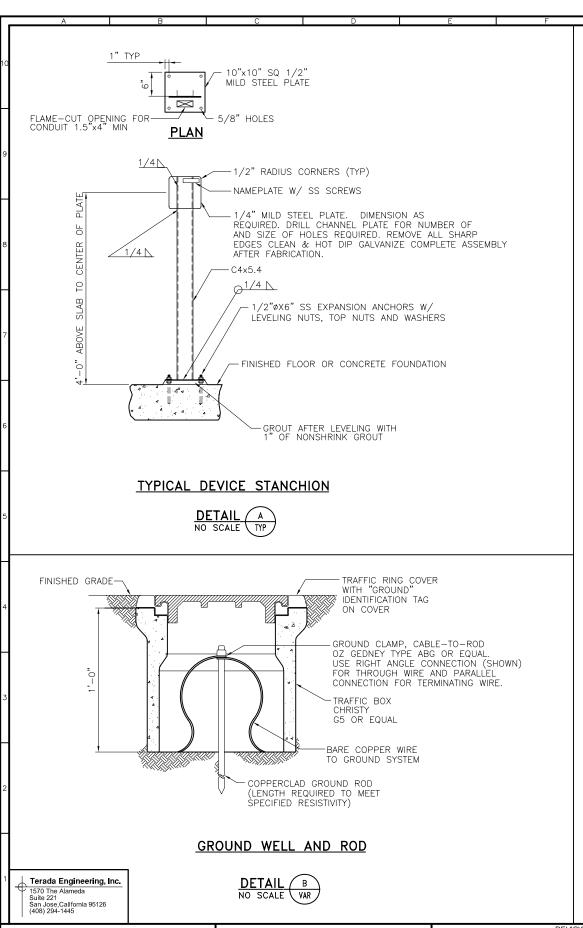
SANITATION DISTRICT	
OF SACRAMENTO COUNTY, CALIFORNIA	
SACRAMENTO REGIONAL	


CONTRACT NUMBER

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ACRAMENTO REGIONAL EWATER TREATMENT PLANT ELEC	TRICA
TER RECLAMATION FACILITY	
ANSION PROJECT — PHASE II	

ELECTRICAL	SCALE
	NONE
	DRAWING NUMBER
ICAL ABBREVIATIONS	EG000
	SHEET NUMBER
	00 05 070





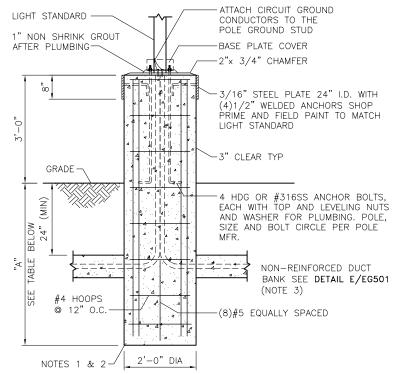

NOTES:

- 1. FOUNDATION TO BEAR AGAINST ORIGINAL SOIL OR 95% COMPACTED BACKFILL PER SECTION 02200.
- 2. CLASS 1 CONCRETE PER SECTION 03300.
- 3. OMIT THE DUCT BANK GROUND CONDUCTOR ON FIXTURE CIRCUITS.

POLE HEIGHT	EMBEDMENT "A"
10'-0"	4'-6"
20'-0"	6'-6"
30'-0"	8'-6"
40'-0"	11'-0"

LIGHT STANDARD BASE

DETAIL C NO SCALE VAR

CONTRACT NUMBER

PRELIMINARY - NOT FOR CONSTRUCTION

ELECTRICAL








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ZONE	REV.	DESCRIPTION	BY	DATE	APP.	AT FULL SIZE
	С	100% SUBMITTAL		01/10		(IF NOT 2"-SCALE ACCORDINGLY)
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						DESIGNED R. TERADA
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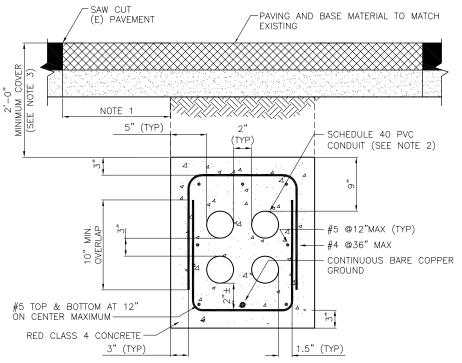
SACRAMENTO REGIONAL COUNTY SANITATION DISTRICT OF SACRAMENTO COUNTY, CALIFORNIA

SACRAMENTO REGIONAL WASTEWATER TREATMENT PLANT WATER RECLAMATION FACILITY EXPANSION PROJECT - PHASE II

CONSTRUCTION DETAILS 1

NONE DRAWING NUMBER EG500 SHEET NUMBER 92 OF 236




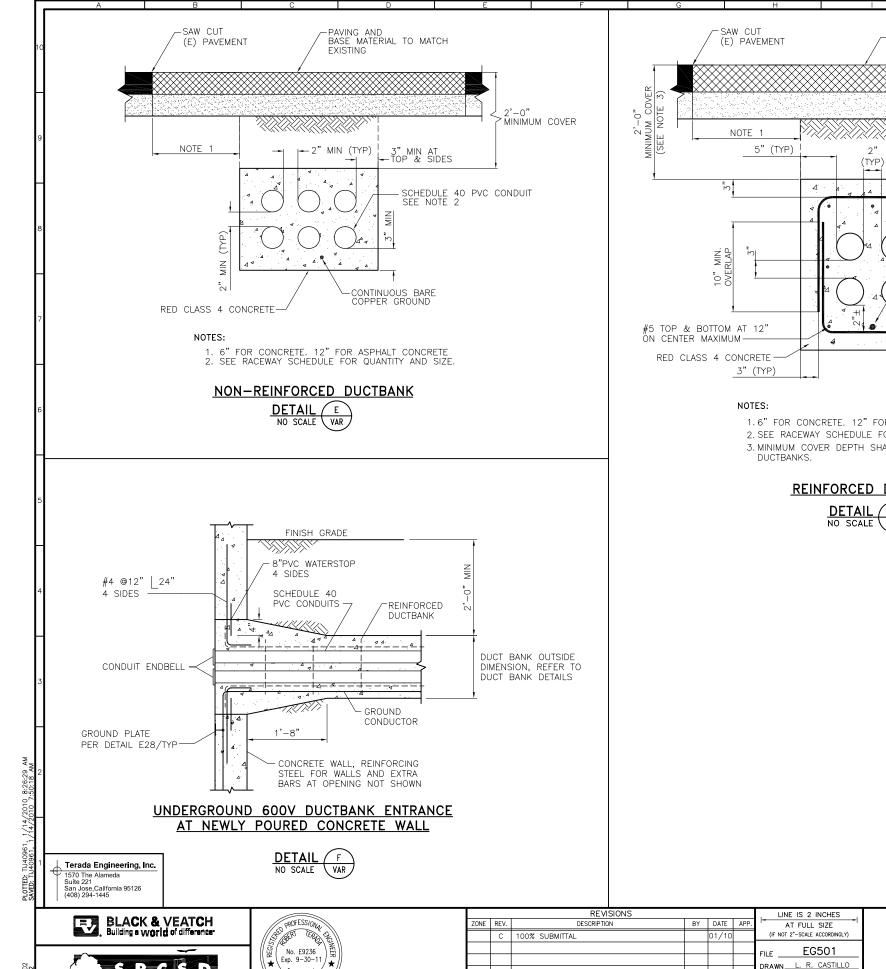

- 1.6" FOR CONCRETE. 12" FOR ASPHALT CONCRETE.
- 2. SEE RACEWAY SCHEDULE FOR QUANTITY AND SIZE.
- 3. MINIMUM COVER DEPTH SHALL BE 36" FOR MEDIUM VOLTAGE


REINFORCED DUCTBANK

DETAIL G NO SCALE VAR

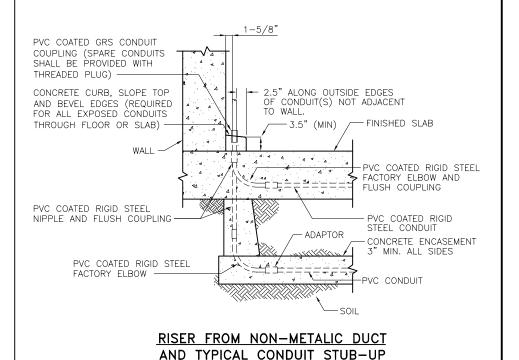

DETAIL

NO SCALE VAR

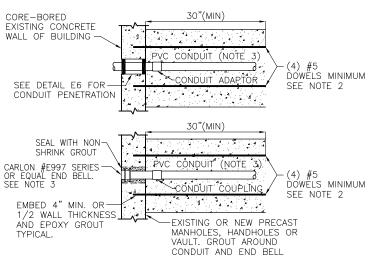

- 1. PROVIDE DOWELS FROM ALL EXISTING STRUCTURES, AND EXISTING
- OR NEW PRECAST MANHOLES, HANDHOLES AND VAULTS.
 2. THE DOWELS SHALL MATCH THE LONGITUDINAL DUCT BANK
- REINFORCING. 3. PVC ENDBELL SHALL BE SCHEDULE 40 OR 80 TO MATCH DUCTBANK CONDUIT. AFTER INSTALLATION TRIM END BELL
- INSIDE EDGE FLUSH WITH THE CONDUIT INSIDE DIAMETER.

UNDERGROUND DUCTBANK ENTRANCE **DETAIL**

NO SCALE VAR PRELIMINARY - NOT FOR CONSTRUCTION





		REVISIONS				, LINE IS 2 INCHES ,
ZONE	REV.	DESCRIPTION	BY	DATE	APP.	AT FULL SIZE
	C	100% SUBMITTAL		01/10		(IF NOT 2"-SCALE ACCORDINGLY)
						FILE EG501
						DRAWN_ L. R. CASTILLO
						DESIGNED R. TERADA
						CHECKED

SANITATION DISTRICT

CONTRACT NUMBER

OF SACRAMENTO COUNTY, CALIFORNIA SACRAMENTO REGIONAL WASTEWATER TREATMENT PLANT WATER RECLAMATION FACILITY


SACRAMENTO REGIONAL COUNTY


EXPANSION PROJECT - PHASE II

CONSTRUCTION DETAILS 2


ELECTRICAL

SCALE NONE DRAWING NUMBER EG501 SHEET NUMBER 93 OF 236

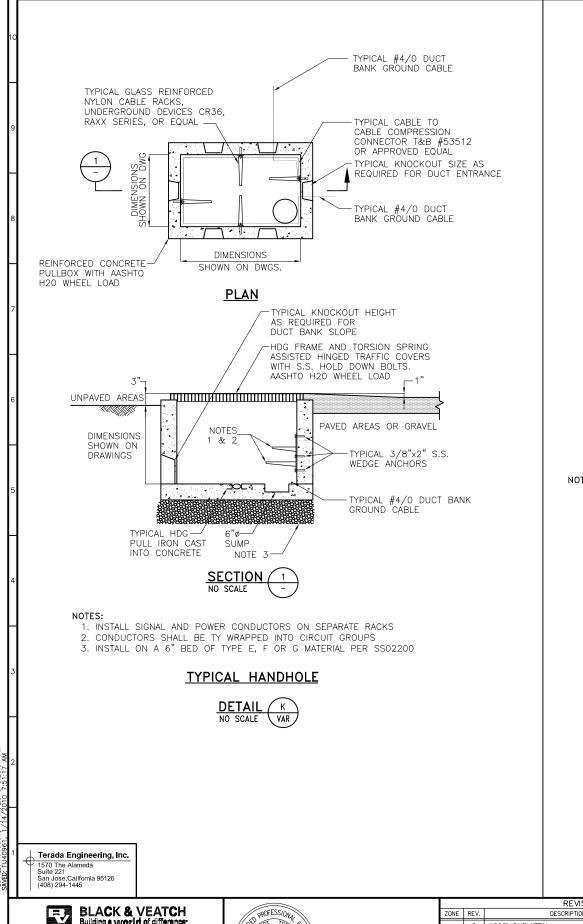

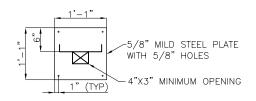


NO SCALE (-

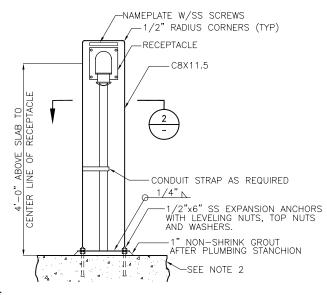

- . Drill for device mounting holes as required. . Construct 1'-6"ø x 3'-0" deep concrete foundation
- WHERE CONCRETE SURFACE IS NOT AVAILABLE. SEE DETAIL M/-.
- 3. USE 304 SS HARDWARE FOR DEVICE MOUNTING. 4. GRIND SHARP EDGES AND HOT DIP GALVANIZE AFTER FABRICATION.

480V, 3"ø RECEPTACLE STANCHION

DETAIL (L NO SCALE VAR

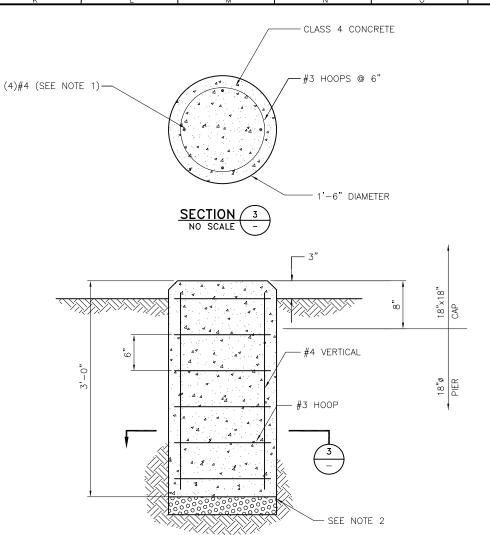

- 1. LOCATE #4 VERTICALS AT SQUARE CORNER POSITIONS.
- 2. INSTALL "3" OF TYPE F MATERIAL COMPACTED TO 95%.

REINFORCED CONCRETE BASE

PRELIMINARY - NOT FOR CONSTRUCTION







			REVISIONS	, LINE IS 2 INCHES ,			
	ZONE	REV.	DESCRIPTION	BY	DATE	APP.	AT FULL SIZE
		С	100% SUBMITTAL		01/10		(IF NOT 2"-SCALE ACCORDINGLY)
							FILE EG502
							DRAWN L. R. CASTILLO
							DESIGNED R. TERADA
							520,0,125
ı							CHECKED

SACRAMENTO REGIONAL COUNTY SANITATION DISTRICT OF SACRAMENTO COUNTY, CALIFORNIA

CONTRACT NUMBER


SACRAMENTO REGIONAL WASTEWATER TREATMENT PLANT WATER RECLAMATION FACILITY EXPANSION PROJECT - PHASE II


ELECTRICAL

NONE DRAWING NUMBER EG502 SHEET NUMBER

CONSTRUCTION DETAILS 3


94 OF 236

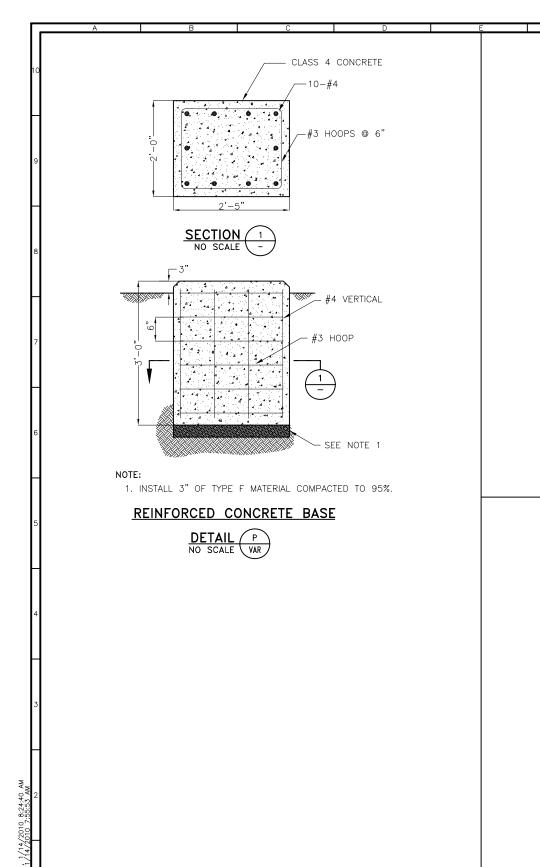


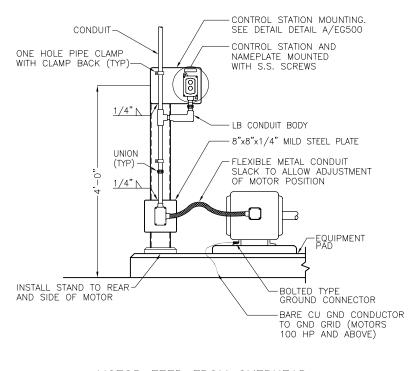

MOTOR FEED FROM OVERHEAD

DETAIL Q NO SCALE VAR

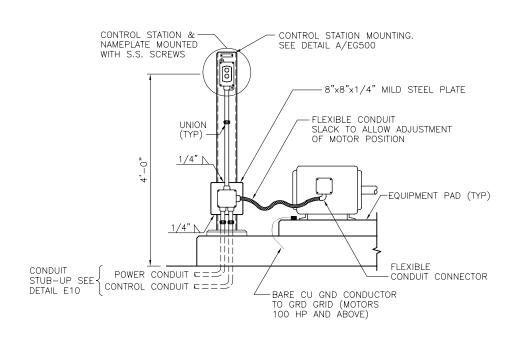

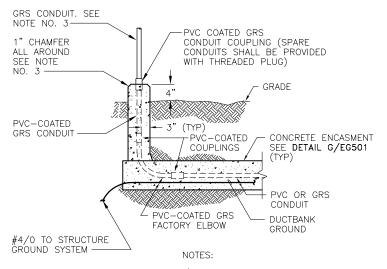

- 1.) SLOPE UG CONDUITS TOWARD HANDHOLE/
- 2.) PROVIDE PVC-COATED GRS CONDUITS, HUBS, AND FITTINGS IN CORROSIVE AREAS.
- 3.) PROVIDE CHAMFER ON 3 SIDES WHEN THE DUCTBANK OR CONDUITS STUB UP AT

DUCTBANK STUB-UP



LOW VOLTAGE FEED FROM BELOW SLAB POWER AND CONTROL CONDUITS

DETAIL VAR

CONTRACT NUMBER

PRELIMINARY - NOT FOR CONSTRUCTION

CONSTRUCTION DETAILS 4



Terada Engineering, Inc.

San Jose, California 95126 (408) 294-1445

1570 The Alameda Suite 221




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						FILE EG503	
						DRAWN L. R. CASTILLO	
						DESIGNED R. TERADA	
						CHECKED	_


SACRAMENTO REGIONAL COUNTY SANITATION DISTRICT
OF SACRAMENTO COUNTY, CALIFORNIA
CACRAMENTO DECIONAL


WASTEWATER TREATMENT PLANT WATER RECLAMATION FACILITY EXPANSION PROJECT - PHASE II

ELECTRICAL

NONE DRAWING NUMBER EG503 SHEET NUMBER 95 OF 236

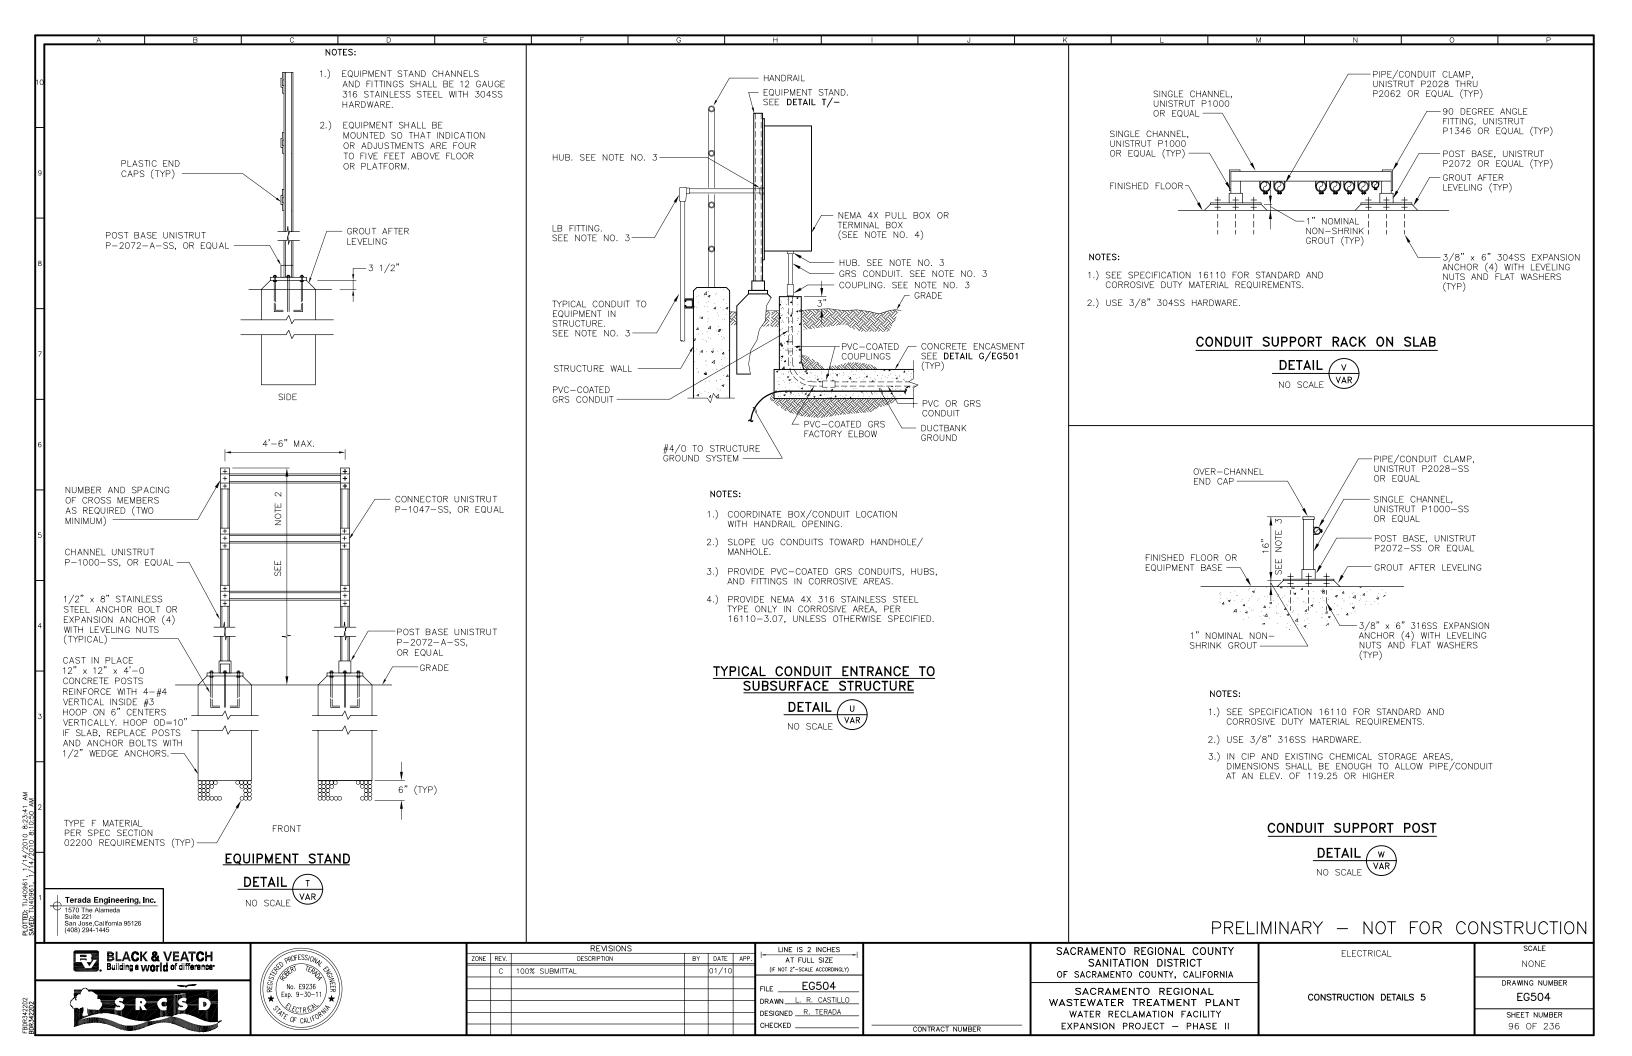

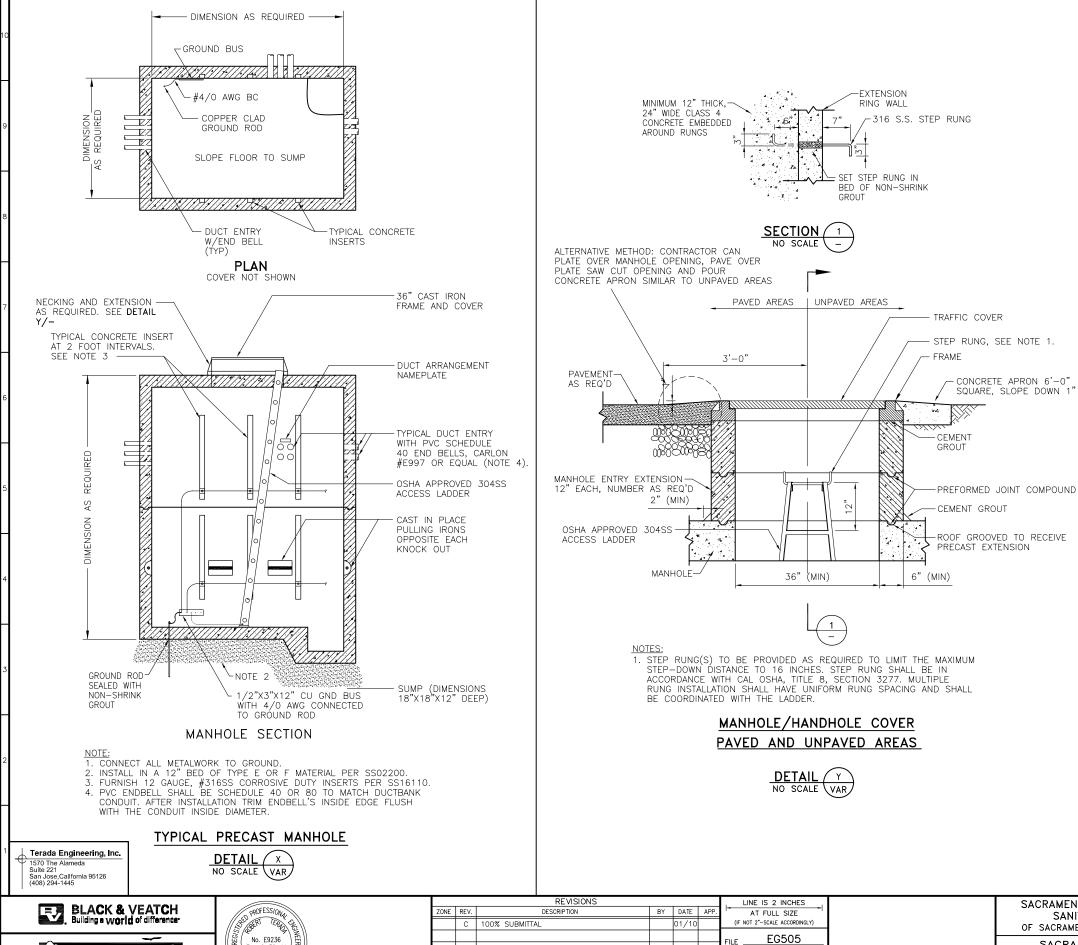

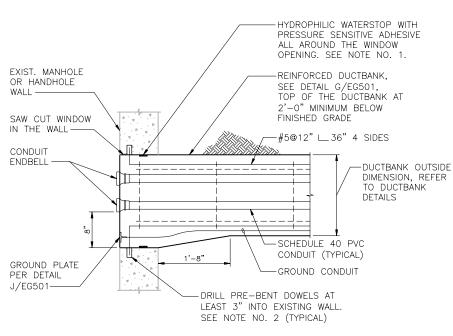

- 1. INSTALL WATERSTOP, GREENSTREAK CJ-0725-3K-ADH OR EQUAL PER MANUFACTURER'S INSTRUCTIONS. CLEAN THE CUT WINDOW OPENING SURFACE THOROUGHLY BEFORE INSTALLATION.
- 2. GROUT DOWELS SECURELY IN PLACE WITH EPOXY ADHESIVE

UNDERGROUND 600V DUCTBANK ENTRANCE AT EXISTING MANHOLE/HANDHOLE WALL

PRELIMINARY - NOT FOR CONSTRUCTION



		KE VISIONS	, LINE IS 2 INCHES ,				
ZONE	REV.	DESCRIPTION	BY	DATE	APP.	AT FULL SIZE	
	С	100% SUBMITTAL		01/10		(IF NOT 2"-SCALE ACCORDINGLY)	
						FILE EG505	
						1122	
						DESIGNED	
						CHECKED	CONTRACT NUMBER


SACRAMENTO REGIONAL COUNTY SANITATION DISTRICT OF SACRAMENTO COUNTY, CALIFORNIA


SACRAMENTO REGIONAL WASTEWATER TREATMENT PLANT WATER RECLAMATION FACILITY EXPANSION PROJECT - PHASE II

CONSTRUCTION DETAILS 6

ELECTRICAL

NONE DRAWING NUMBER EG505 SHEET NUMBER 97 OF 236

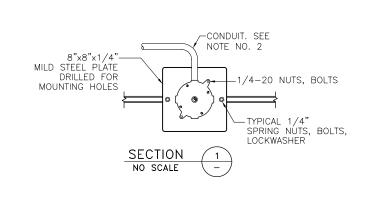


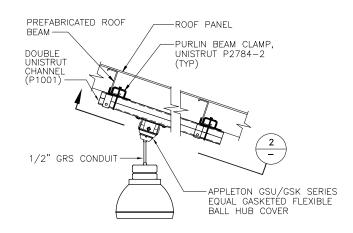


- 1. ALL HARDWARE SHALL BE STAINLESS STEEL.
- 2. ROUTE THE CONDUIT TO THE NEAREST PURLIN OR STRUT.

LIGHTING FIXTURE TYPE A MOUNTING DETAIL

DETAIL AA NO SCALE EG114

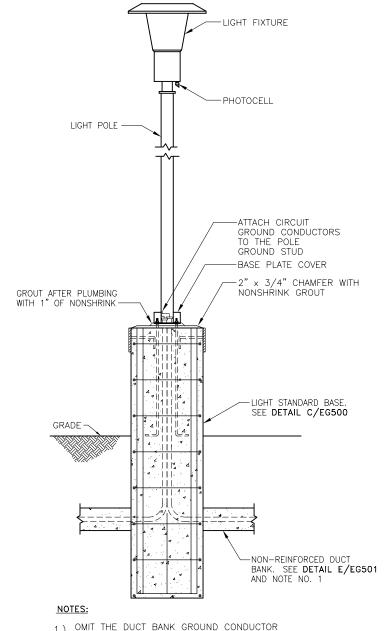

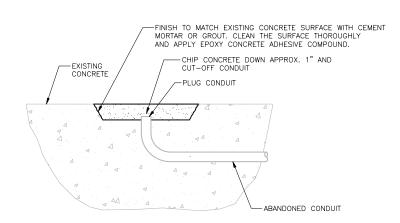

CONCRETE PATCHING AT ABANDONED CONDUIT DETAIL

DETAIL AC VAR

1.) OMIT THE DUCT BANK GROUND CONDUCTOR ON FIXTURE CIRCUITS.

FIXTURE TYPE B MOUNTING

CONTRACT NUMBER

DETAIL (AB VAR)

PRELIMINARY - NOT FOR CONSTRUCTION



Suite 221 San Jose, California 95126 (408) 294-1445



PROFESSIONAL	
No. E9236 Exp. 9-30-11	
* LXP. 9=30=11 *	

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ZONE	REV.	DESCRIPTION	BY	DATE	APP.	AT FULL SIZE
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						DESIGNED R. TERADA
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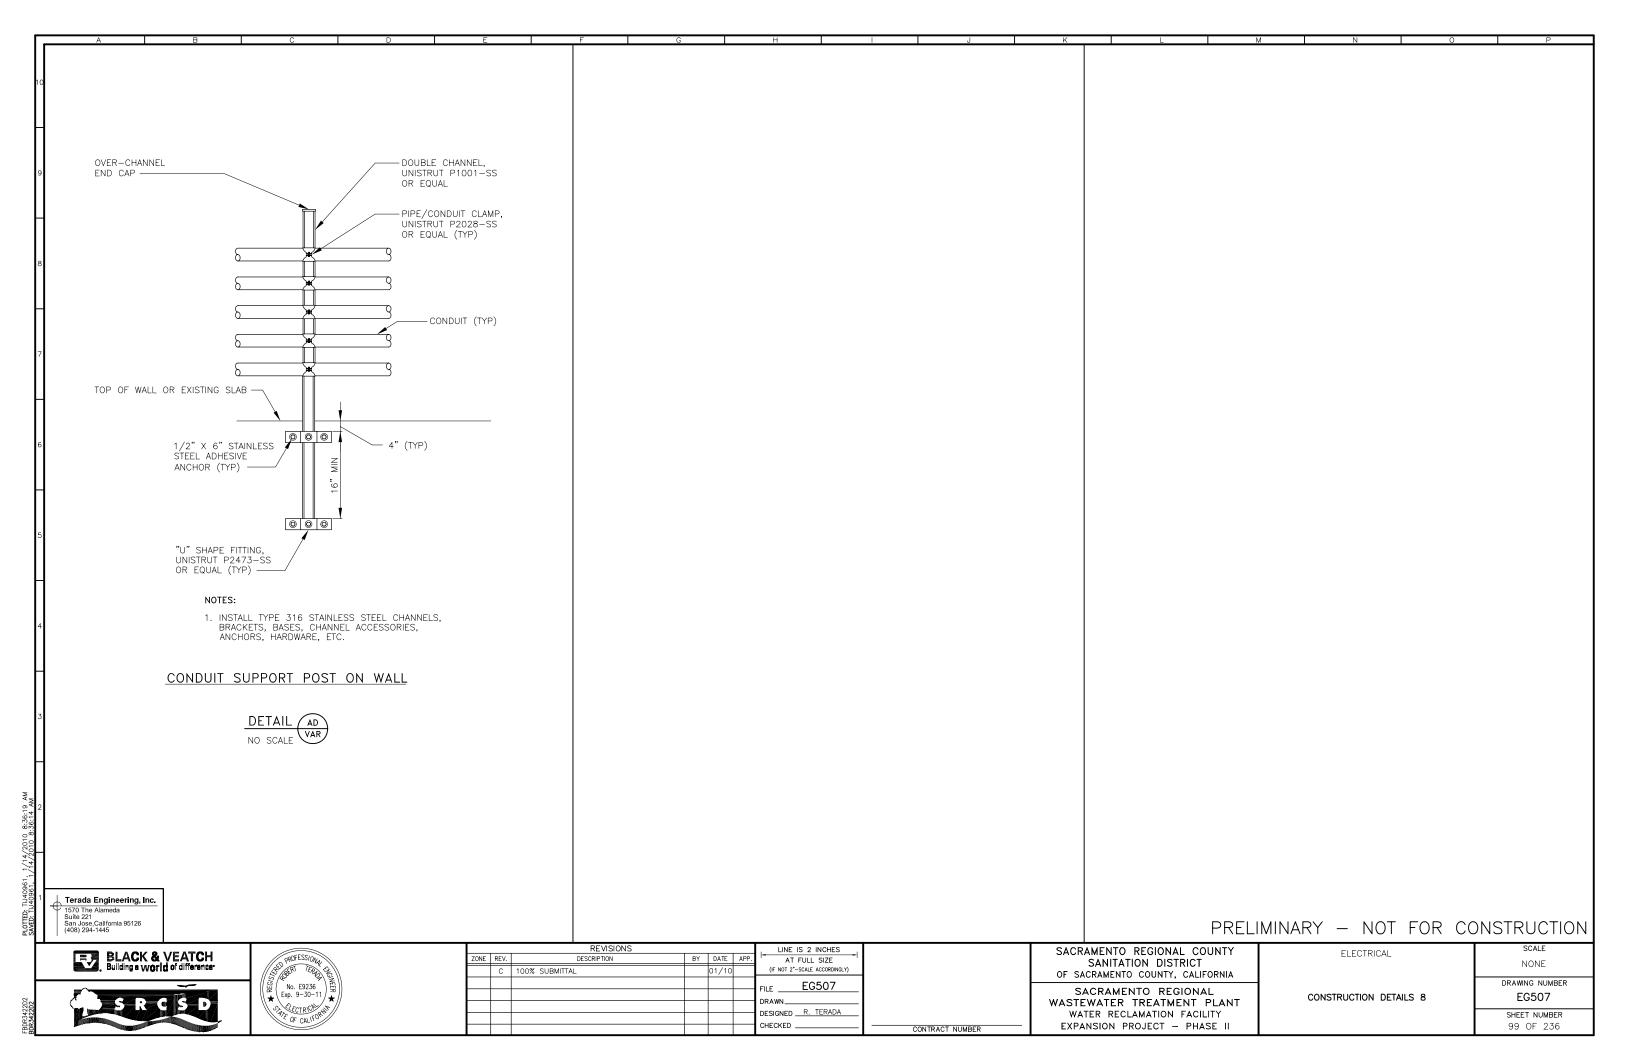
SACRAMENTO REGIONAL COUNTY SANITATION DISTRICT OF SACRAMENTO COUNTY, CALIFORNIA


SACRAMENTO REGIONAL WASTEWATER TREATMENT PLANT WATER RECLAMATION FACILITY EXPANSION PROJECT - PHASE II


CONSTRUCTION DETAILS 7


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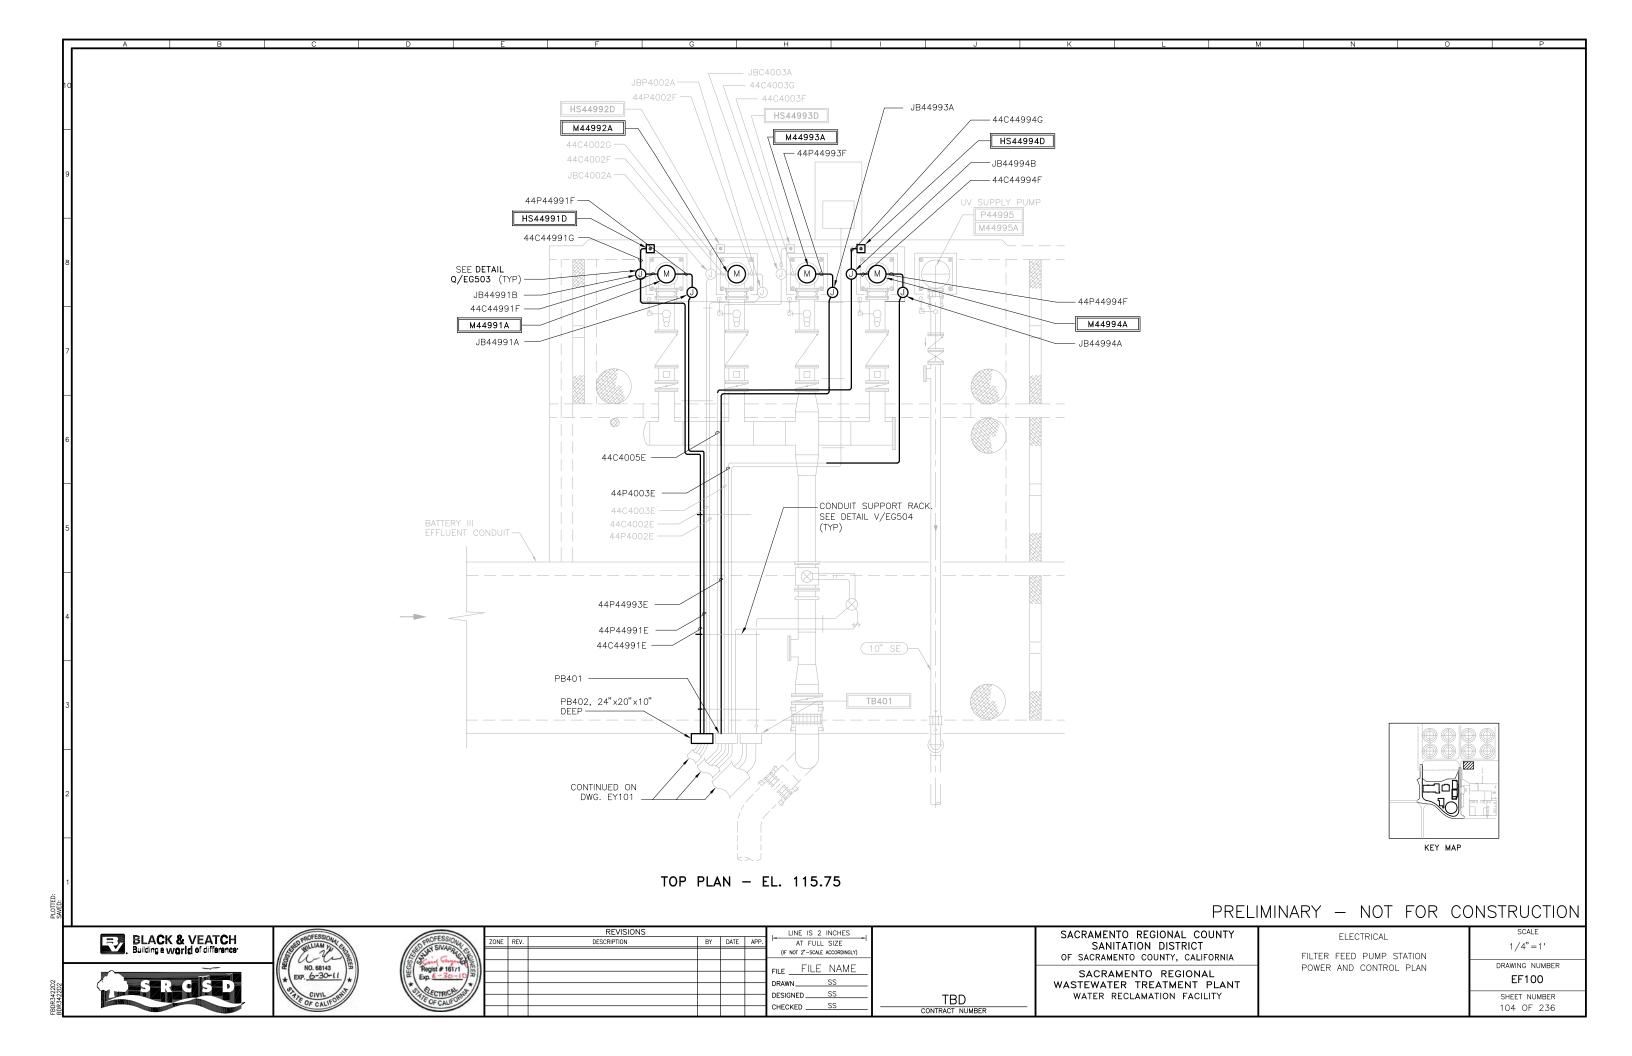
NONE DRAWING NUMBER EG506 SHEET NUMBER 98 of 236







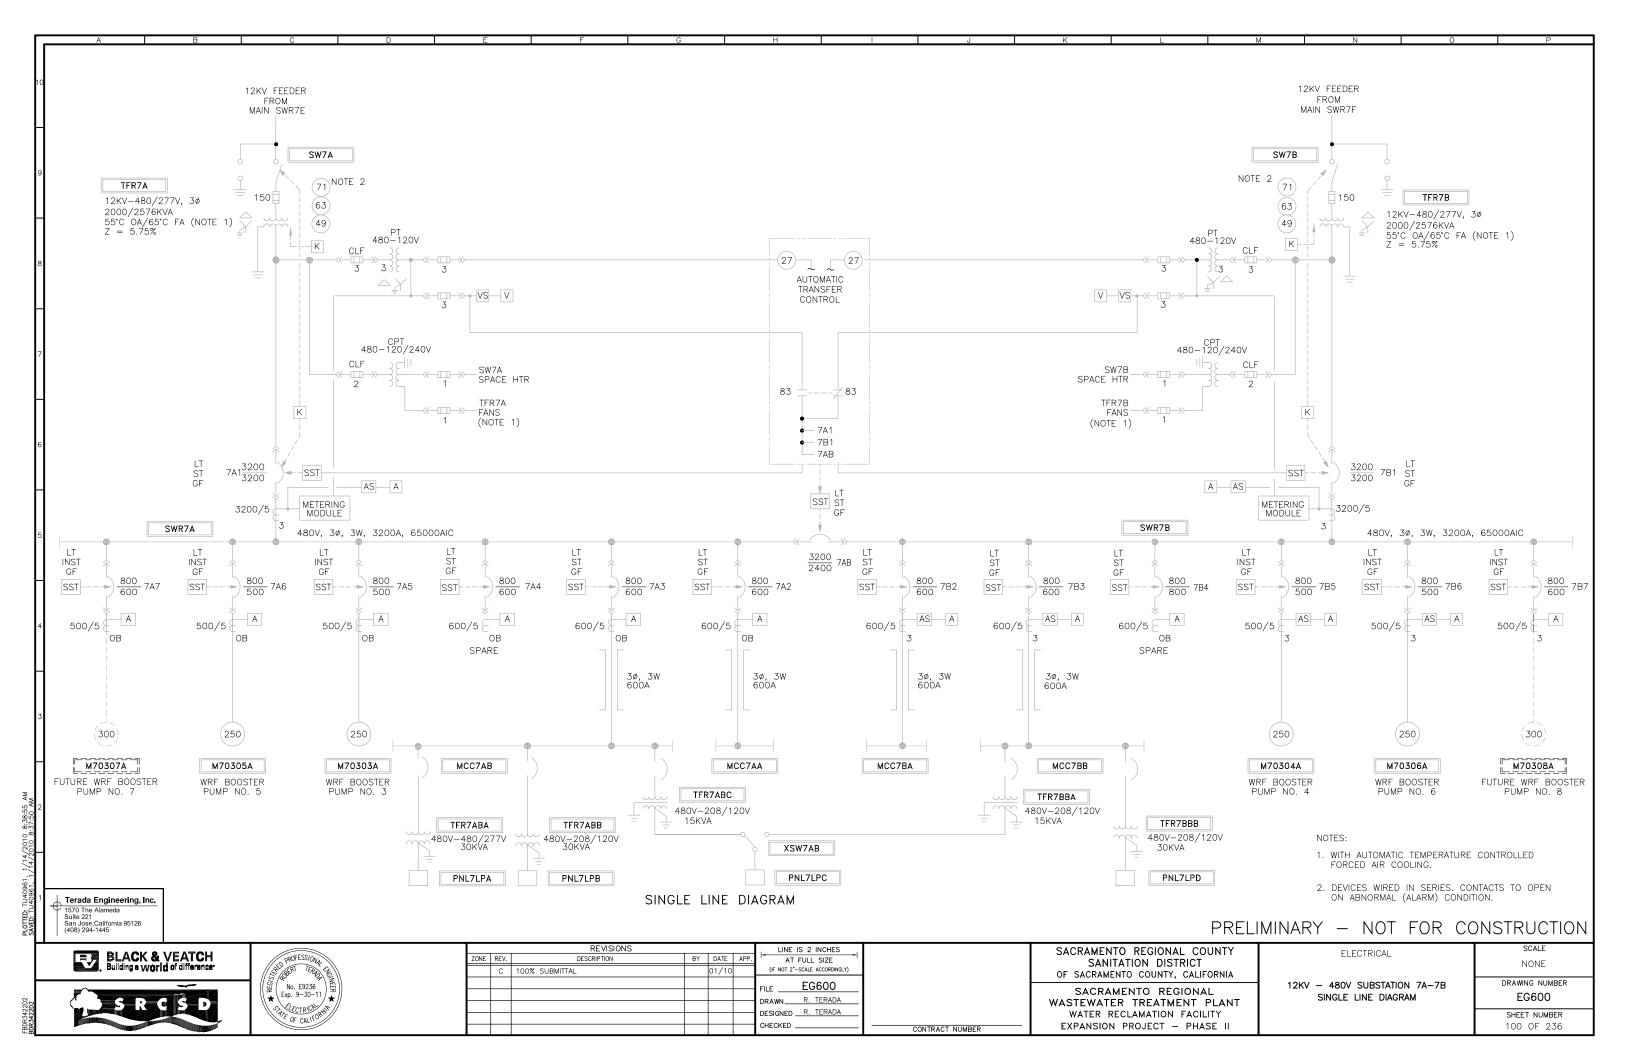

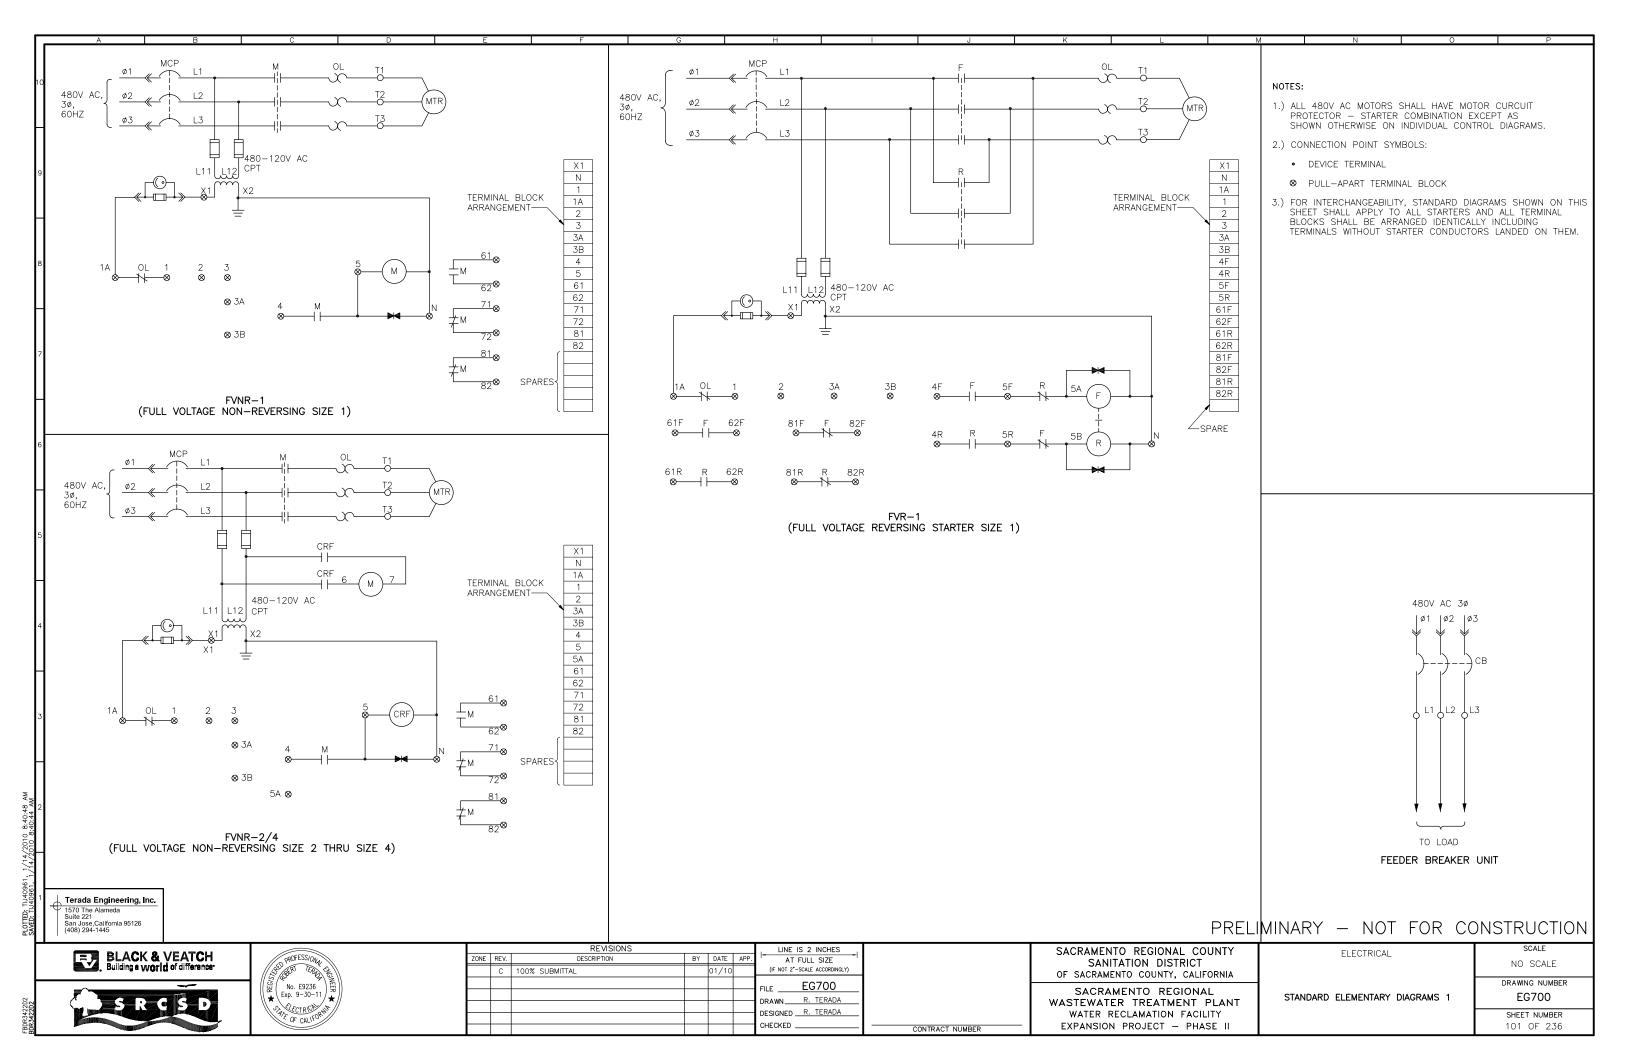

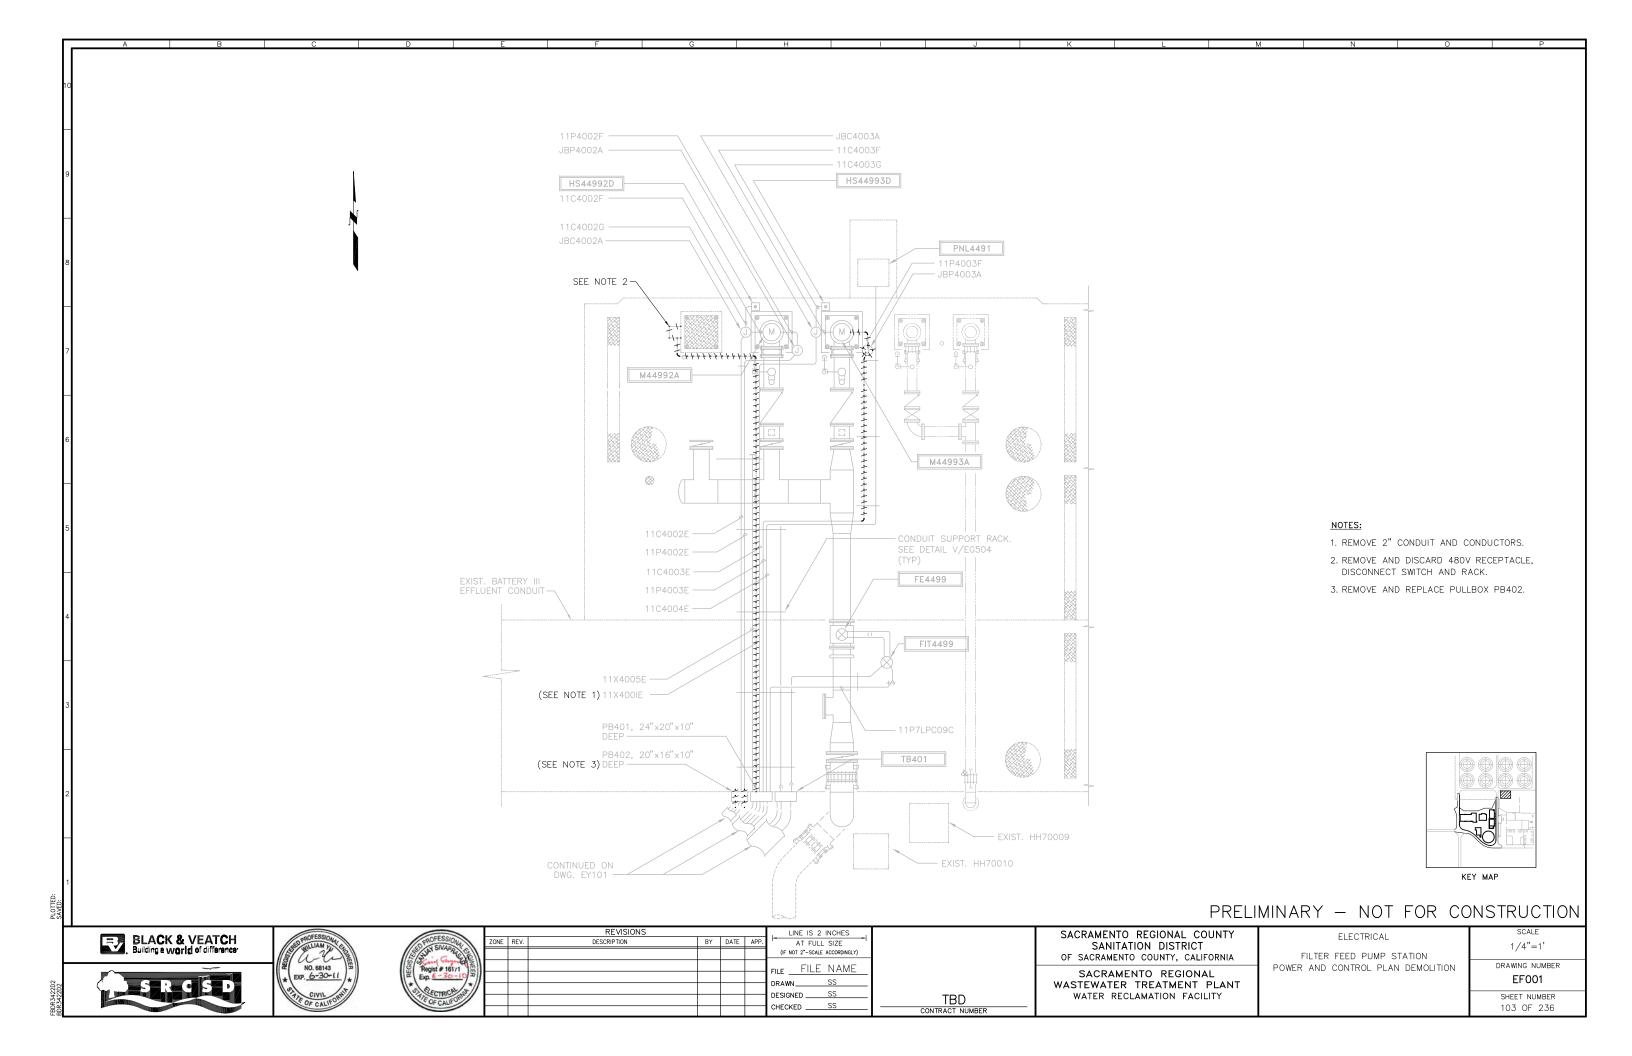

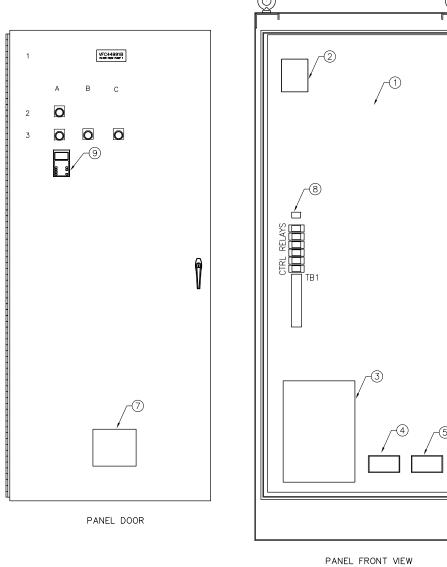

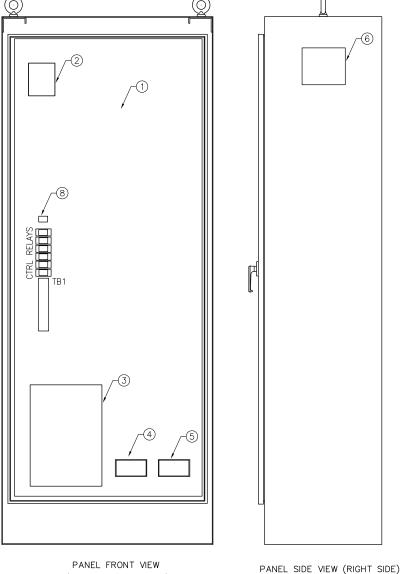

<u>NOTES</u> 1. GENERAL - ALL WIRING TO THE PANEL ENTER FROM BOTTOM. 2. NAMEPLATE: UNLESS OTHERWISE STATED, BLACK W/ WHITE LETTERS. LAMINATED PHENOLIC TYPE

3. NAMEPLATE TO BE ATTACHED W/ S.S. SCREWS. 4. PROVIDE 10 SPARE TERMINAL BLOCKS FOR TB1.

(WITH DOOR REMOVED)

5. ENCLOSE ALL WIRING CROSSING DOOR HINGES WITH SPIRAL WRAP.

PANEL BILL OF MATERIALS

QTY	MFG	CATALOG	DESCRIPTION
1	HOFFMAN	A903620FS	ENCLOSURE, NEMA 12, SINGLE DOOR, 90" (H), 36" (W), 20" (D)
1	HOFFMAN	A90P36F1	ENC. BACK PANEL, 78" (H), 32" (W)
1	ALLEN-BRADLEY	20BD248A3ANNANA0	
1			POWERFLEX 700, 480V, 248A, 200HP VFD, FRAME SIZE 6, STANDARD 24V I/O
) 1	ALLEN-BRADLEY	20-HIM-C3S	DOOR MOUNTED VFD DISPLAY WITH CABLE
) 1	ACME ELECTRIC	TB-81215	CONTROL TRANSFORMER, 480V-120VAC, 500VA
1	ACME ELECTRIC	PL-112704	PRIMARY FUSE BLOCK
1	ACME ELECTRIC	PL-79931	SECONDARY FUSE BLOCK
) 1	MARATHON	1403303	INPUT POWER TB
) 1	MARATHON	1453606	OUTPUT POWER TB
1	MARATHON	CC1403	CLEAR PROTECTIVE PLASTIC COVER FOR INPUT POWER TB
1	MARATHON	CC1453	CLEAR PROTECTIVE PLASTIC COVER FOR OUTPUT POWER TB
) 1	HOFFMAN	TFP41	COOLING FAN / AIR FILTER / GRILLE
) 1	HOFFMAN	TEP4	EXHAUST GRILLE / AIR FILTER
) 1	HOFFMAN	A-TEMNO	THERMOSTAT
1	HOFFMAN	A-LF16D18	WORKLIGHT
) 1	ALLEN BRADLEY	1321-RWR250-DP	OUTPUT FILTER
1	ALLEN-BRADLEY	800T-PH16W	PILOT LIGHT, LED-TRANSFORMER TYPE, 120AC, WHITE
1	ALLEN-BRADLEY	800T-PTH16G	PILOT LIGHT, LED-TRANSFORMER TYPE, 120AC, PUSH TO TEST, GREEN
1	ALLEN-BRADLEY	800T-PTH16R	PILOT LIGHT, LED-TRANSFORMER TYPE, 120VAC, PUSH-TO-TEST, RED
1	ALLEN-BRADLEY	800T-PTH16A	PILOT LIGHT, LED-TRANSFORMER TYPE, 120AC, PUSH-TO-TEST, AMBER
6	IDEC	RU4S-A110	CONTROL RELAY, FORM C, 4 POLE, 120VAC, INDICATOR LT
6	IDEC	SY4S-05	RELAY SOCKET
40	PHOENIX CONTACT	30 04 36 2	TERMINAL BLOCKS UK5N
	AS NEEDED		MISC. CTRL FUSES, PANDUIT, SPIRAL WRAP, NAMEPLATES, WIRE, DINRAIL

	NAMEPLATE SCHEDULE											
DRAWING TAG	QUANTITY	TYPE	SIZE	LETTER SIZE	INSCRIPTION	ALLEN-BRADLEY						
1	1	PLATE	2.0" X 5.0"	1/2"	SEE TABLE BELOW							
2A	1	RING	30.5 mm	1/8	POWER ON	800H-W100E						
3A	1	RING	30.5 mm	1/8	READY	800H-W100E						
3B	1	RING	30.5 mm	1/8	RUN	800H-W100E						
3C	1	RING	30.5 mm	1/8	FAULT	800H-W100E						

TAG 1 1ST LINE TAG 1 2ND LINE

PANEL NO.1	PANEL NO.2							
VFC44991B	VFC44993B							
FILTER FEED PUMP 1	FILTER FEED PUMP 3							

PRELIMINARY - NOT FOR CONSTRUCTION





PANEL BASE CUT-OUT DETAIL



			REVISIONS				, LINE IS 2 INCHES ,
PROFESSIONA	ZONE	REV.	DESCRIPTION	BY	DATE	APP.	AT FULL SIZE
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Bootet # 1814							FILE NAME
Exp. 6 -30-10 3							
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TBD CONTRACT NUMBER


SACRAMENTO REGIONAL COUNTY SANITATION DISTRICT OF SACRAMENTO COUNTY, CALIFORNIA


SACRAMENTO REGIONAL WASTEWATER TREATMENT PLANT WATER RECLAMATION FACILITY


PANELS AND CABINETS NAMEPLATE SCHEDULE

FILTER FEED PUMP VFD PANELS VFC44991B / VFC44993B


SCALE NO SCALE DRAWING NUMBER EF700 SHEET NUMBER 106 OF 236

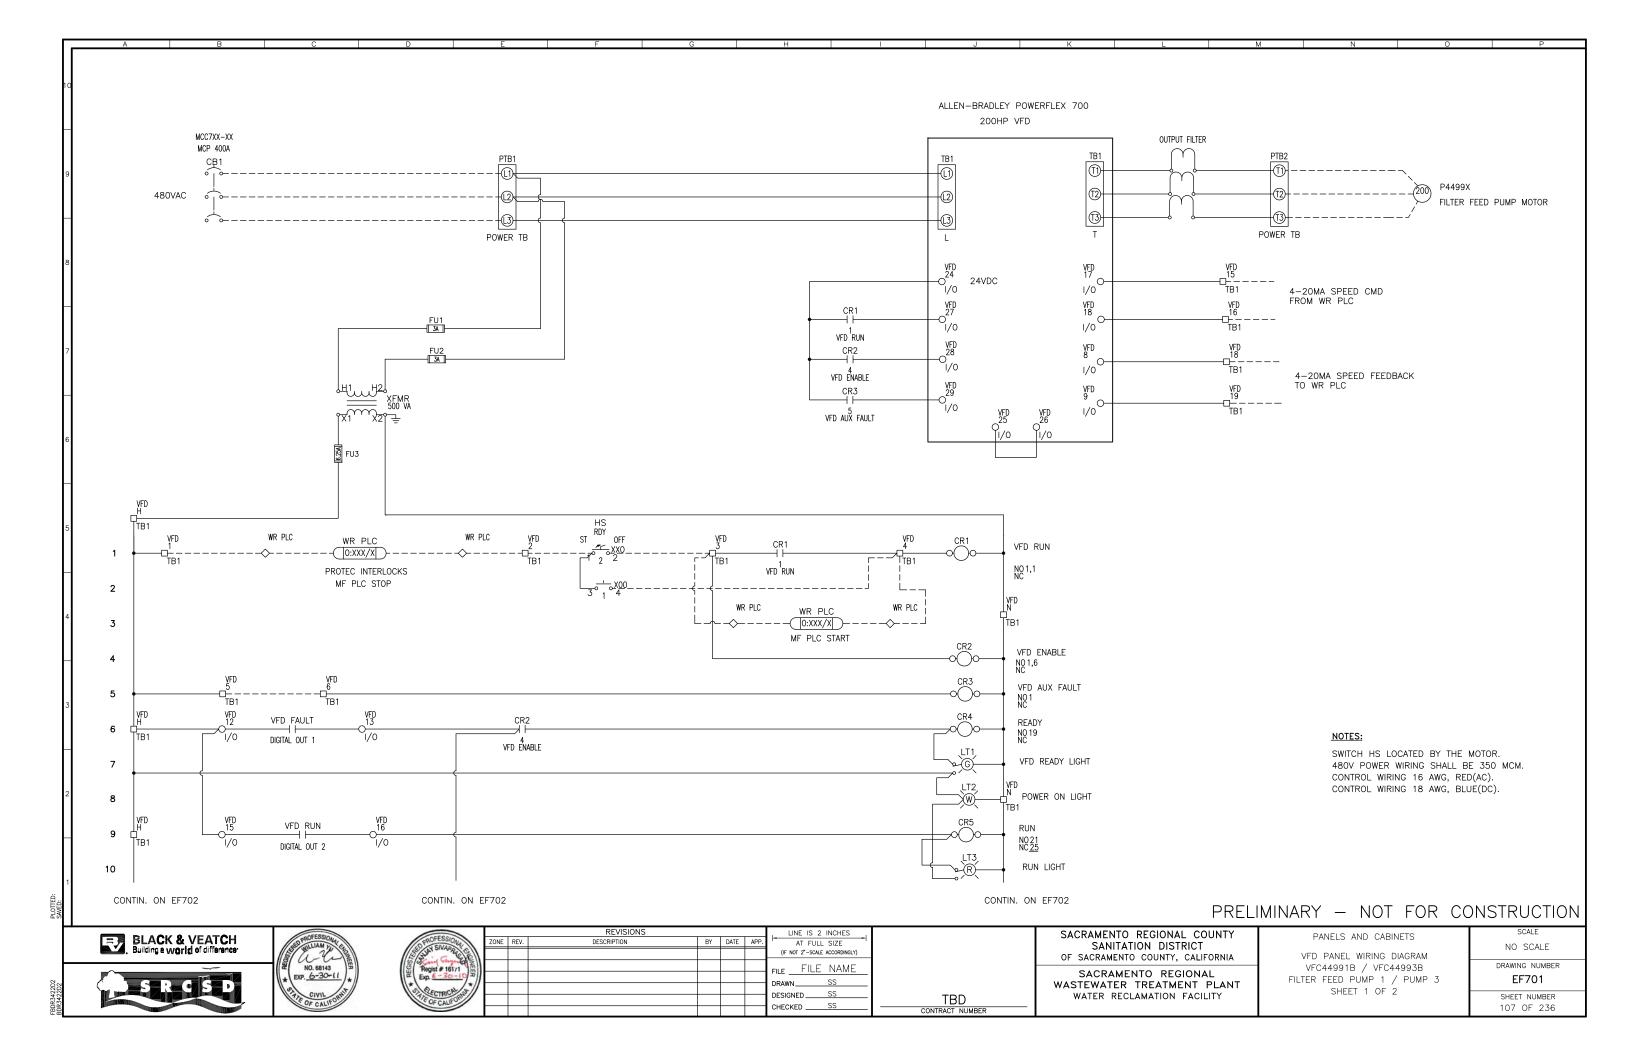


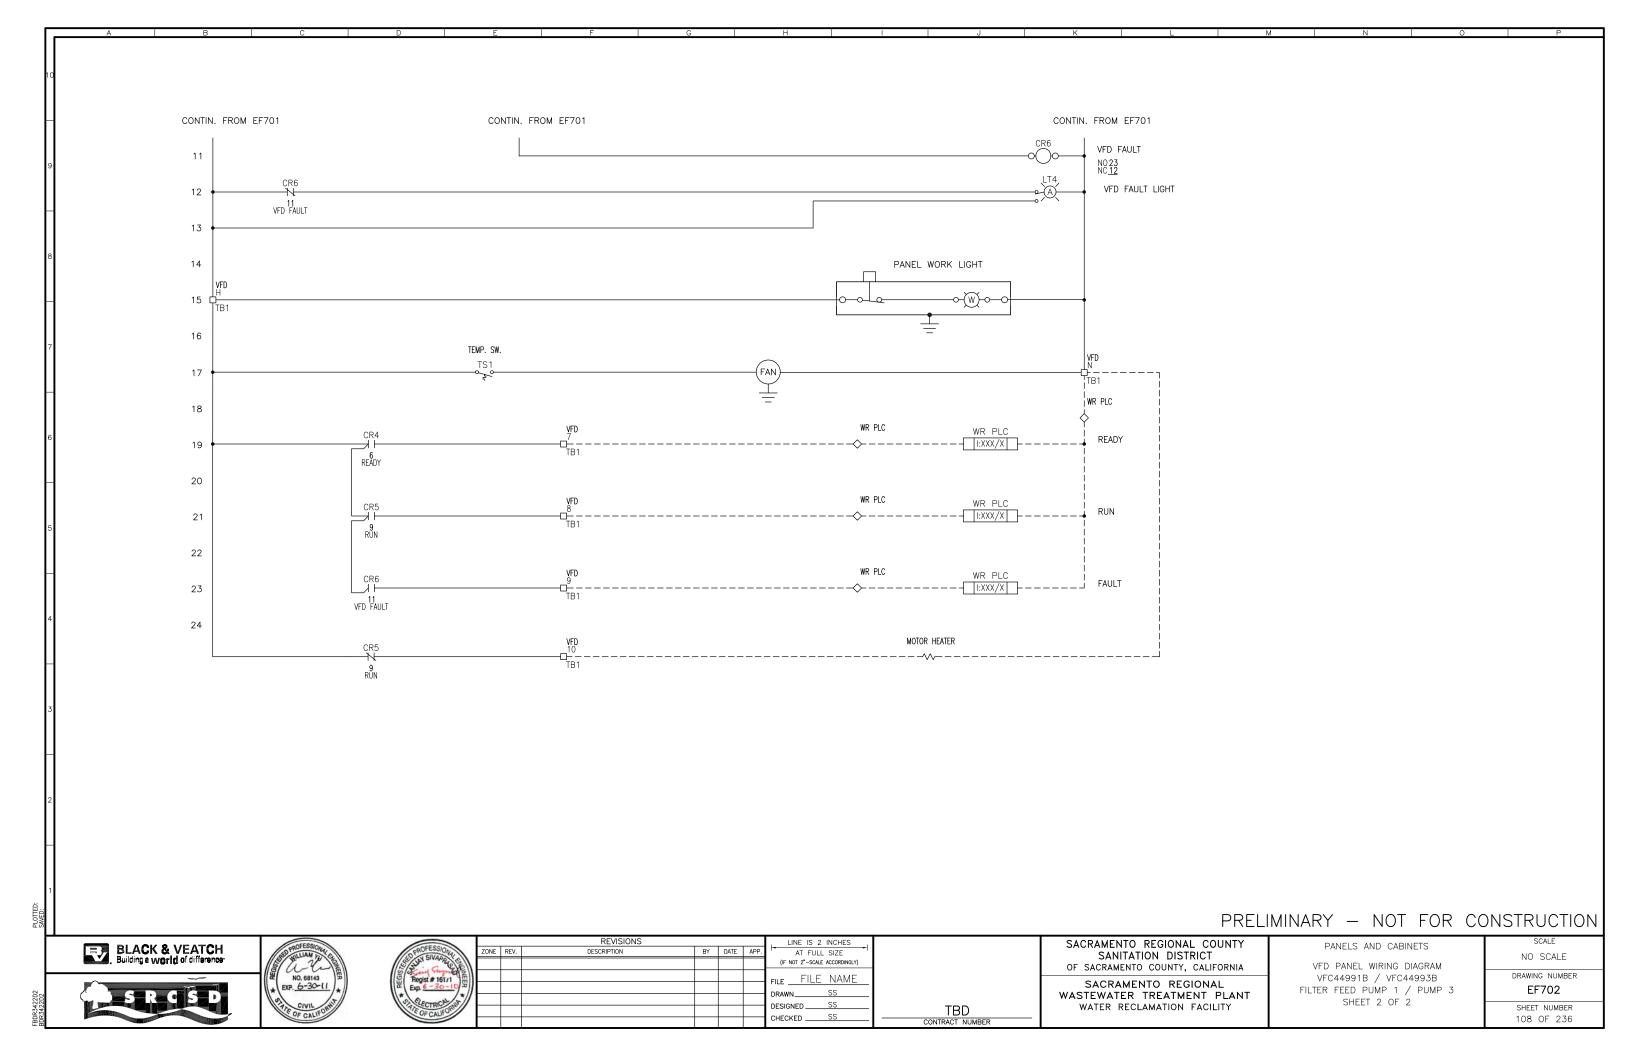

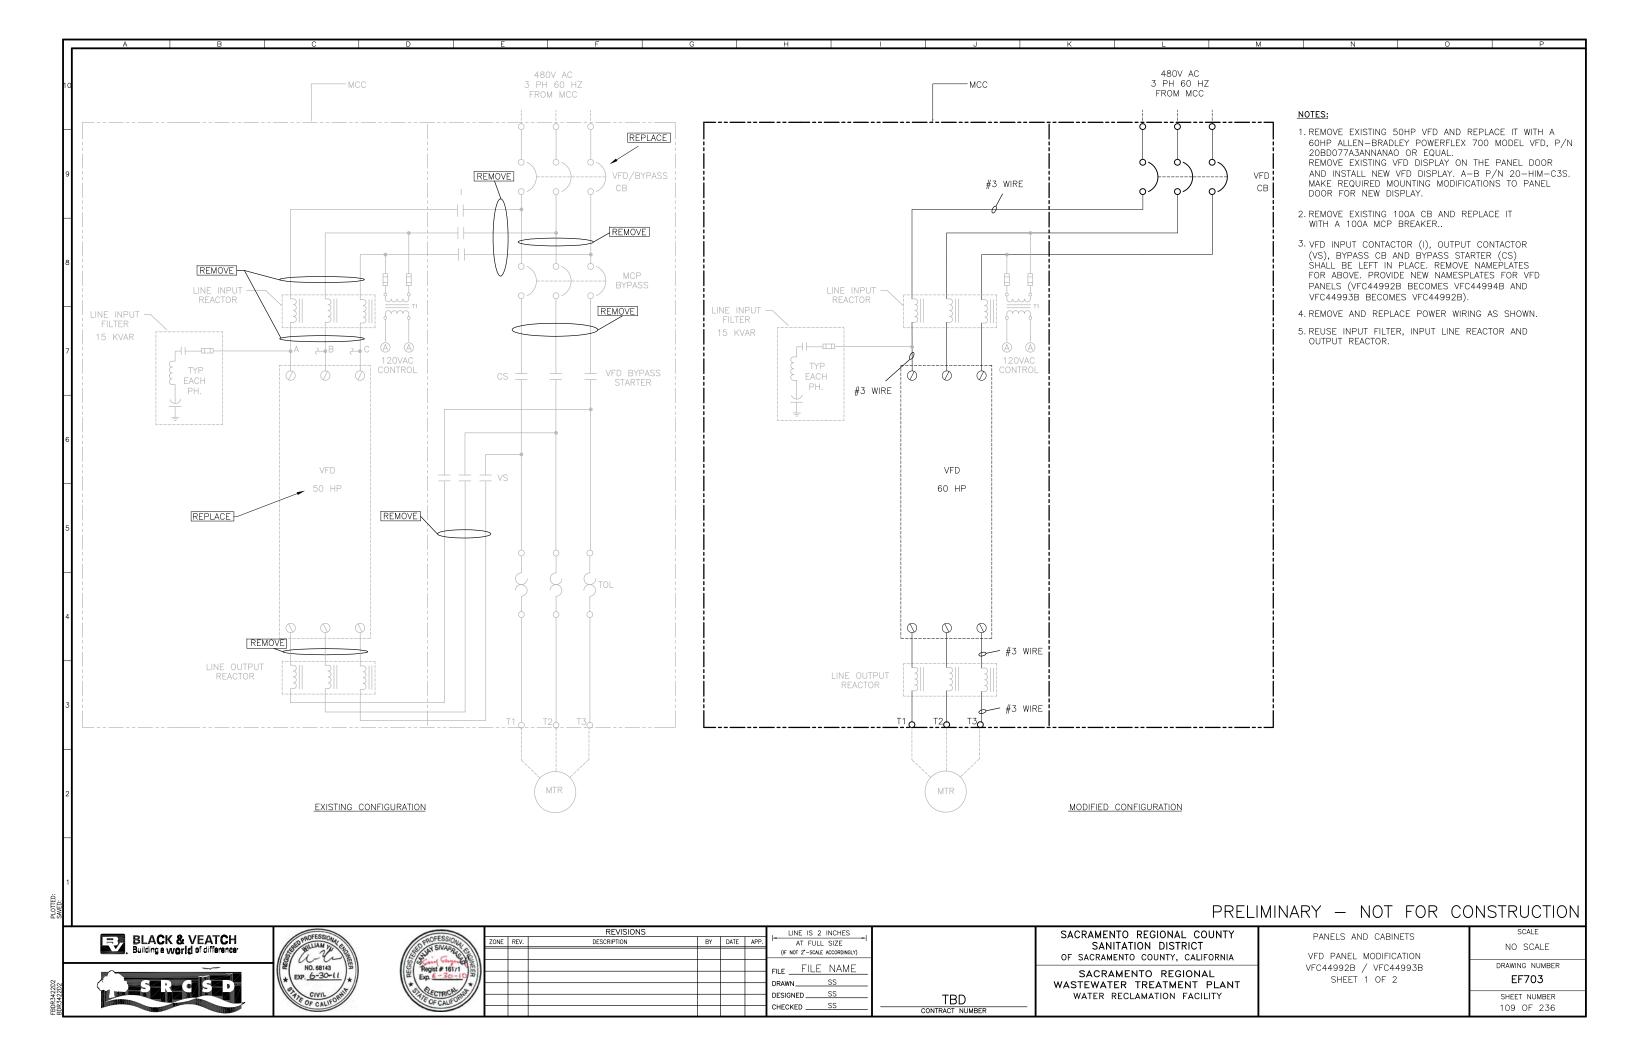

VFD ALLEN-BRADLEY POWERFLEX 700 STANDARD I/O BOARD (24VDC)

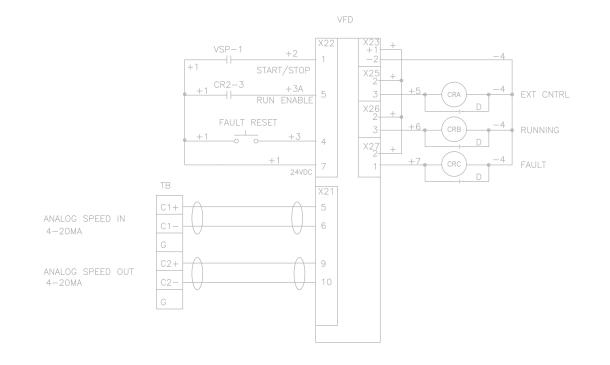

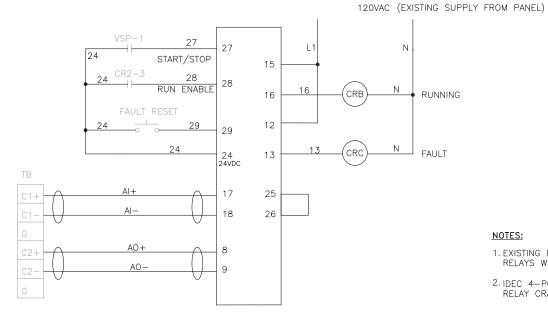

- 1. EXISTING RELAYS CRA, CRB AND CRC ARE 24VDC. REPLACE RELAYS WITH 120VAC COIL.
- 2. IDEC 4-POLE RELAY P/N RU4S-A110, RELAY BASE SY4S-05. RELAY CRA IS NOT USED IN THE MODIFIED CONFIGURATION.

EXISTING CONFIGURATION (CONTROL AND SIGNAL WIRING, PARTIAL)

MODIFIED CONFIGURATION (CONTROL AND SIGNAL WIRING, PARTIAL)

PRELIMINARY - NOT FOR CONSTRUCTION







			REVISIONS				, LINE IS 2 INCHES ,
PROFESSIONA	ZONE	REV.	DESCRIPTION	BY	DATE	APP.	AT FULL SIZE
3 3 3 1 2 1 2 1 2 1 2 1 2 1 2 1 2 1 2 1							(IF NOT 2"-SCALE ACCORDINGLY)
Regist # 161/1							FILE FILE NAME
Exp. 6-30-10 3							
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TBD CONTRACT NUMBER


SACRAMENTO REGIONAL COUNTY SANITATION DISTRICT OF SACRAMENTO COUNTY, CALIFORNIA


SACRAMENTO REGIONAL WASTEWATER TREATMENT PLANT WATER RECLAMATION FACILITY


PANELS AND CABINETS VFD PANEL MODIFICATION VFC4499B2 / VFC44993B SHEET 2 OF 2


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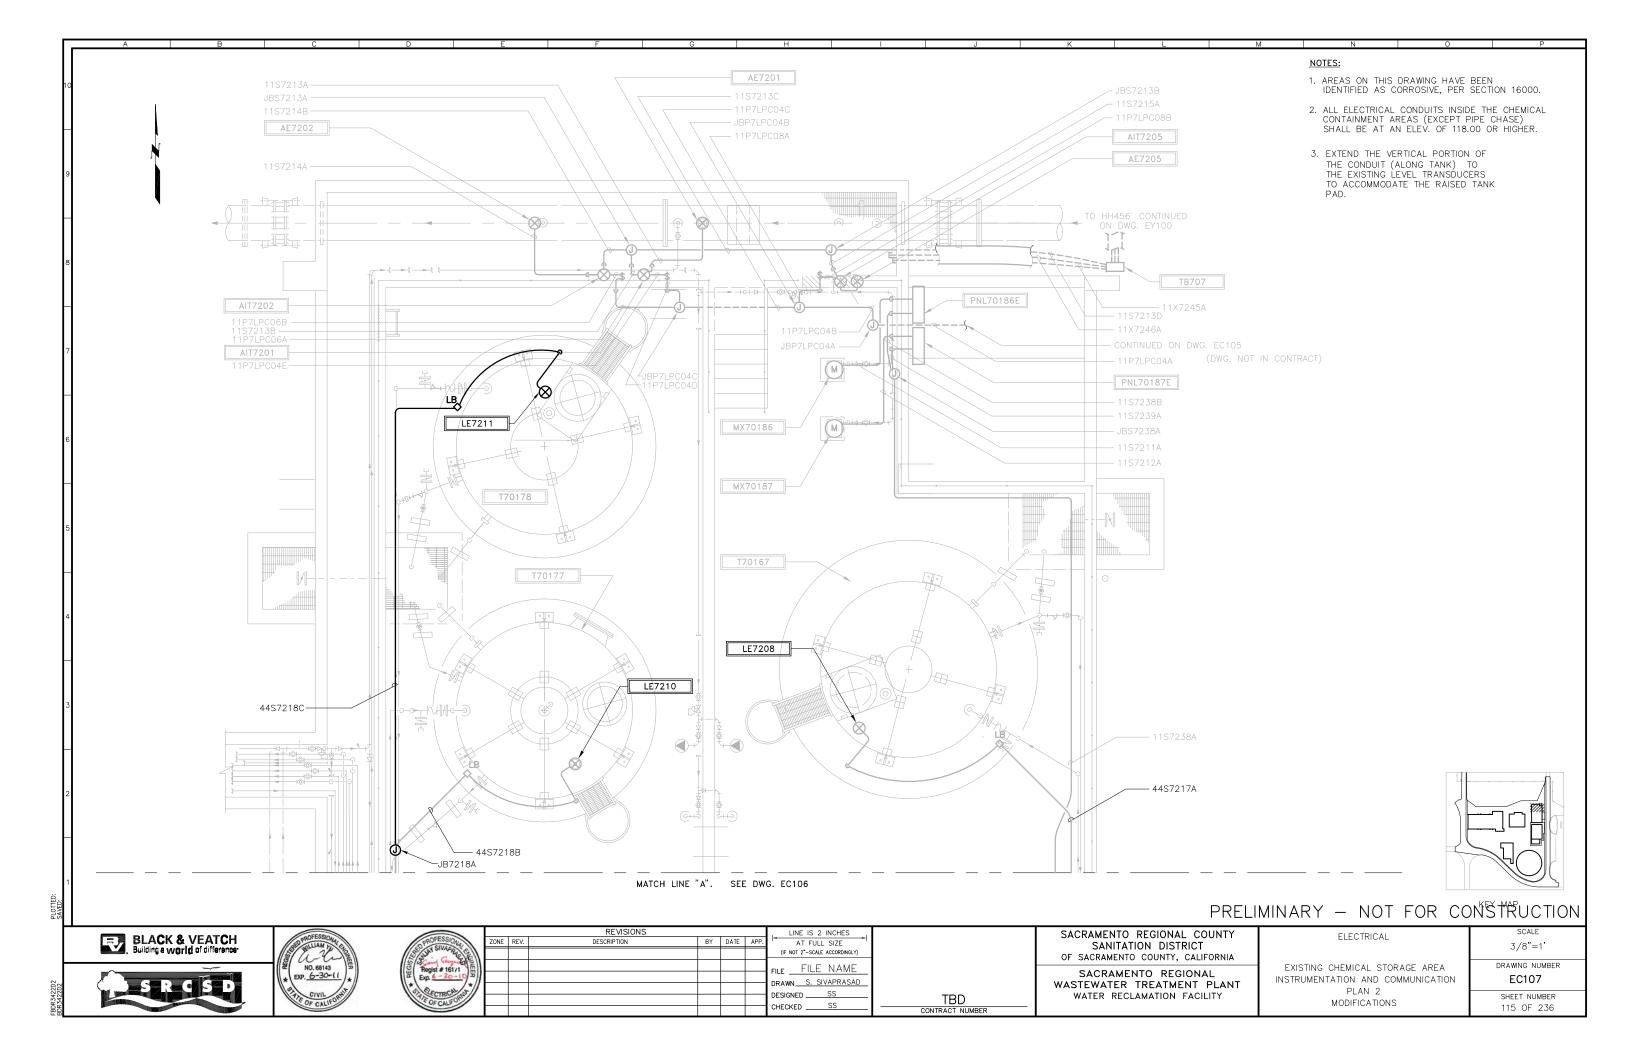
SHEET NUMBER 110 OF 236



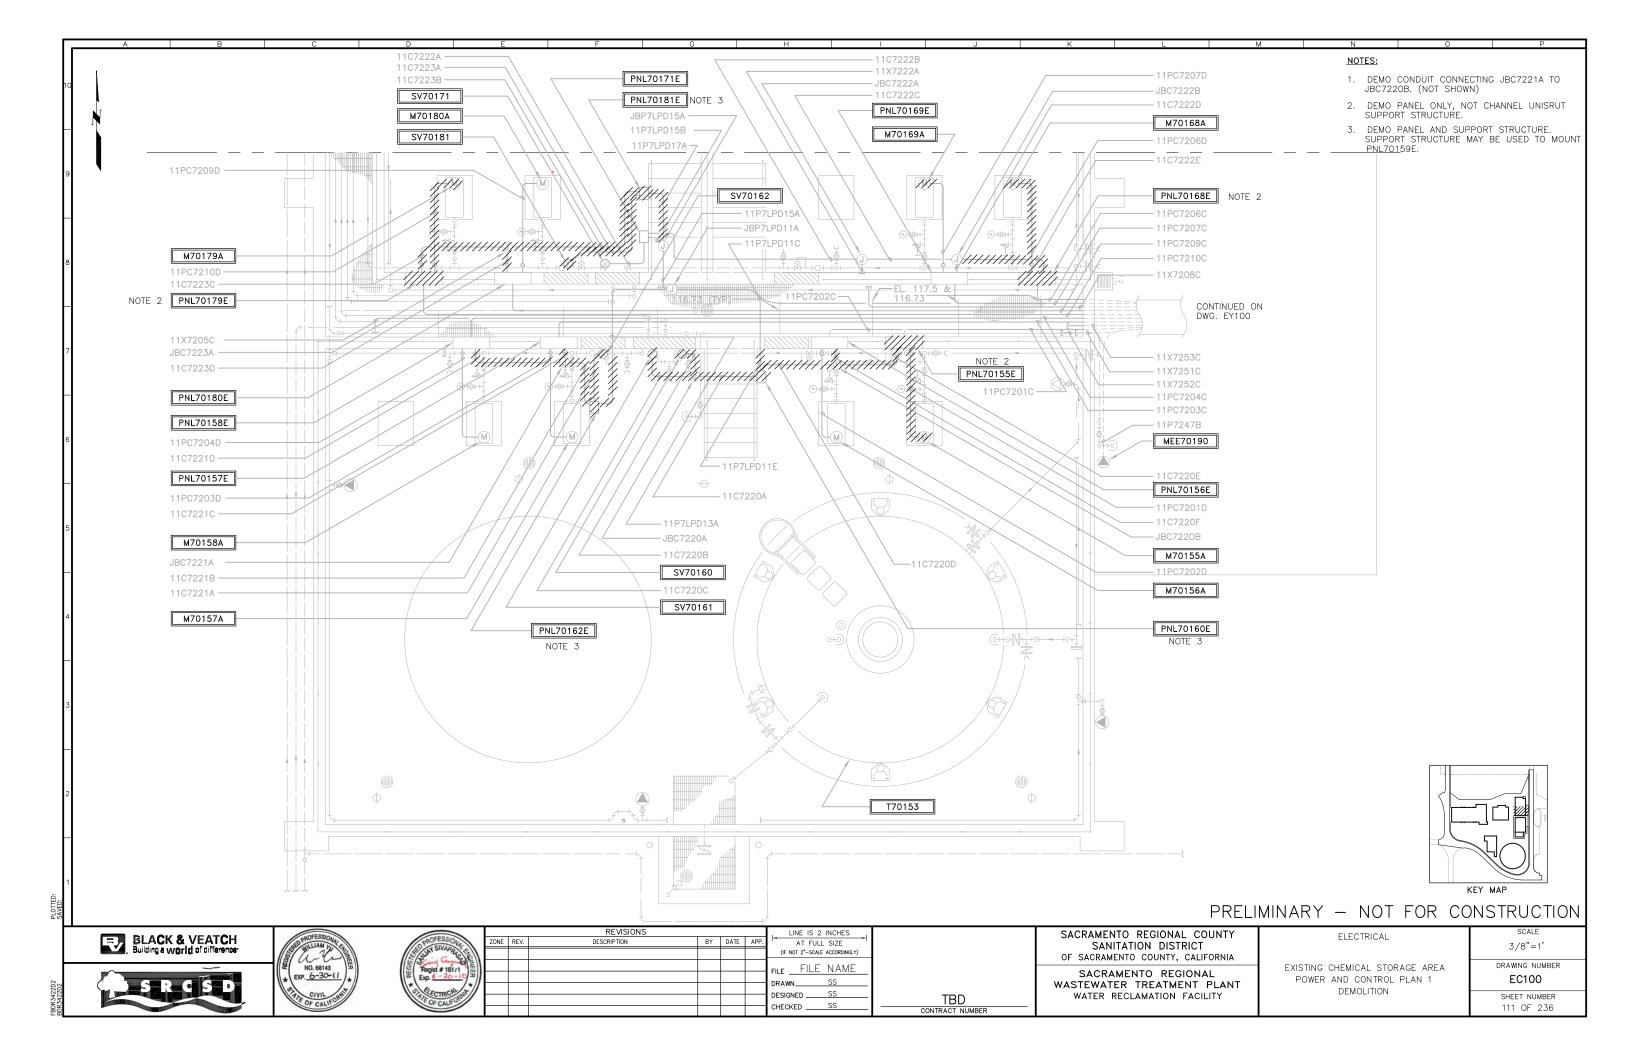

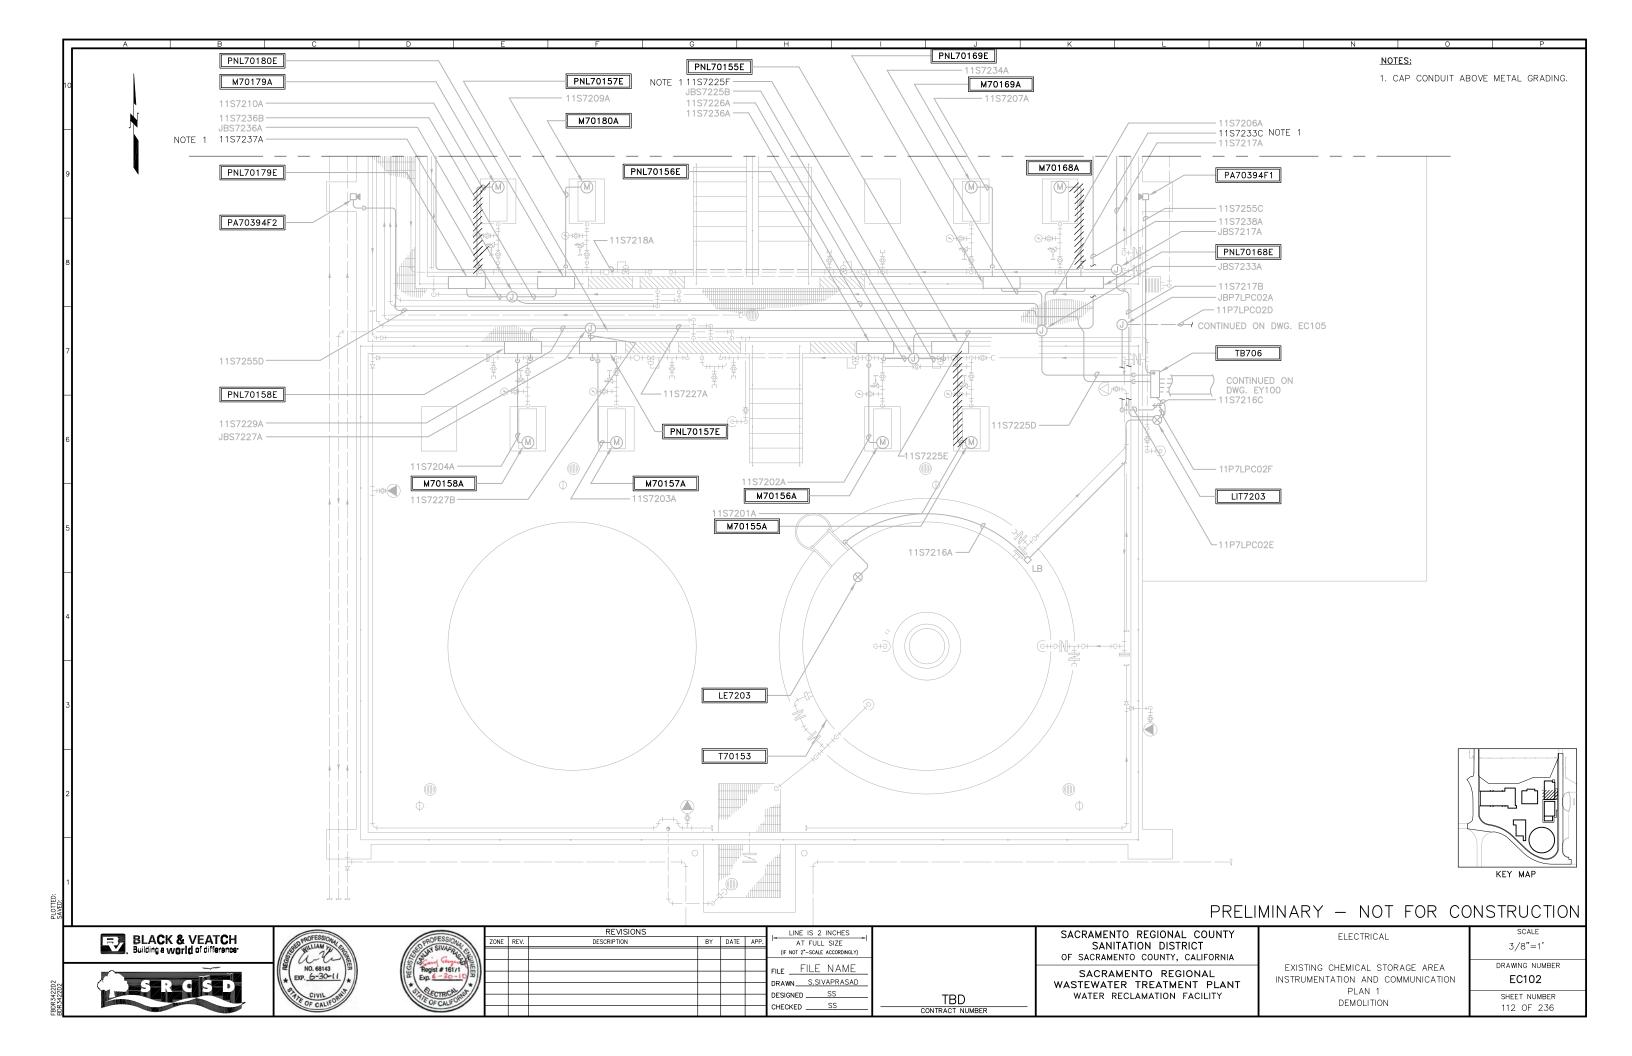

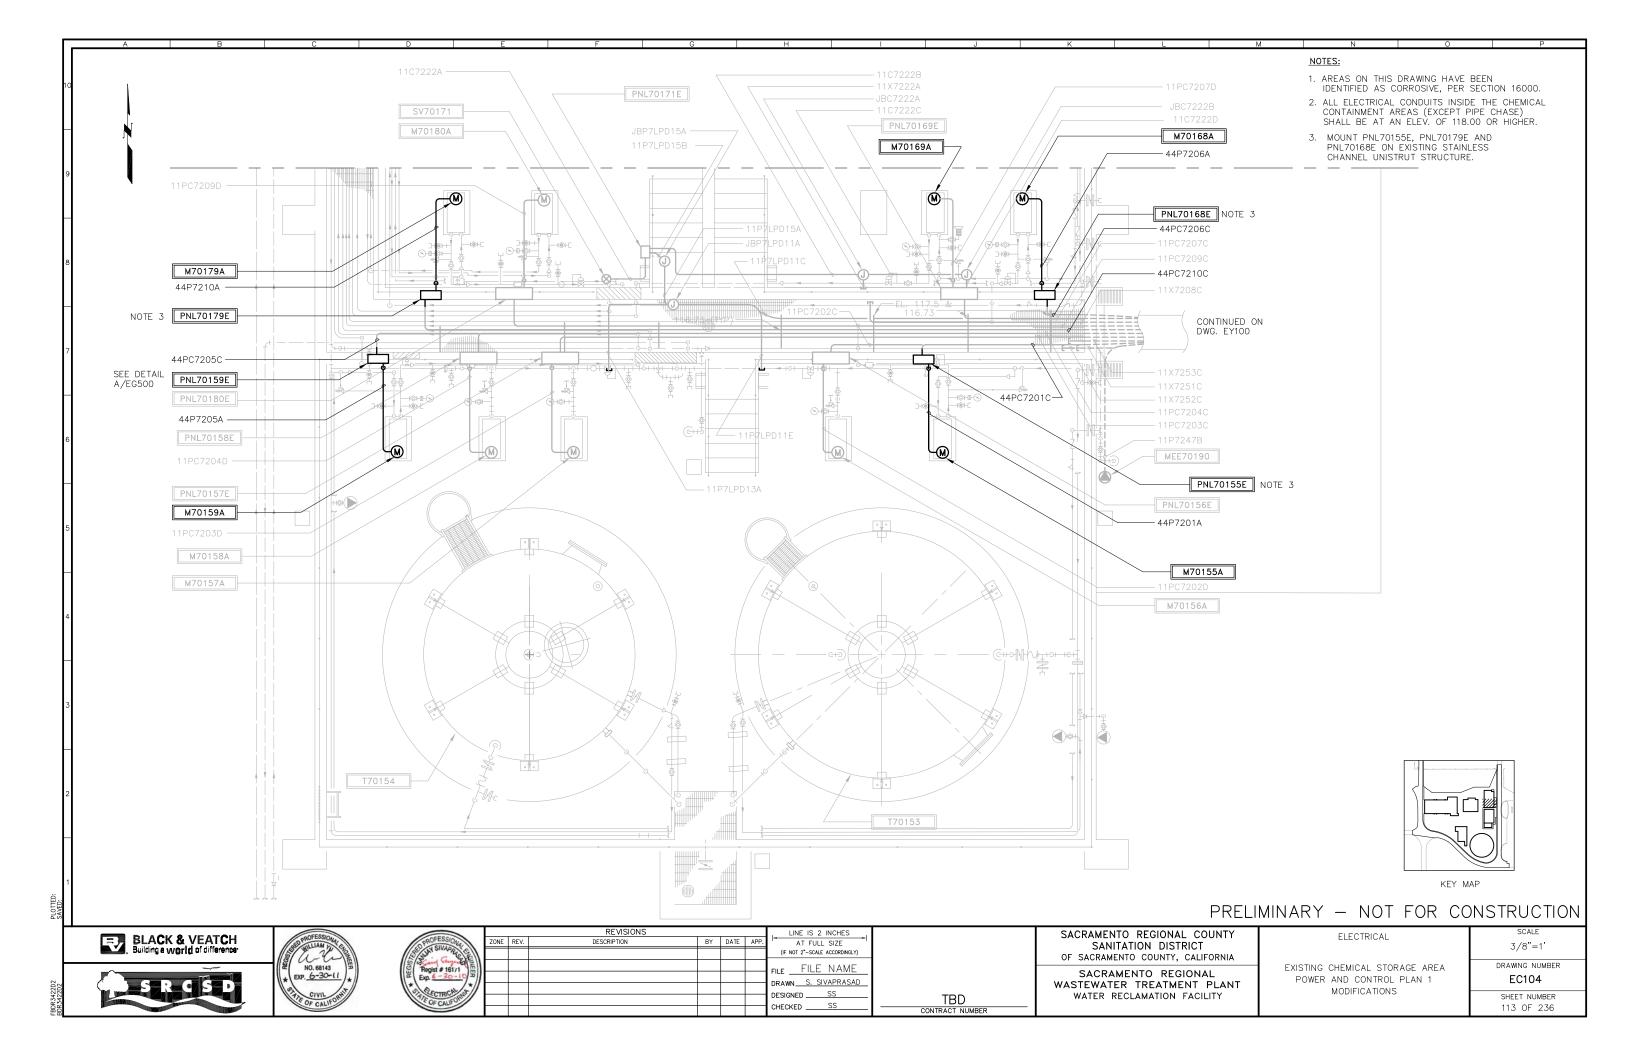

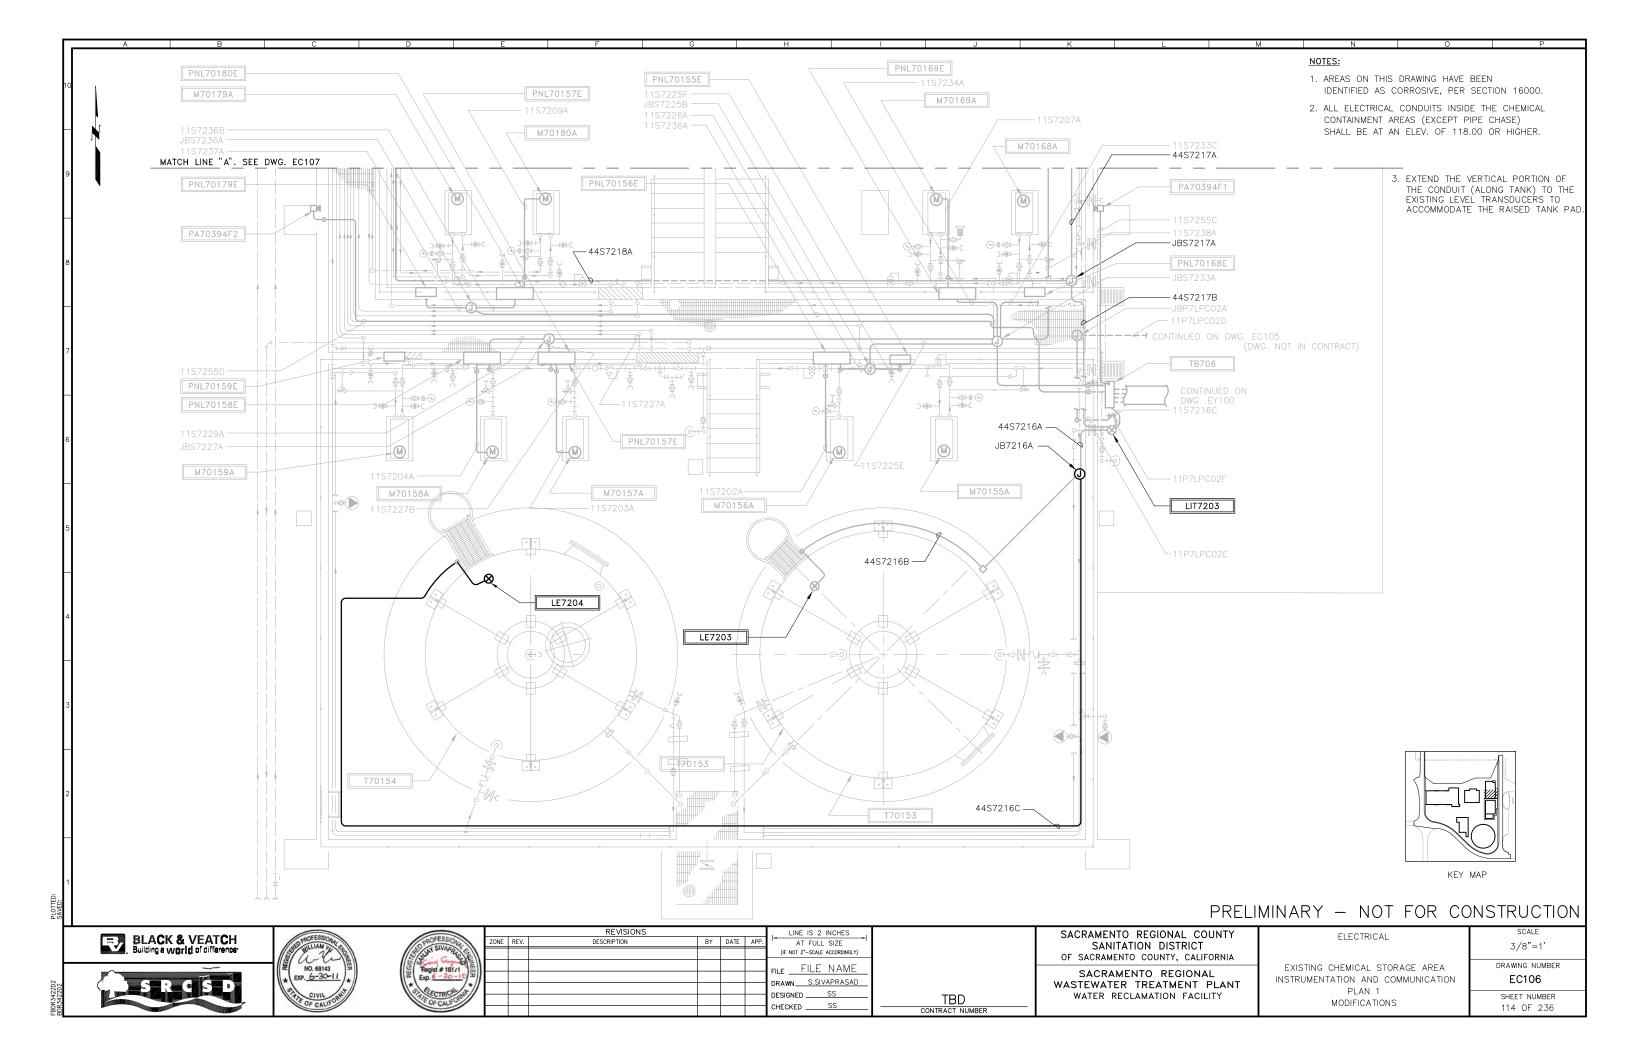

PNL70155E SODIUM HYPOCHLORITE PUMP 2A 2B

PANEL FRONT VIEW

PANEL BILL OF MATERIALS

QTY	MFG	CATALOG	DESCRIPTION
1	HOFFMAN	A1614CHNFSS6	STAINLESS STEEL ENCLOSURE, NEMA 4X, 16" (H), 14" (W), 6" (D)
1	ALLEN-BRADLEY	800H-JR4KE7B	3-POSITION SELECTOR SWITCH. SPRING RETURN FROM LEFT, 2 N.O. 2 N.C. CONTACTS

NAMEPLATE SCHEDULE								
DRAWING TAG	QUANTITY	TYPE	SIZE	LETTER SIZE	INSCRIPTION	ALLEN-BRADLEY P/N		
1	1	PLATE	2.0" X 6.0"	1/2"	SEE TABLE BELOW			
2A 2B	1	RING	30.5 mm	1/8 1/8	SEE TABLE BELOW START READY OFF	800H-W100E		

TAG 1 1ST LINE TAG 1 2ND LINE TAG 2A

PANEL NO.1	PANEL NO.2	PANEL NO.3	PANEL NO.4
PNL70155E SODIUM HYPOCHLORITE PUMP	PNL70159E SODIUM HYDROXIDE PUMP	PNL70179E CITRIC ACID PUMP	PNL70168E SODIUM BISULFITE PUMP
HS70155D	HS70159D	HS70179D	HS70168D

PRELIMINARY - NOT FOR CONSTRUCTION

BLACK & VEATCH
Building a world of difference





			REVISIONS				, LINE IS 2 INCHES
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TBD CONTRACT NUMBER


SACRAMENTO REGIONAL COUNTY SANITATION DISTRICT OF SACRAMENTO COUNTY, CALIFORNIA


SACRAMENTO REGIONAL WASTEWATER TREATMENT PLANT WATER RECLAMATION FACILITY


ELECTRICAL PANEL LAYOUT, MATERIAL LIST AND NAMEPLATE SCHEDULE


CHEMICAL PUMP CONTROL PANELS

SCALE NO SCALE DRAWING NUMBER EC700 SHEET NUMBER 116 OF 236

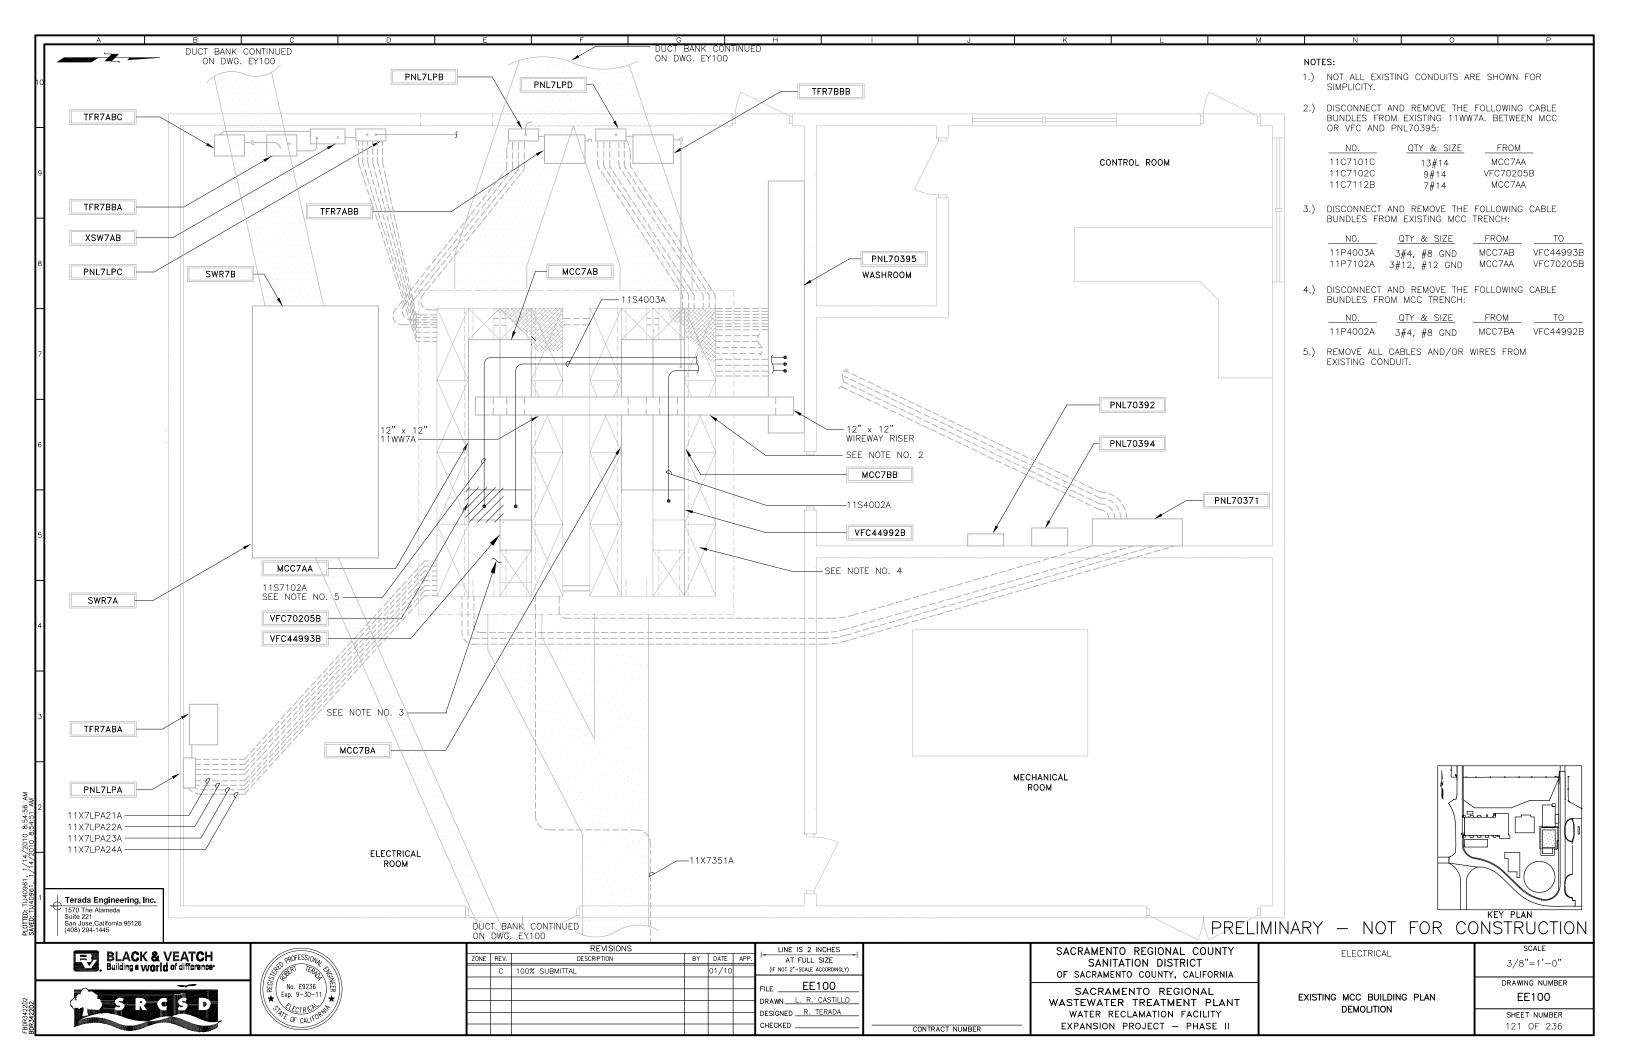

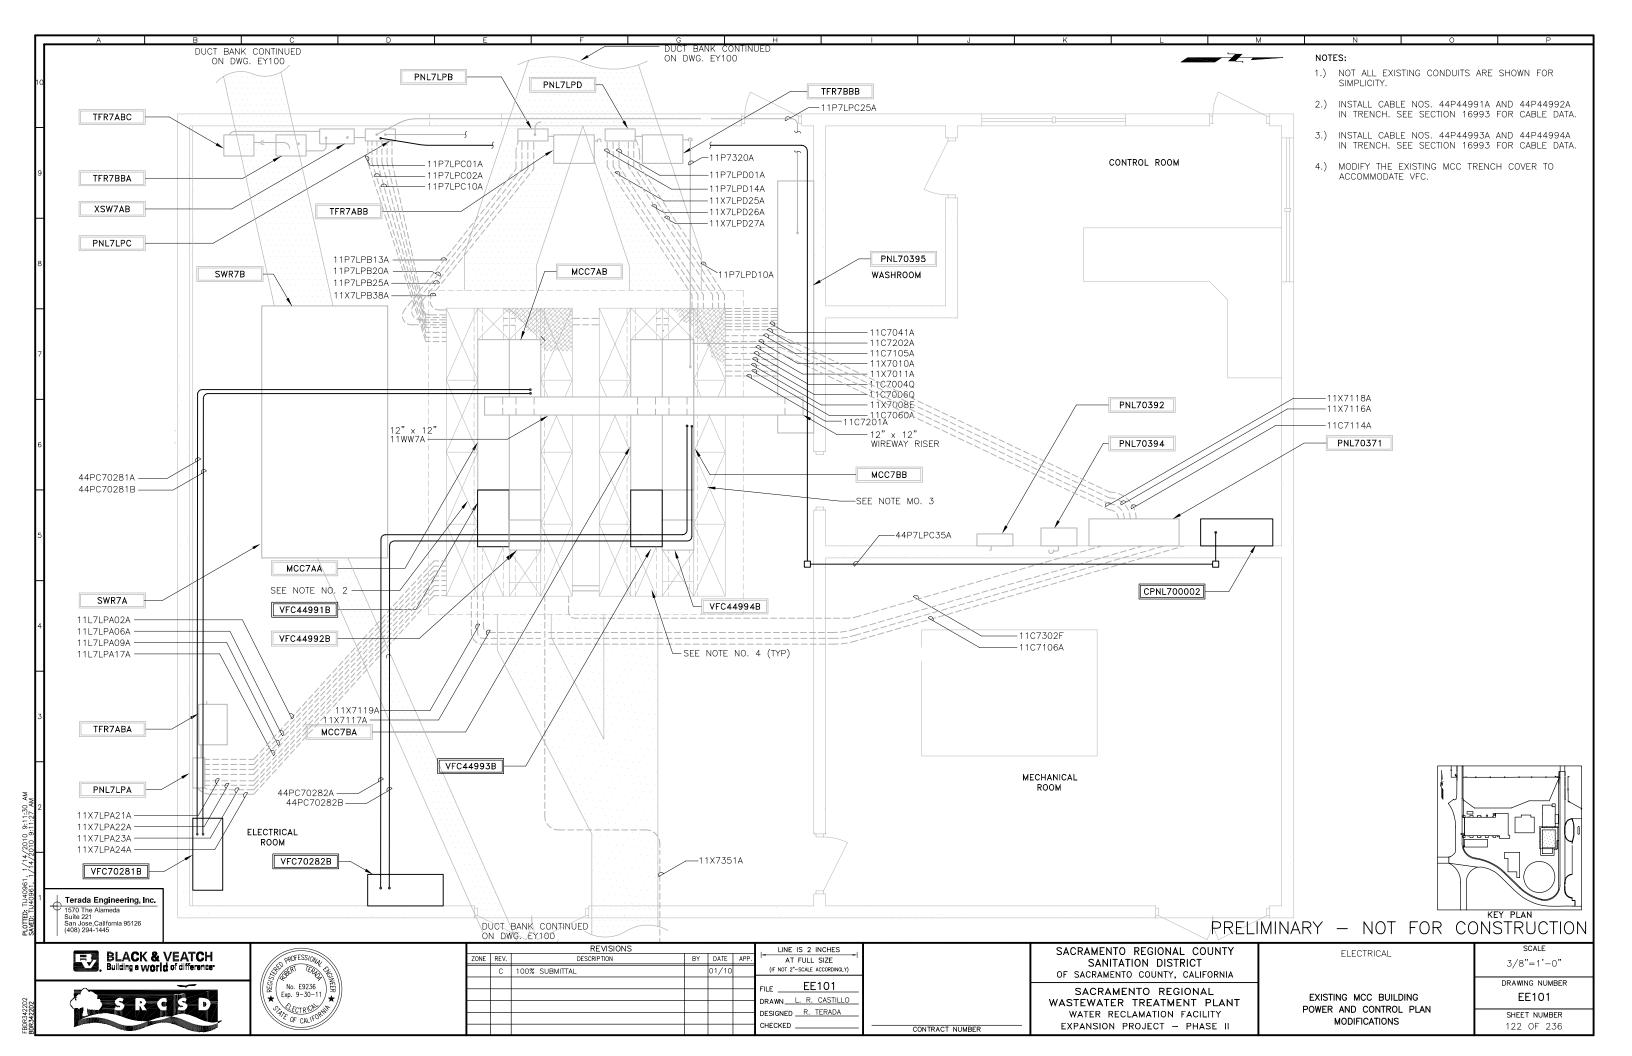

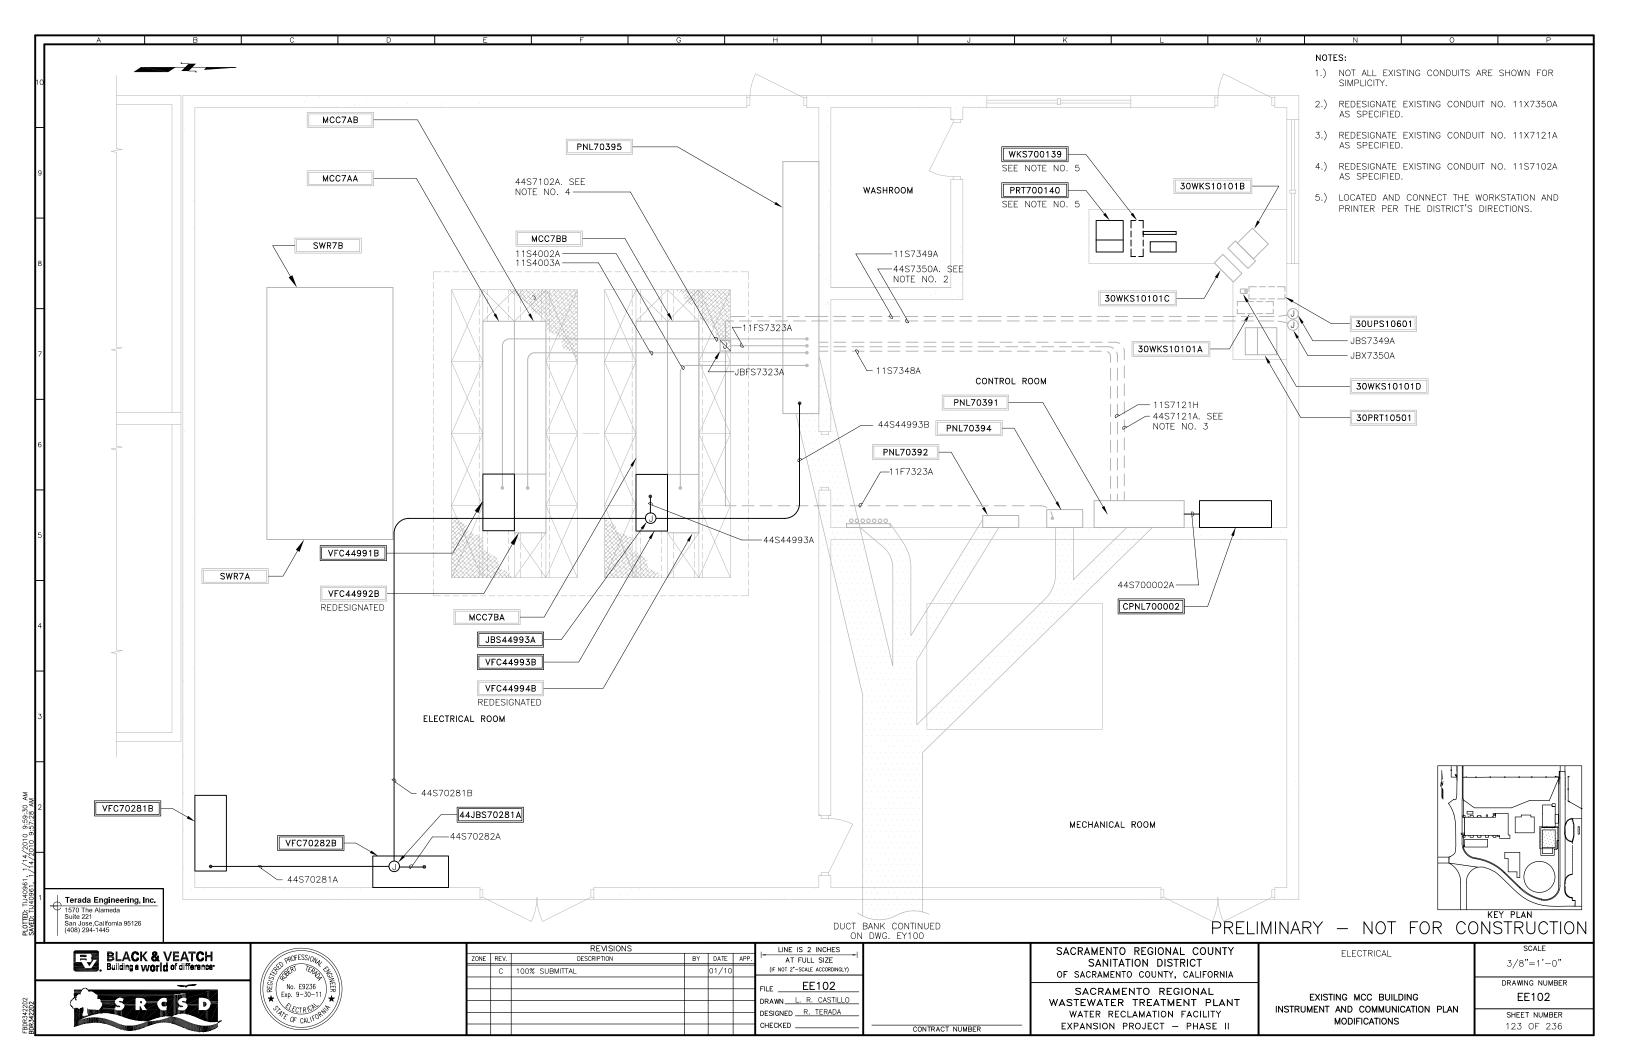

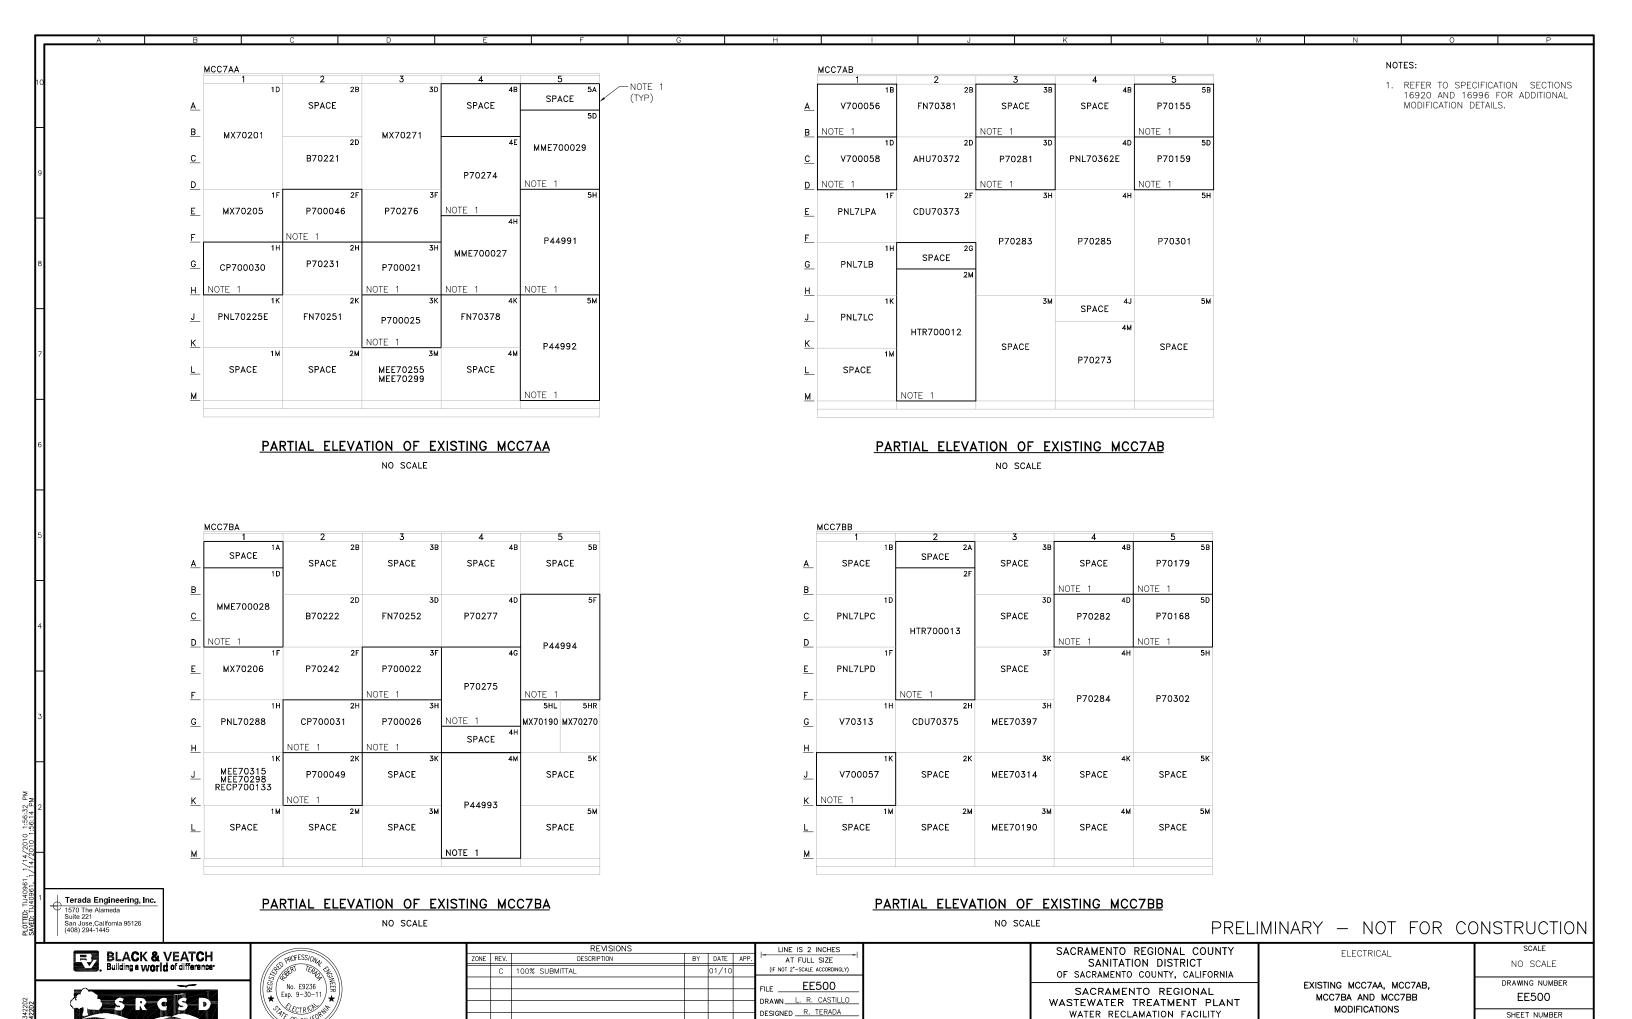



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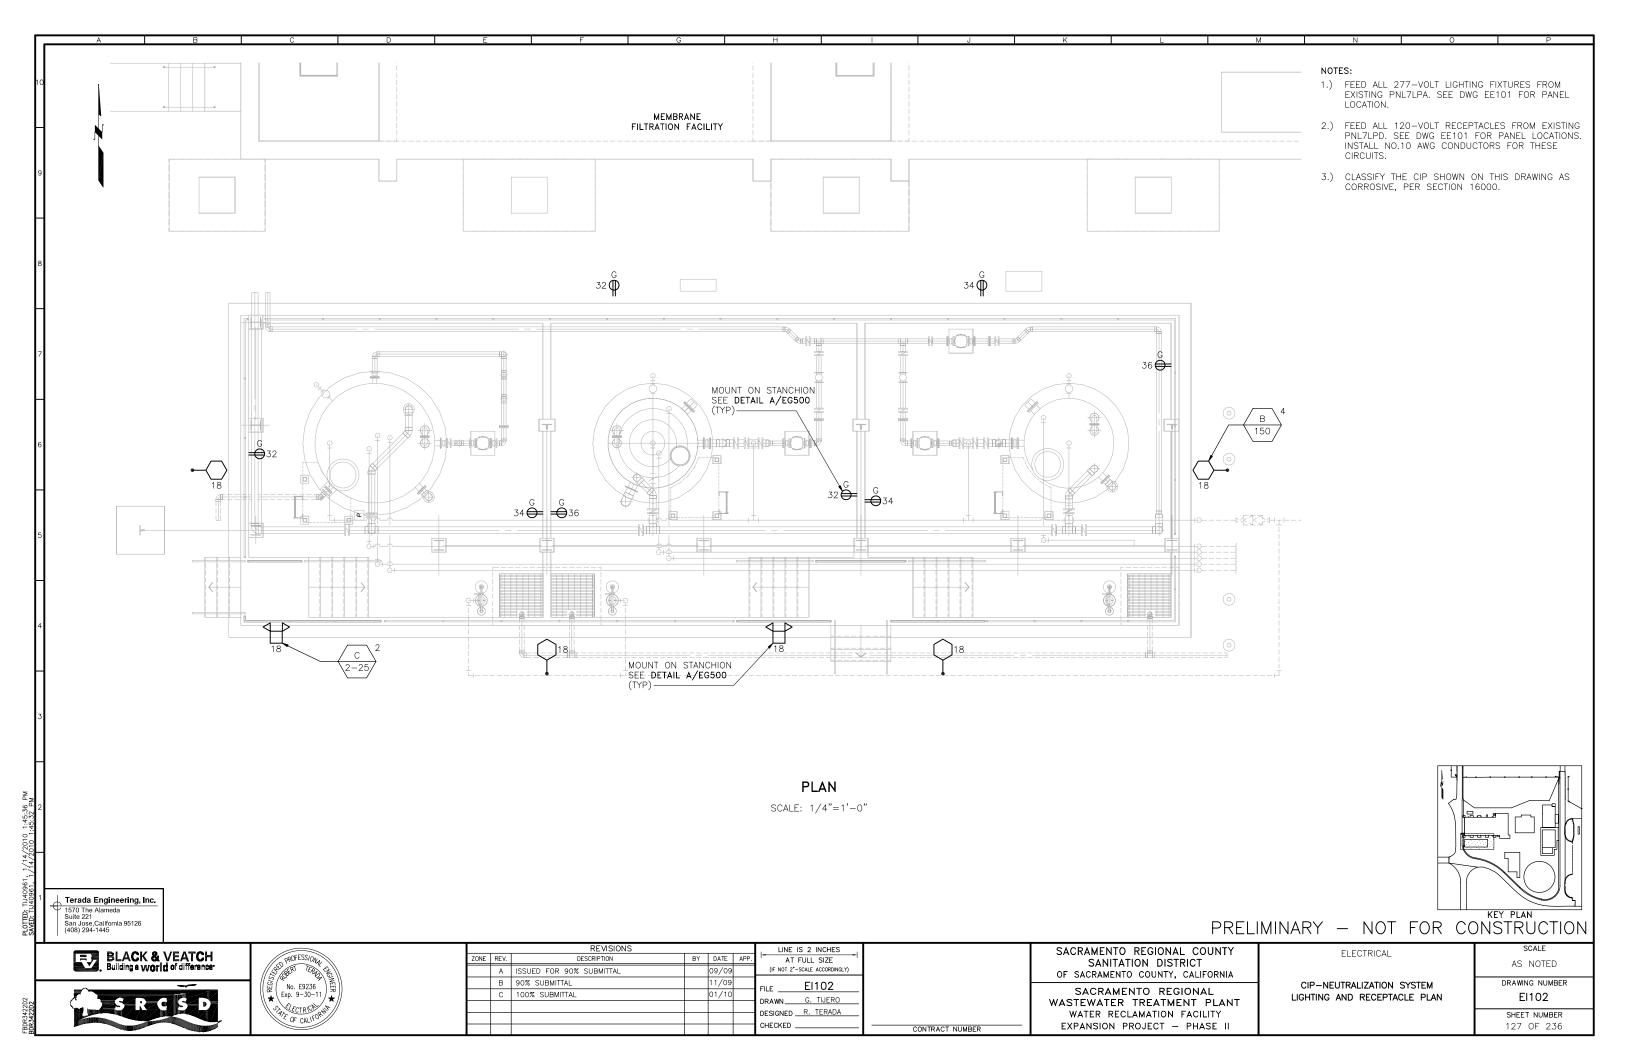
CONTRACT NUMBER


EXPANSION PROJECT - PHASE II


124 OF 236




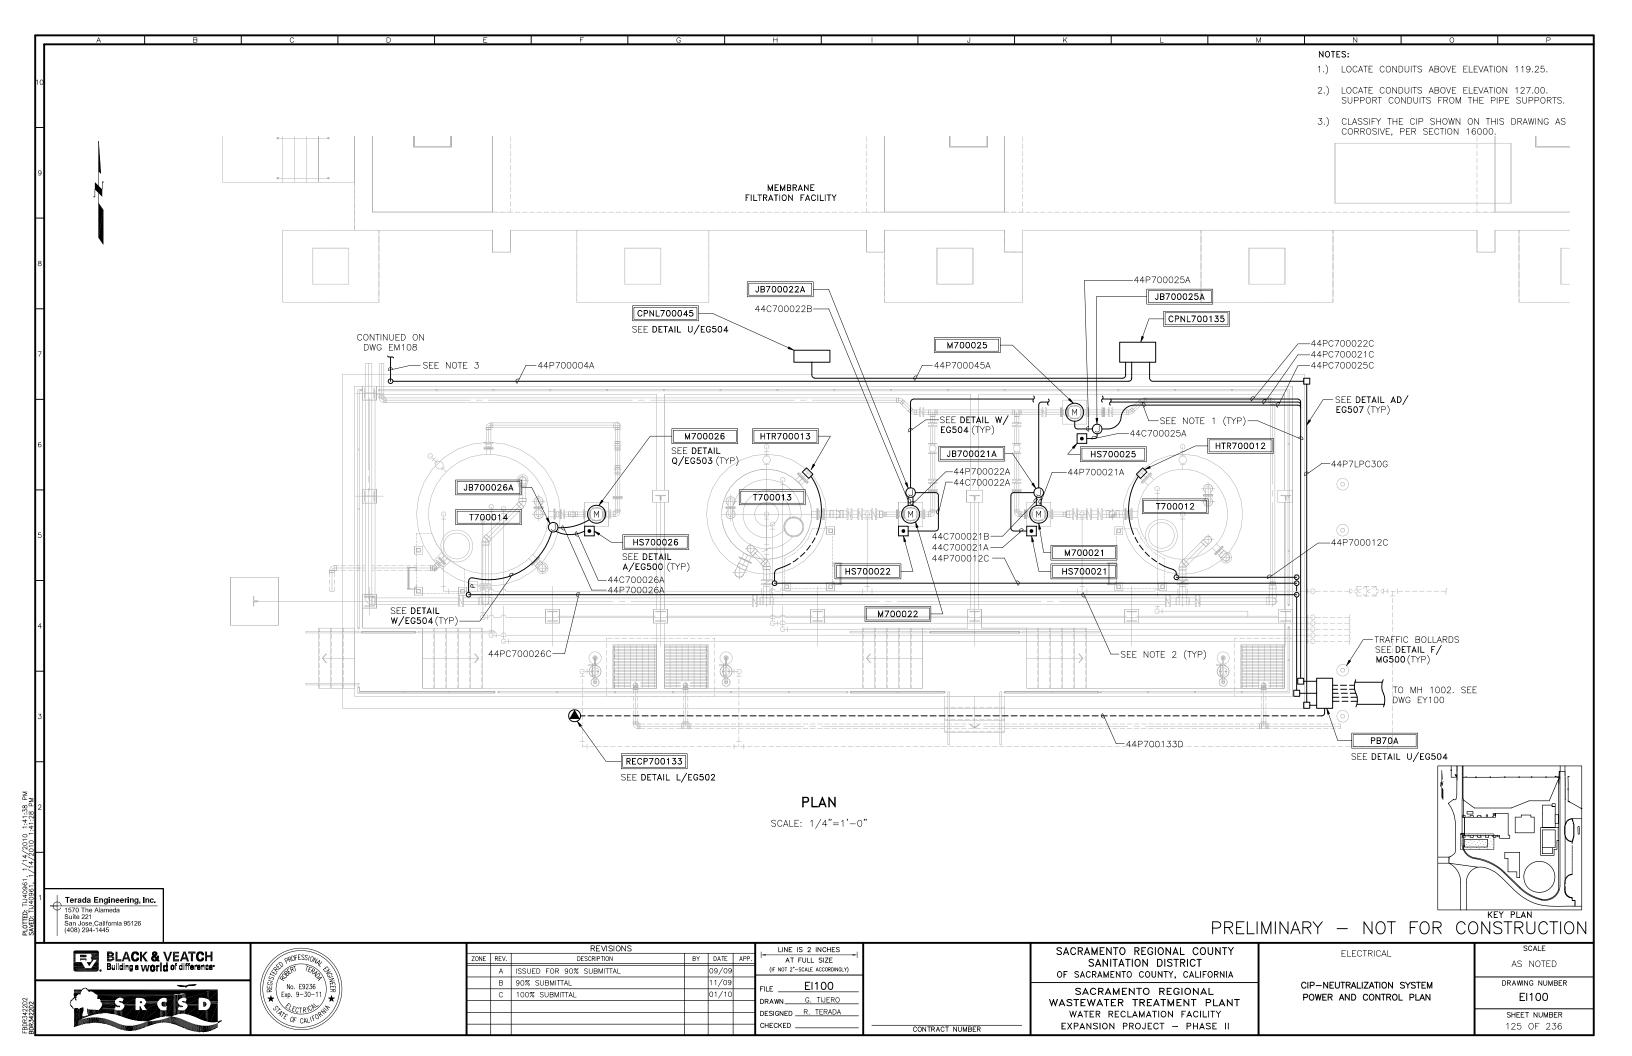


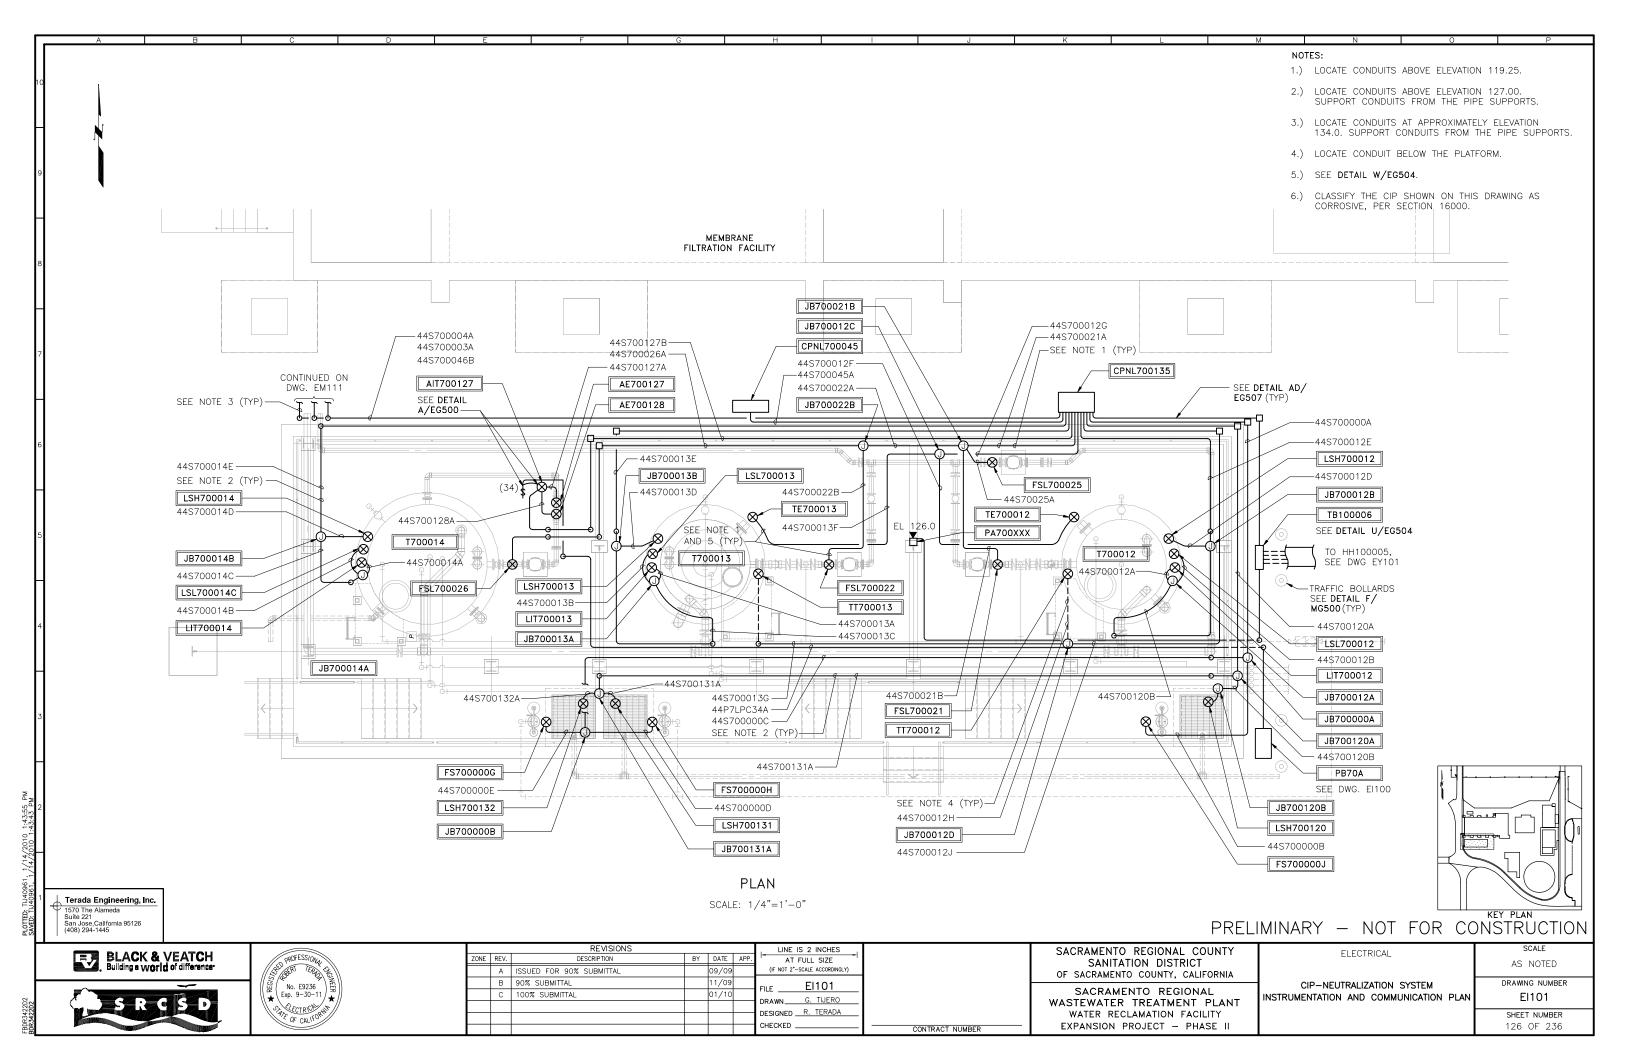


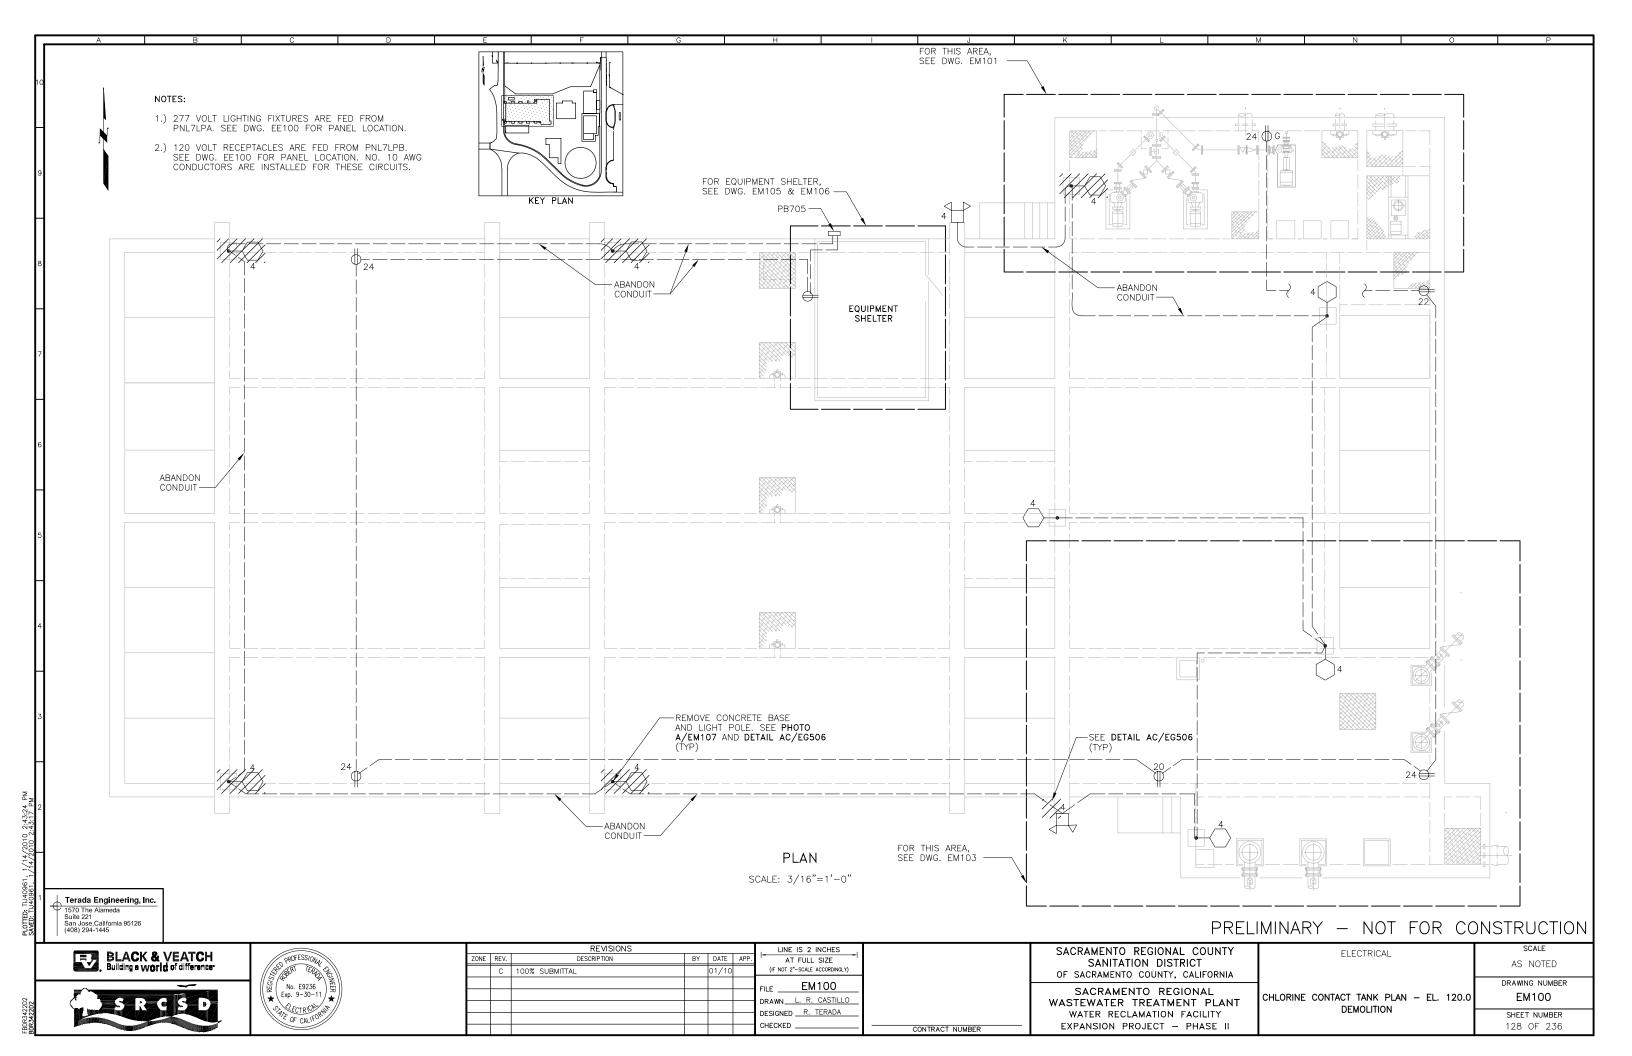


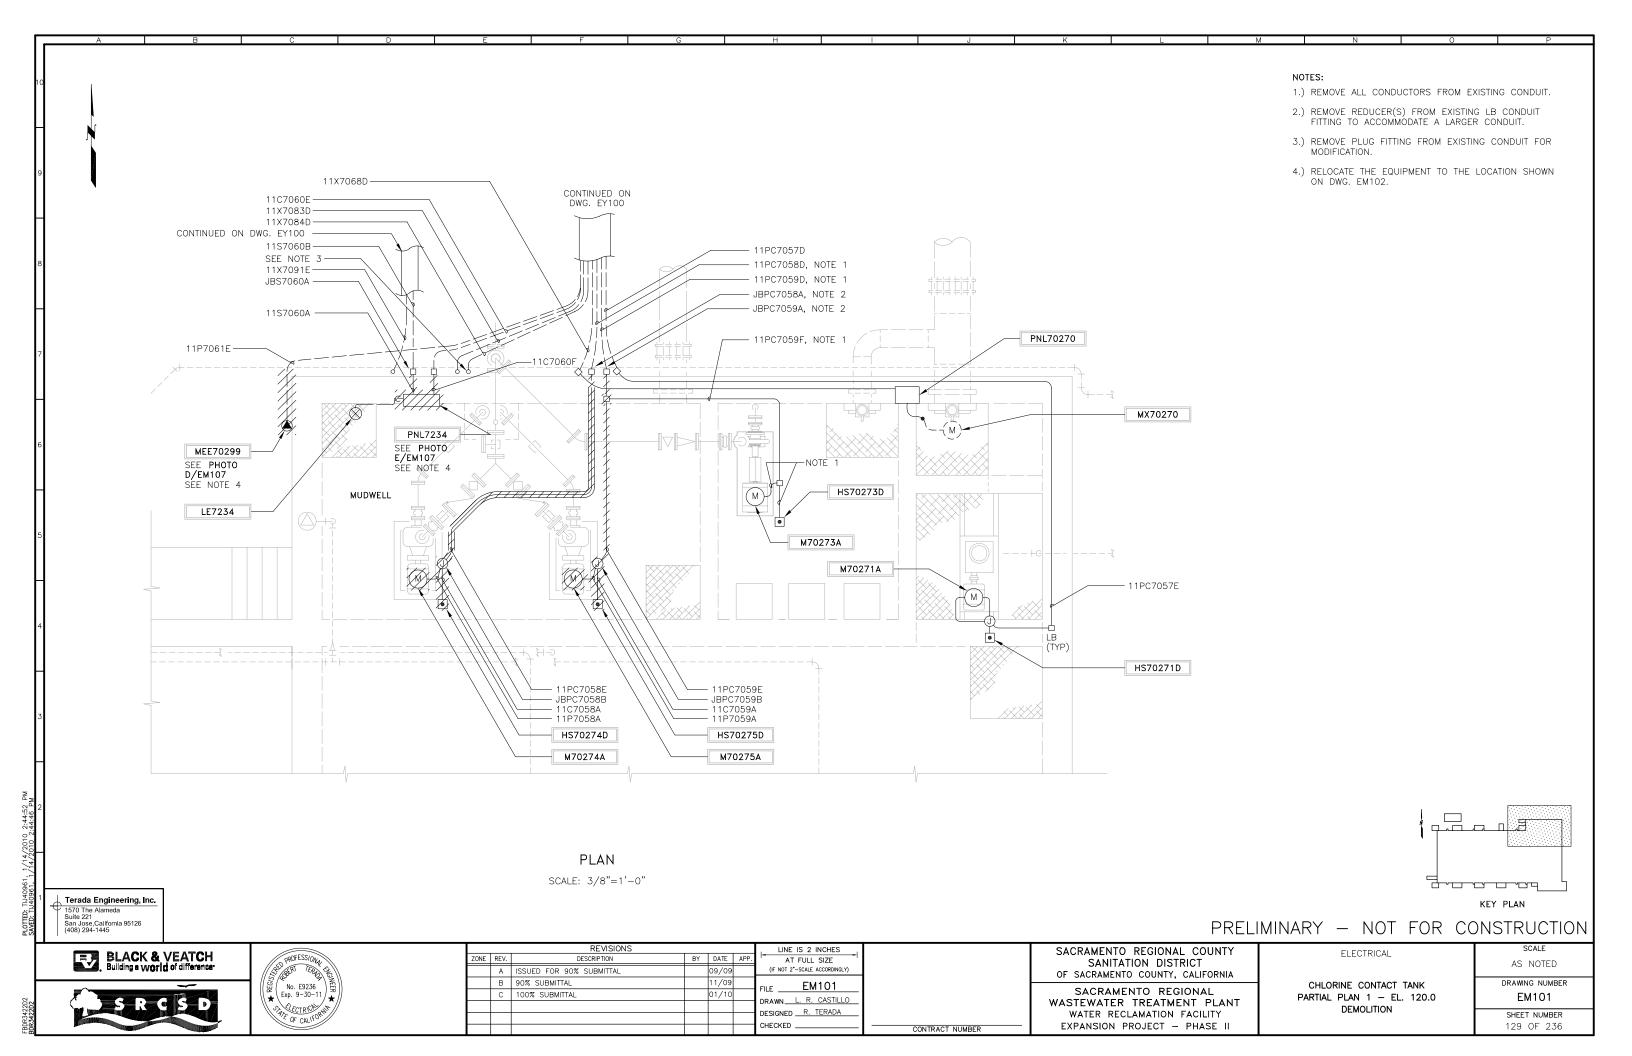


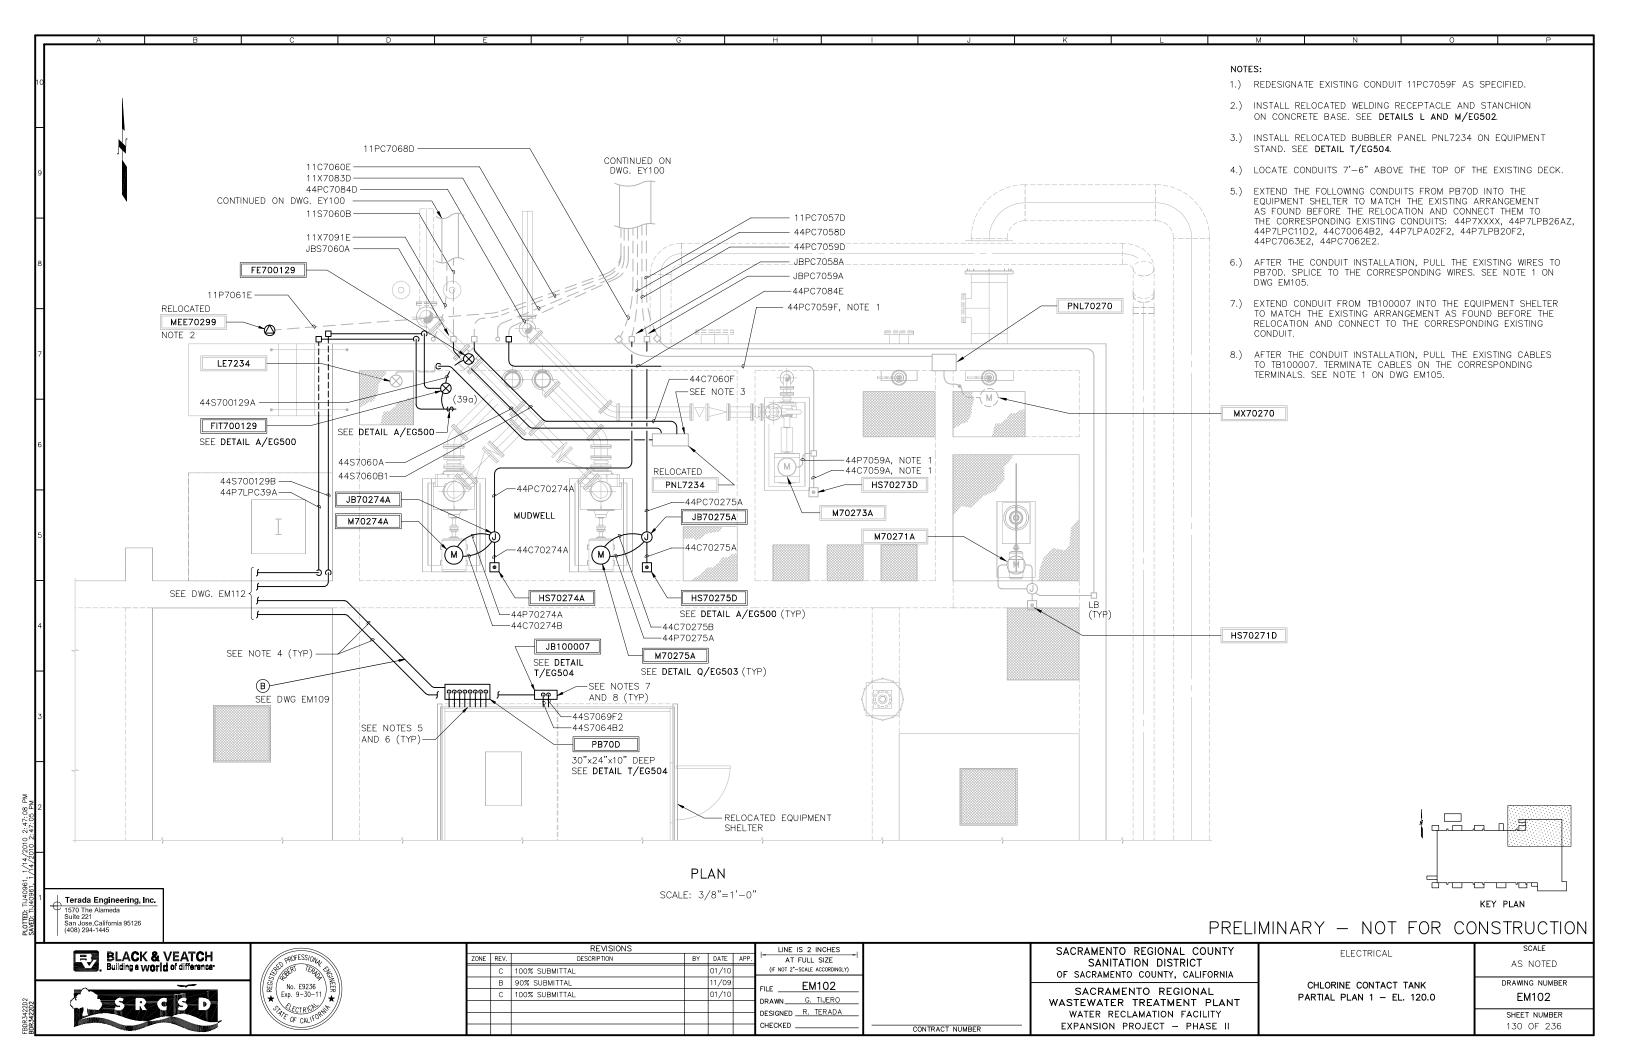


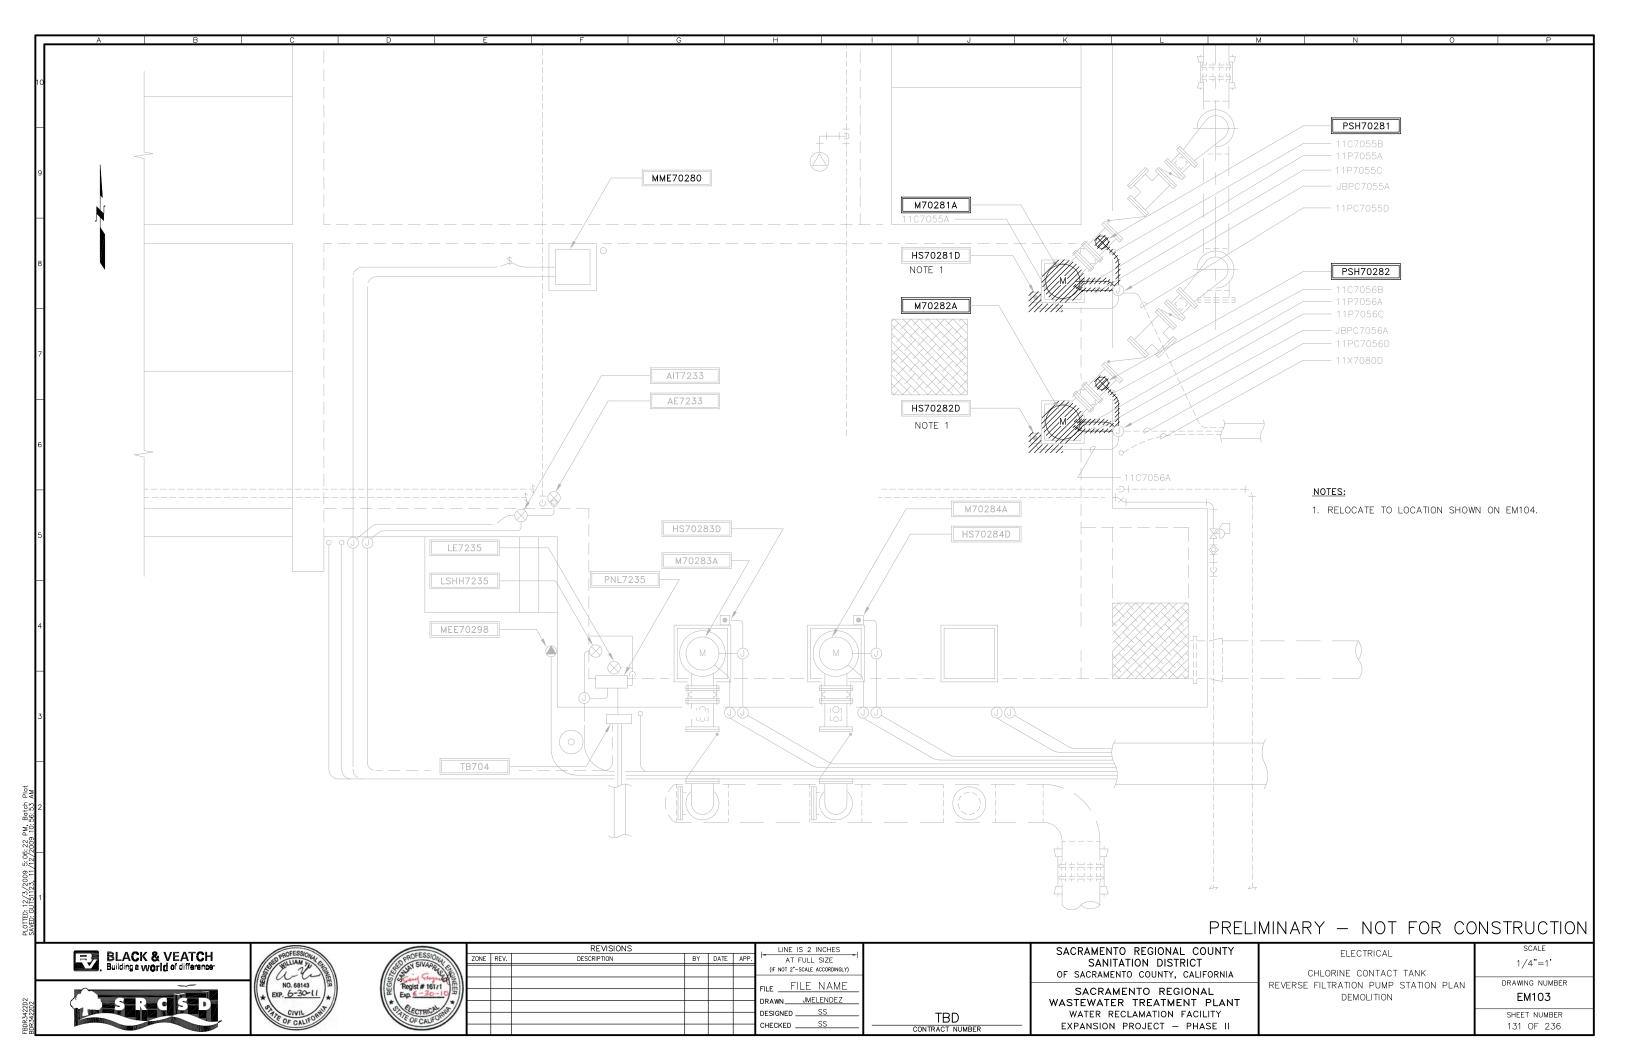


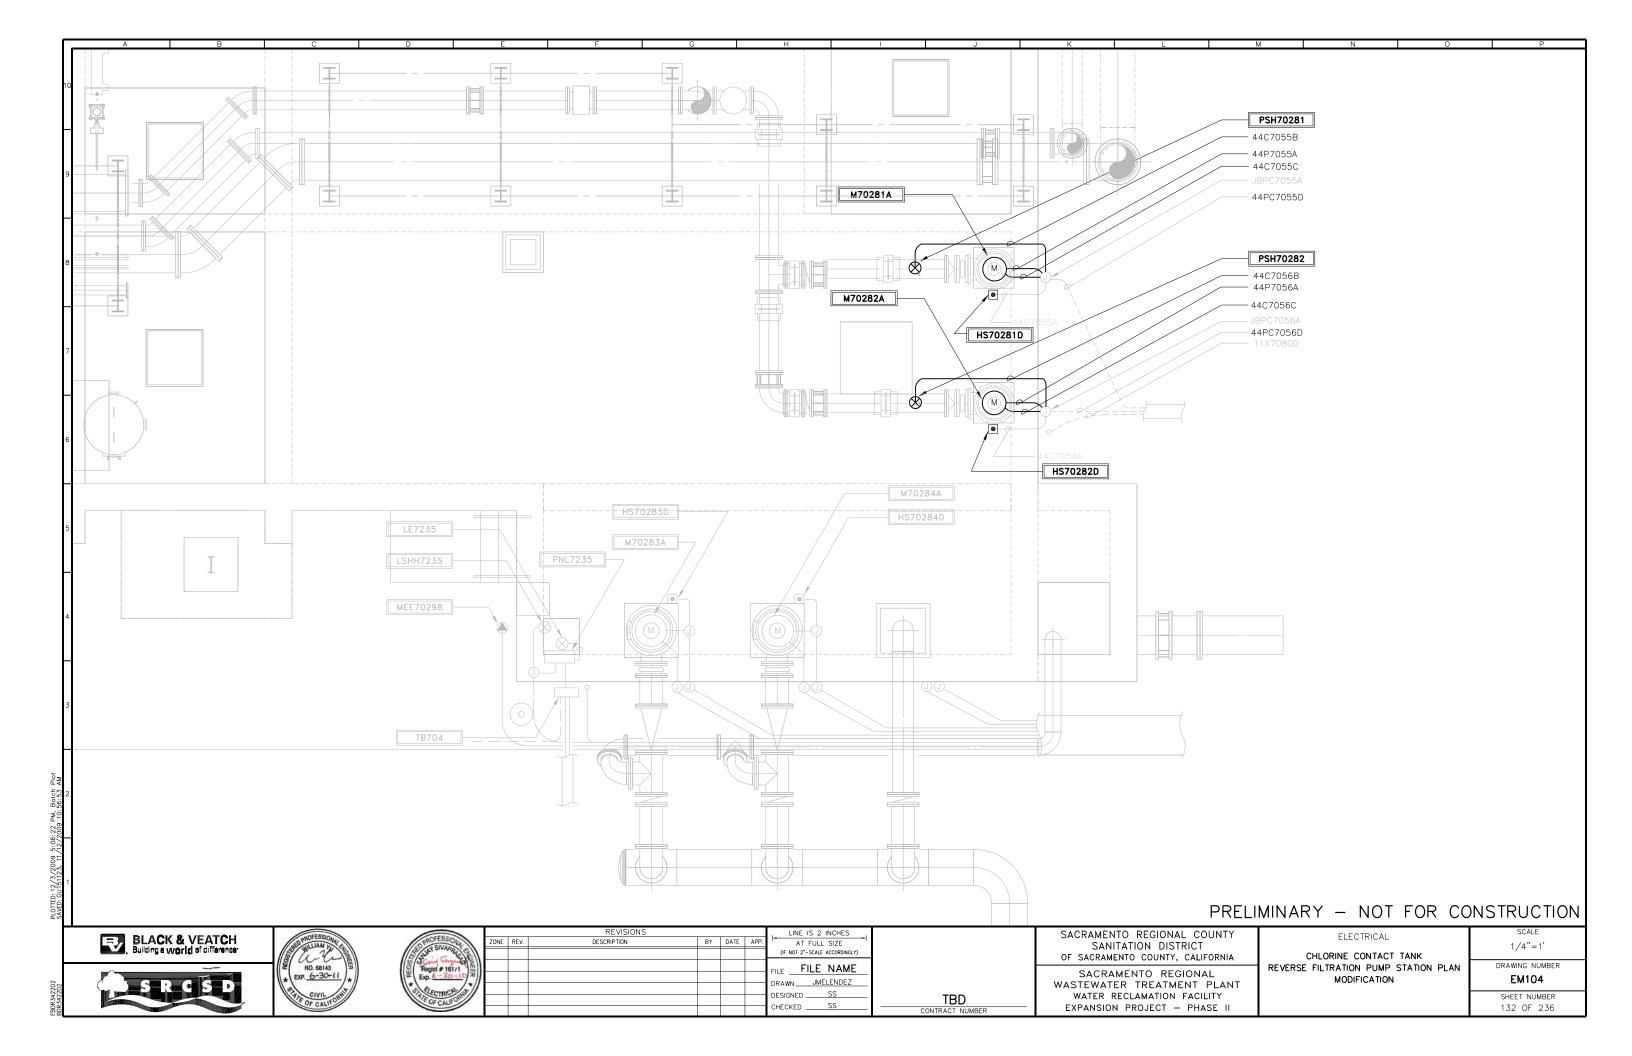


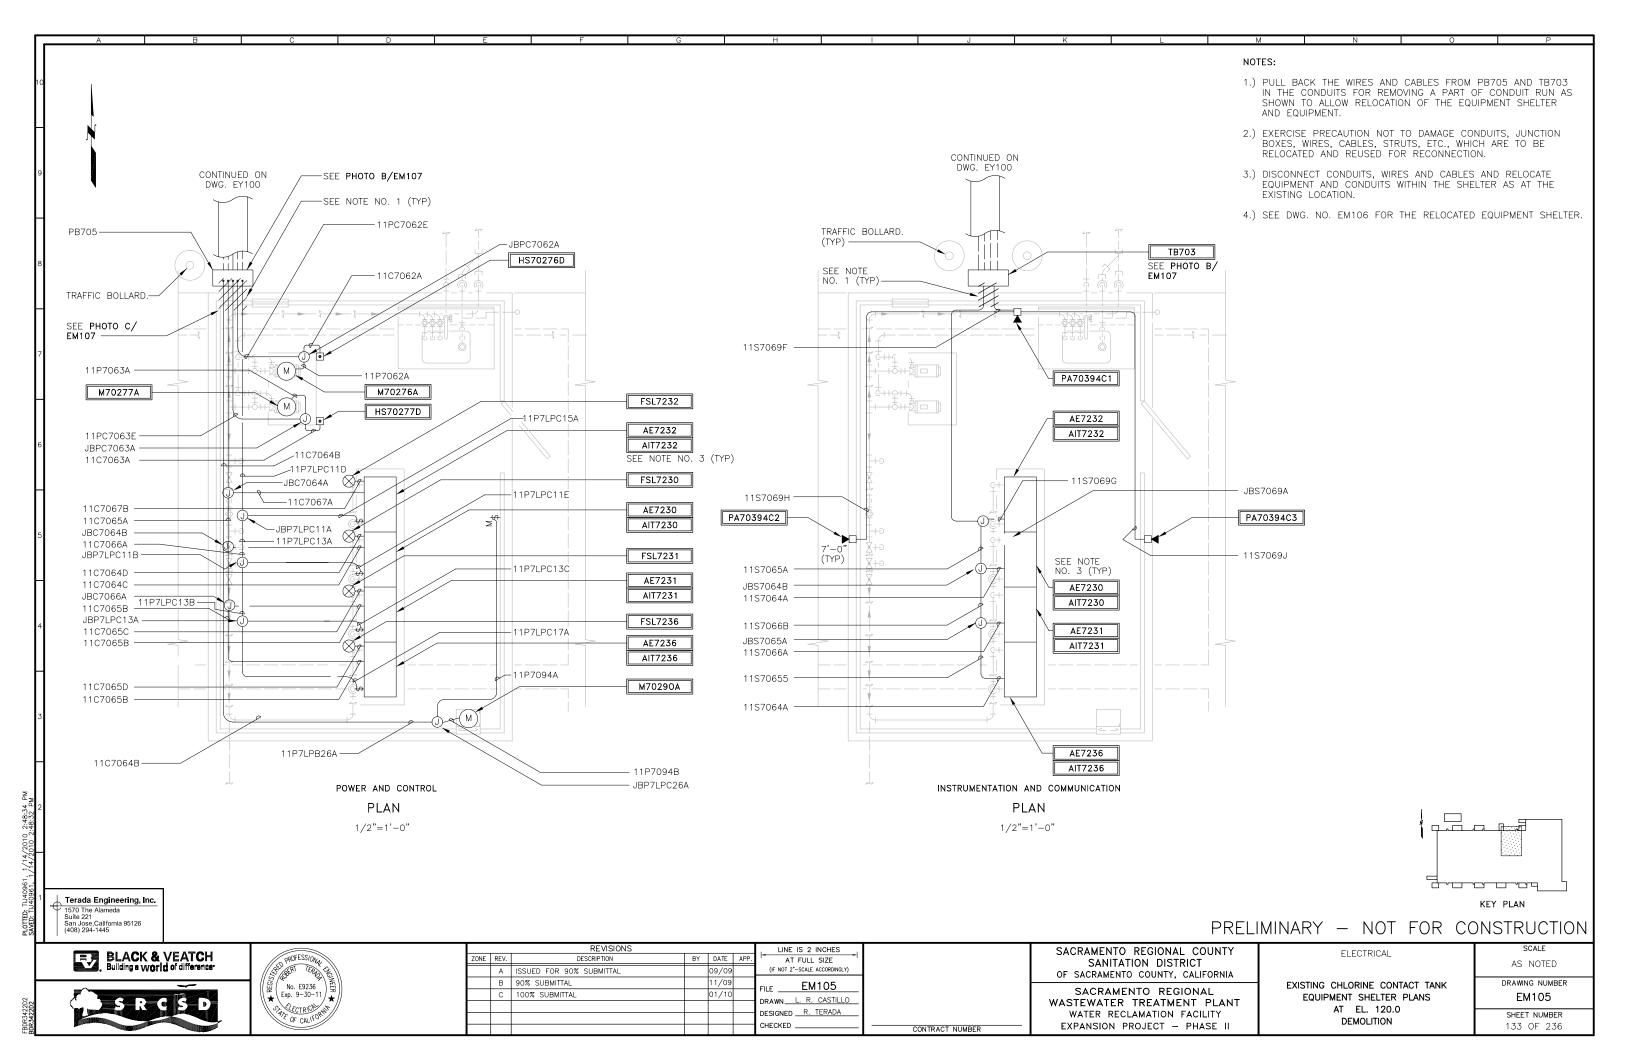


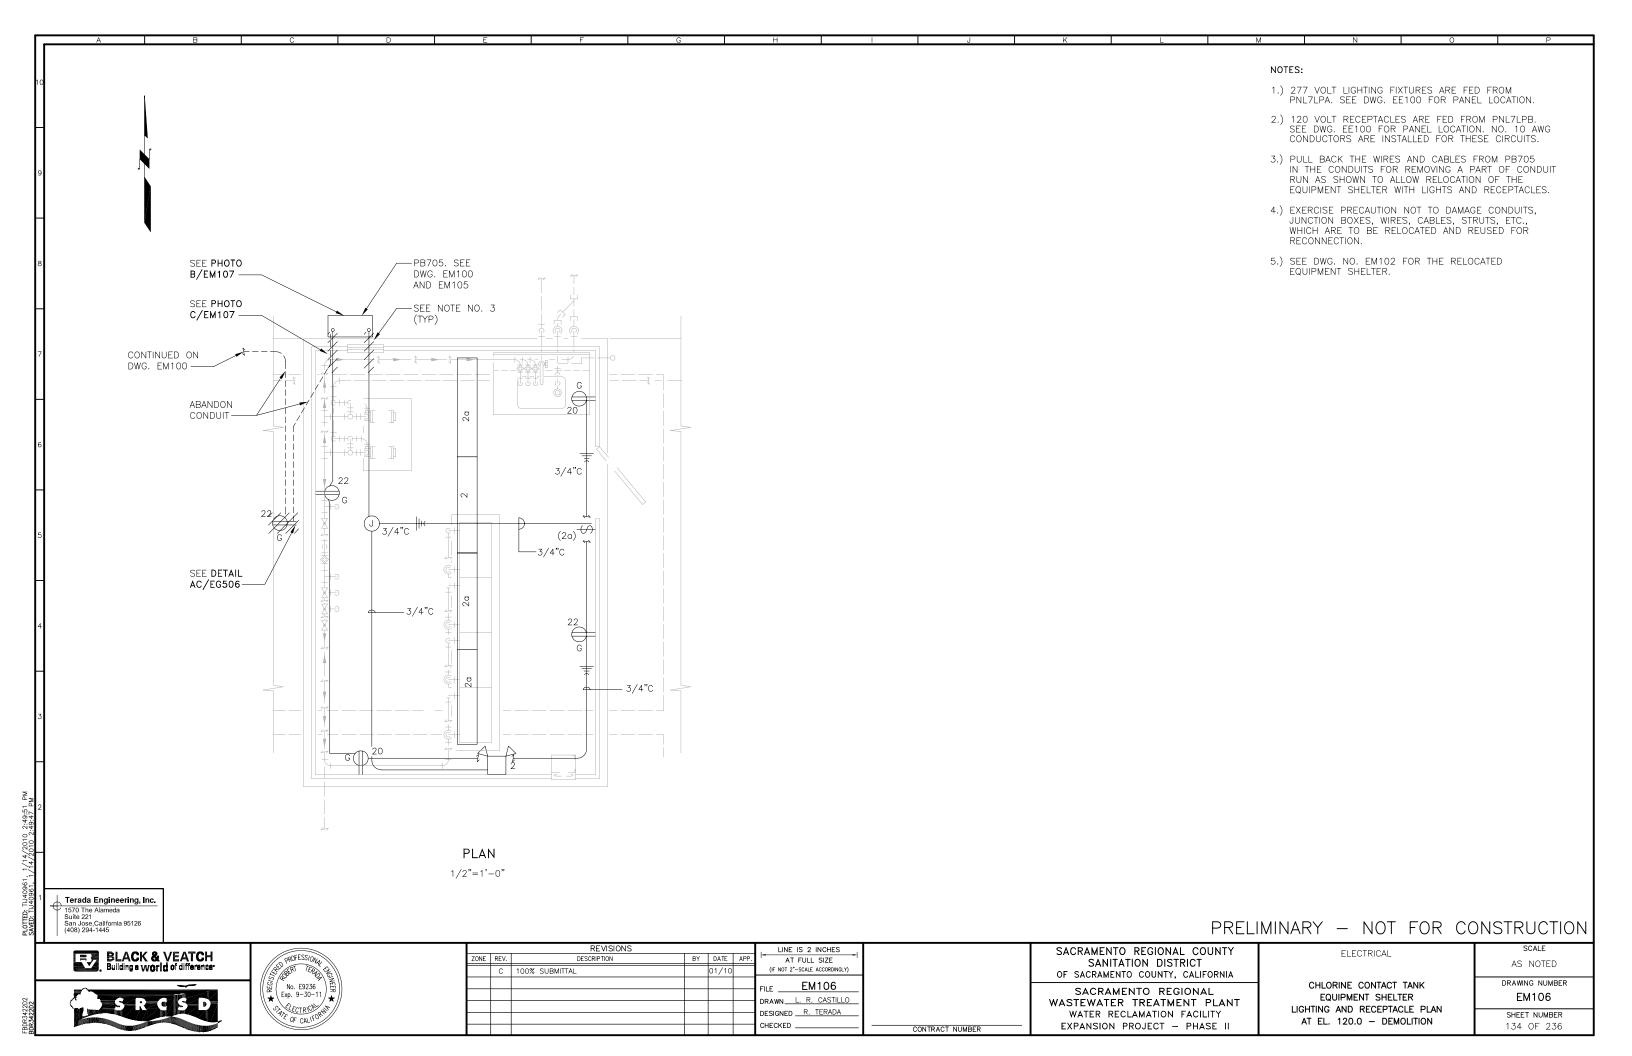


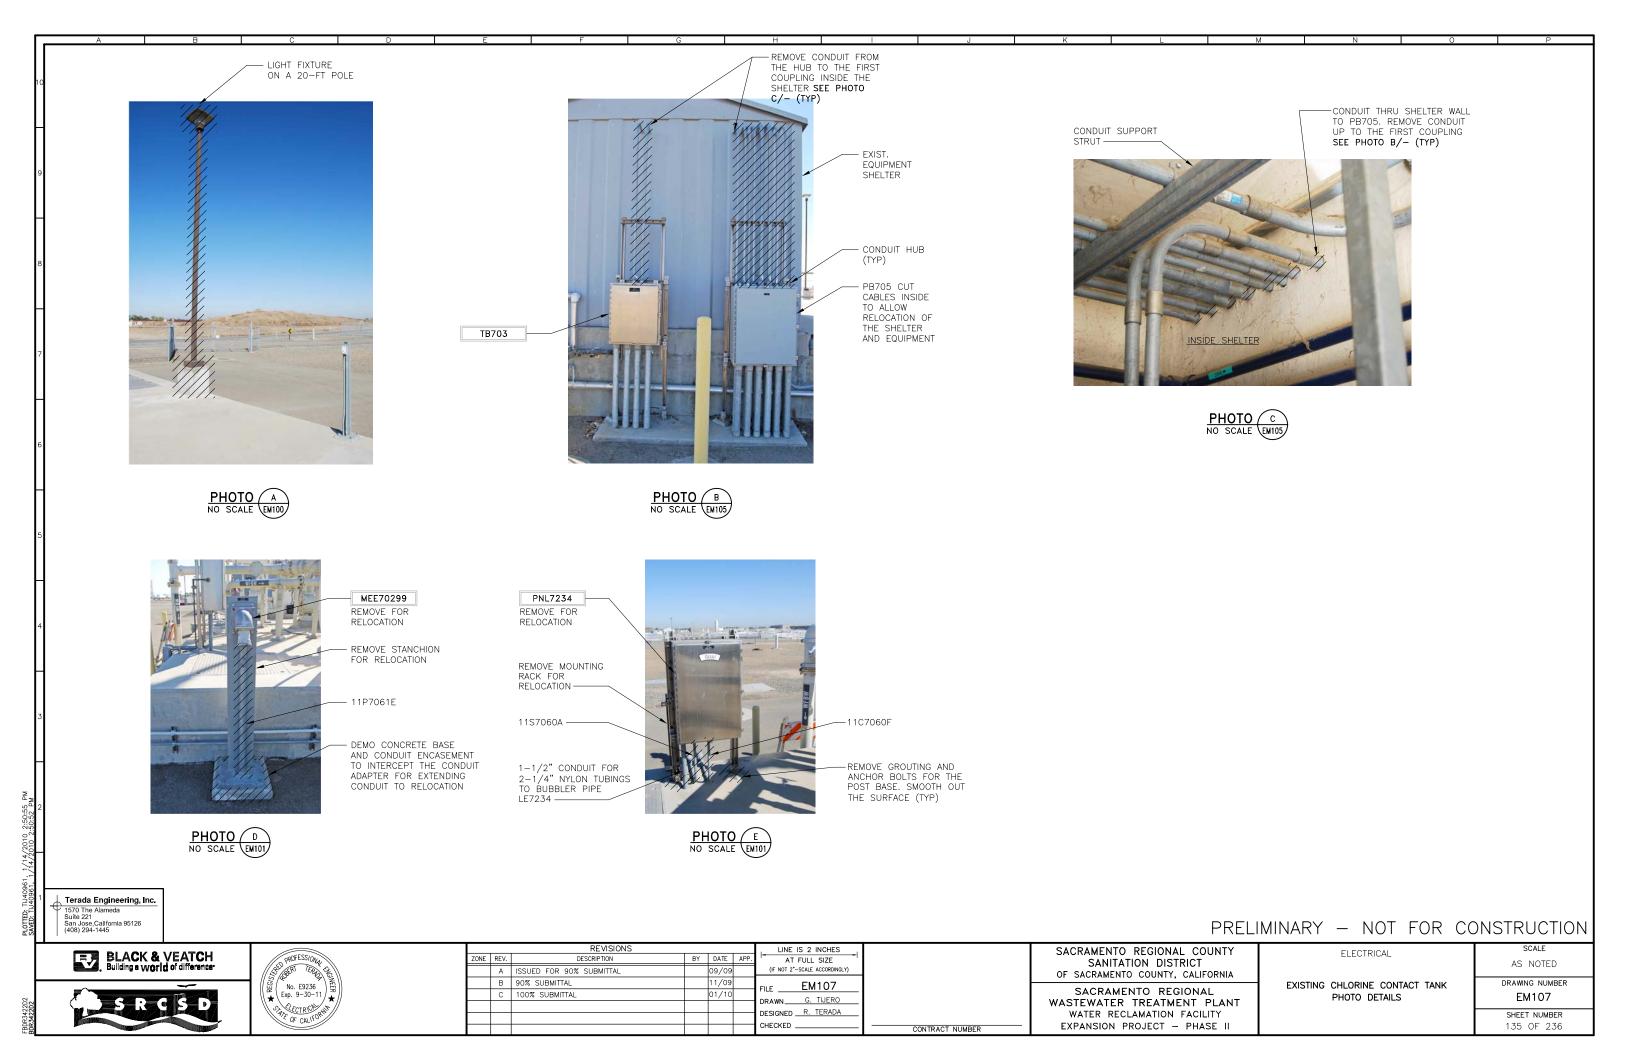


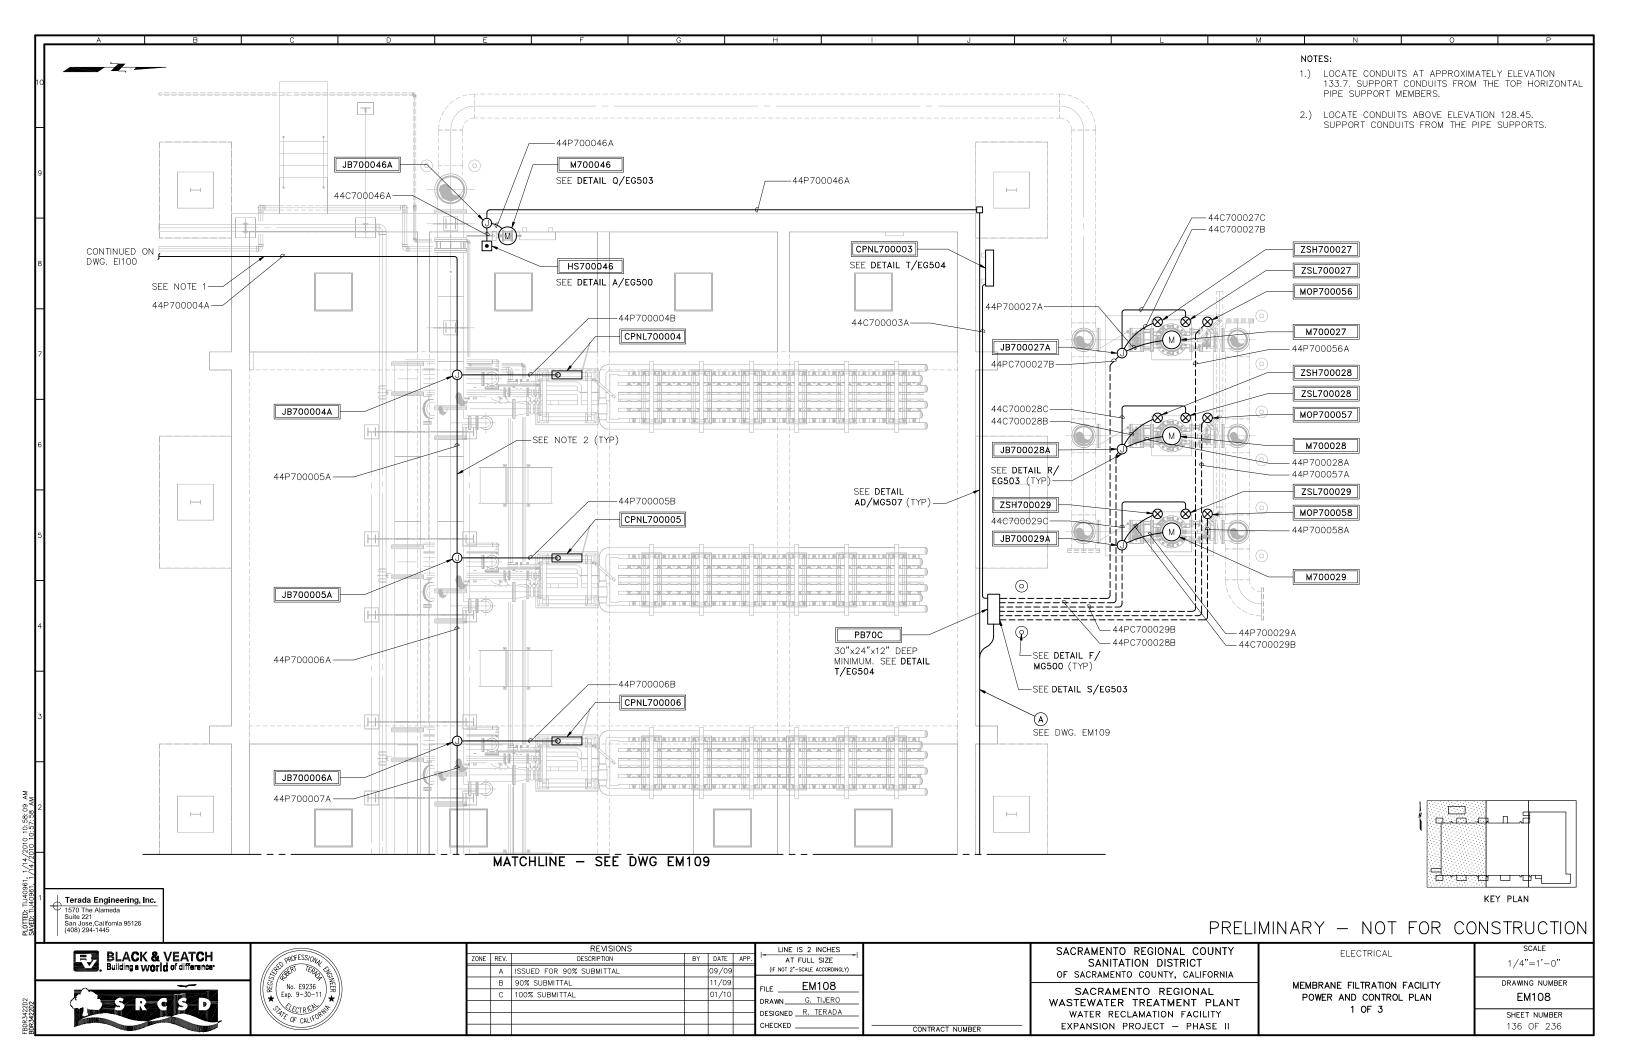


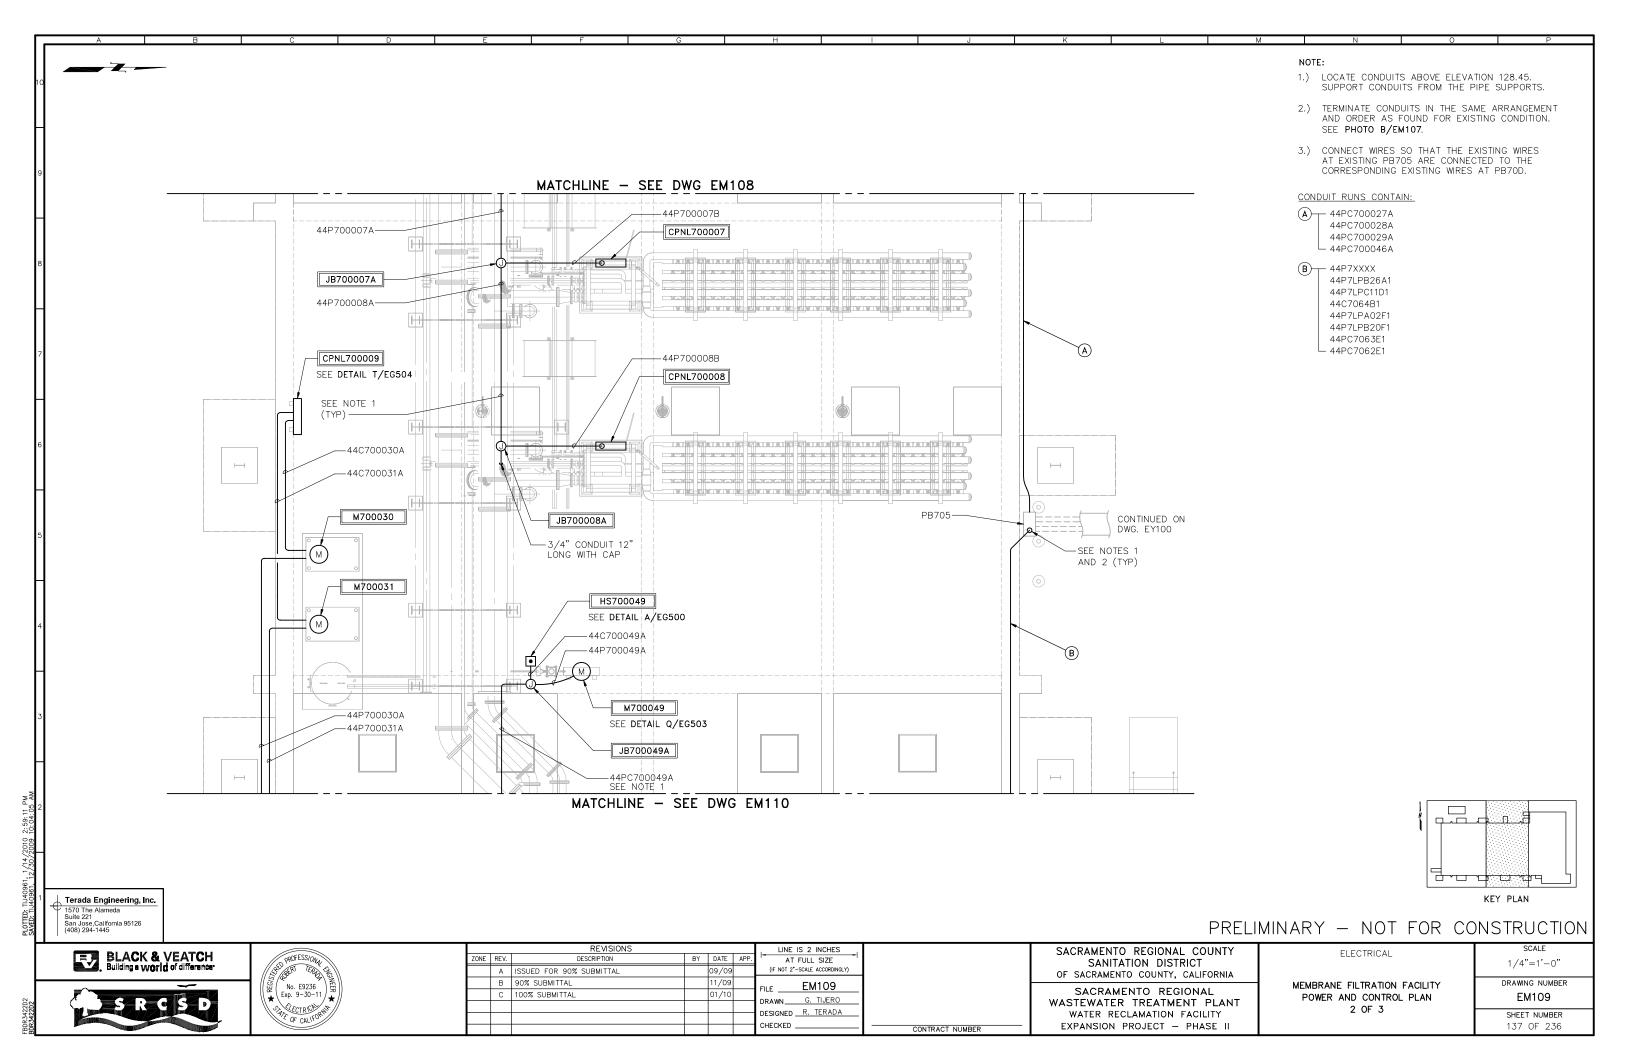


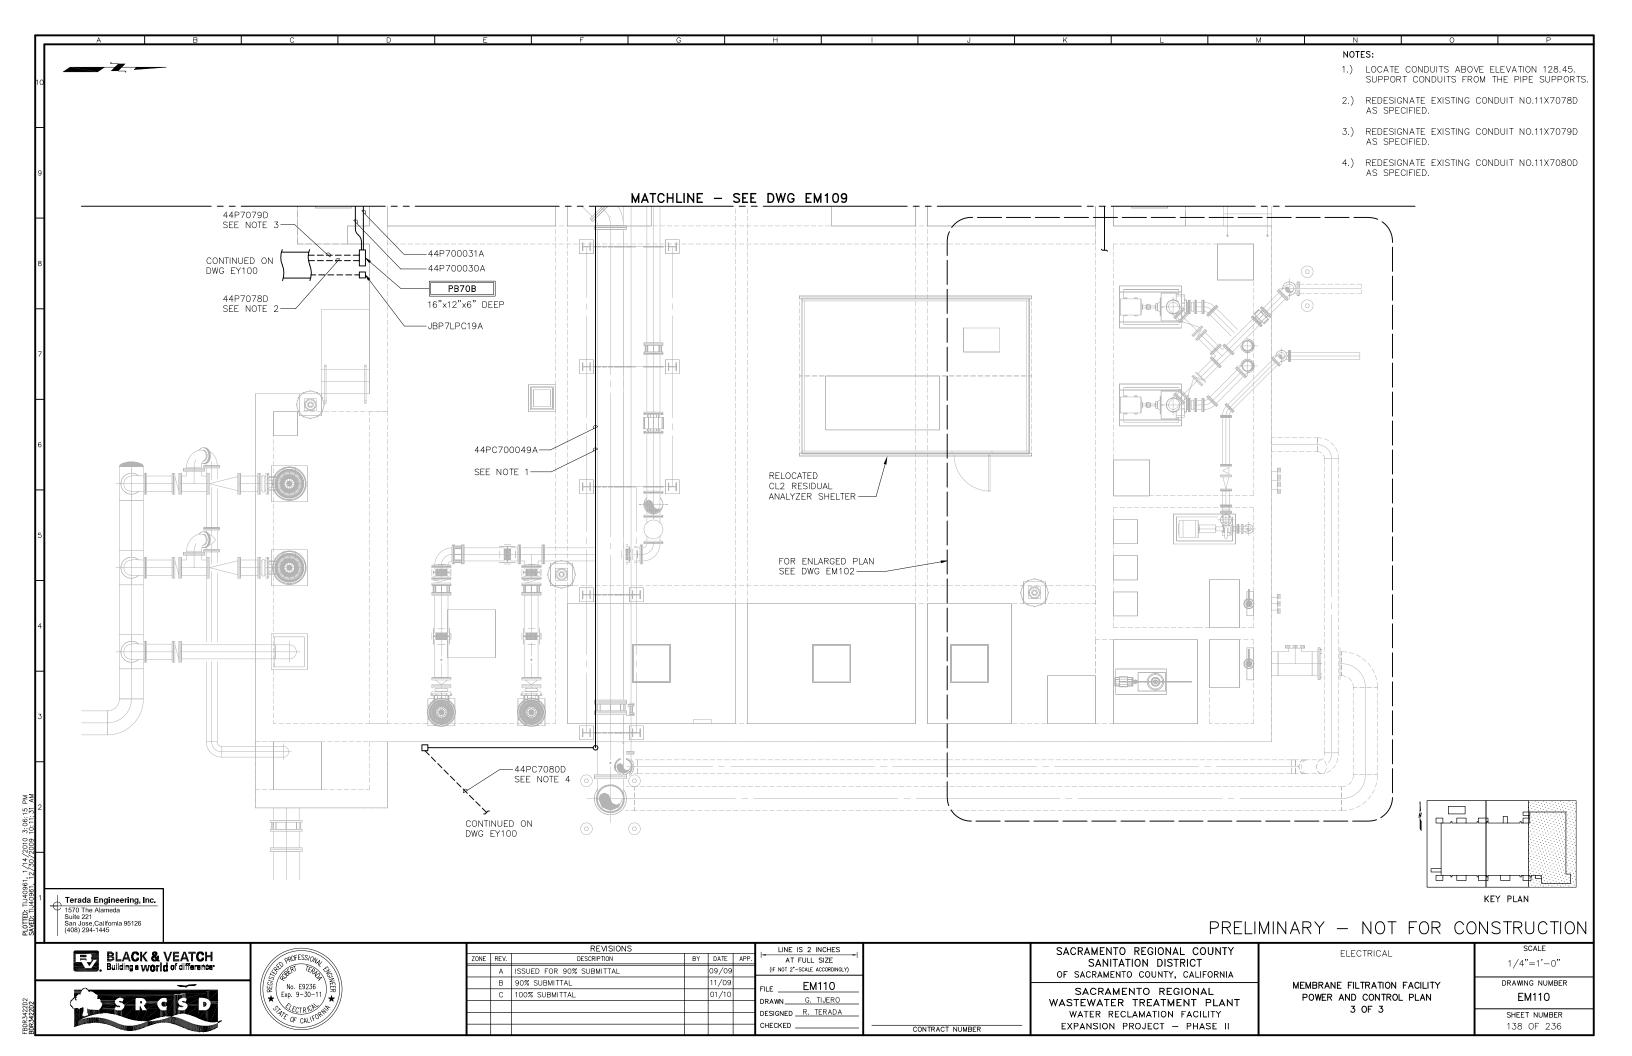


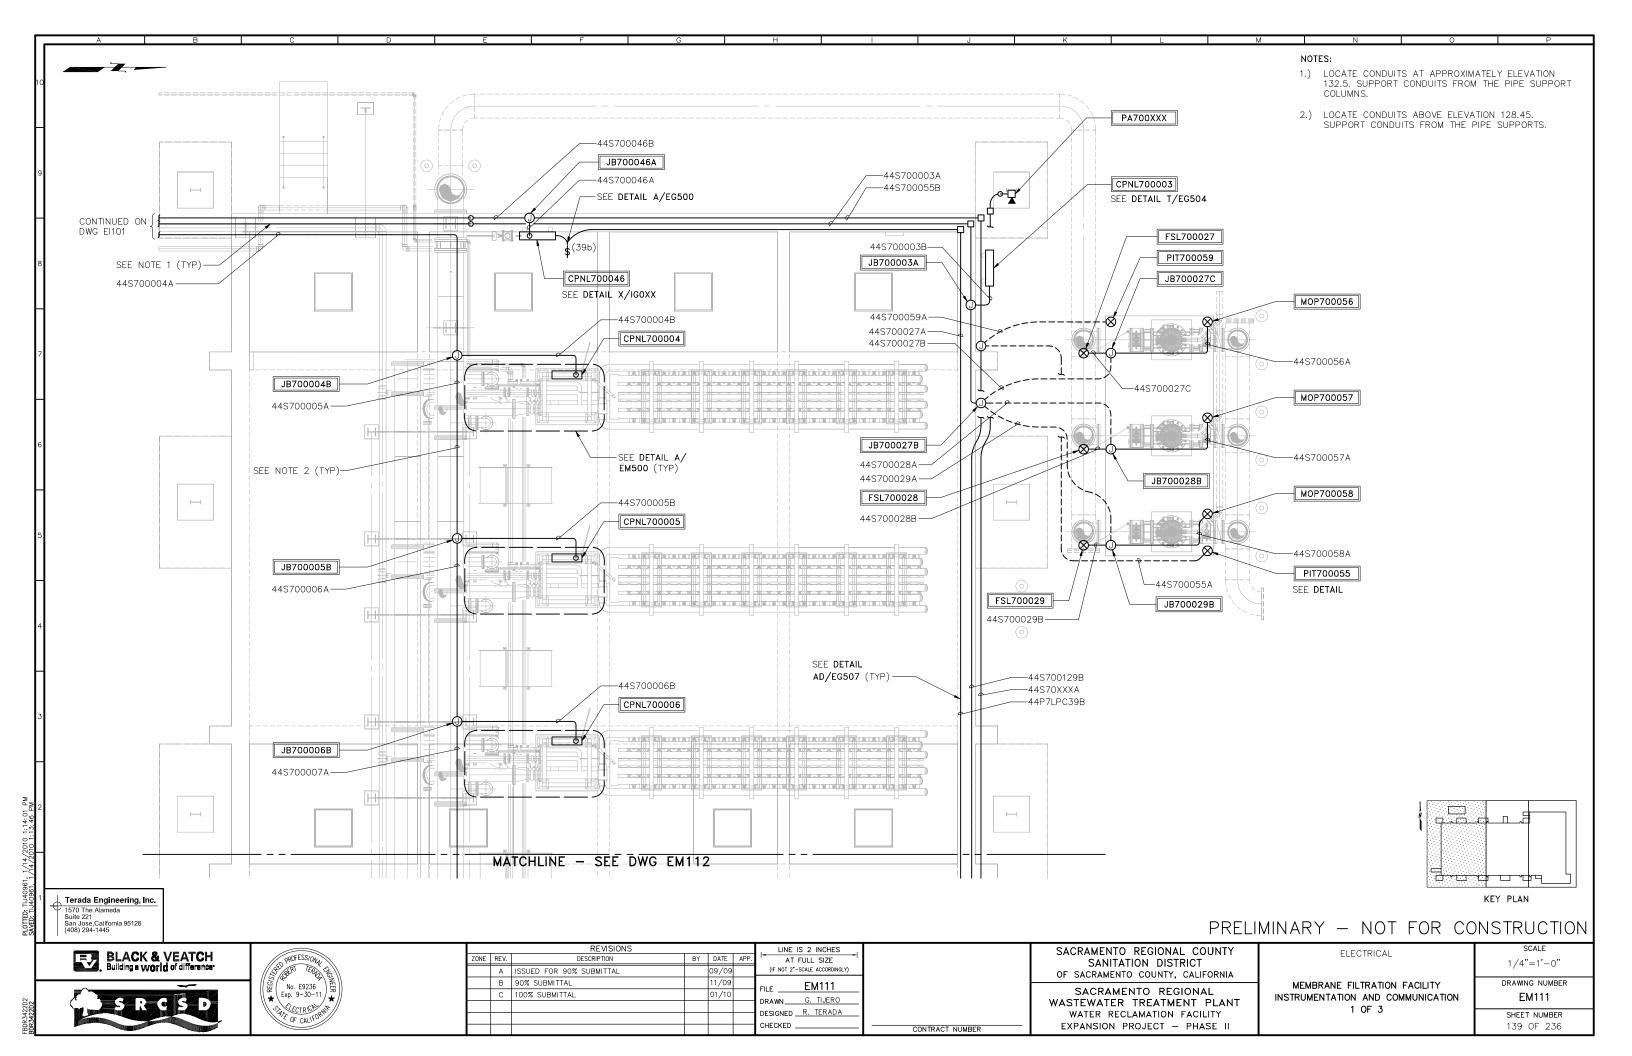


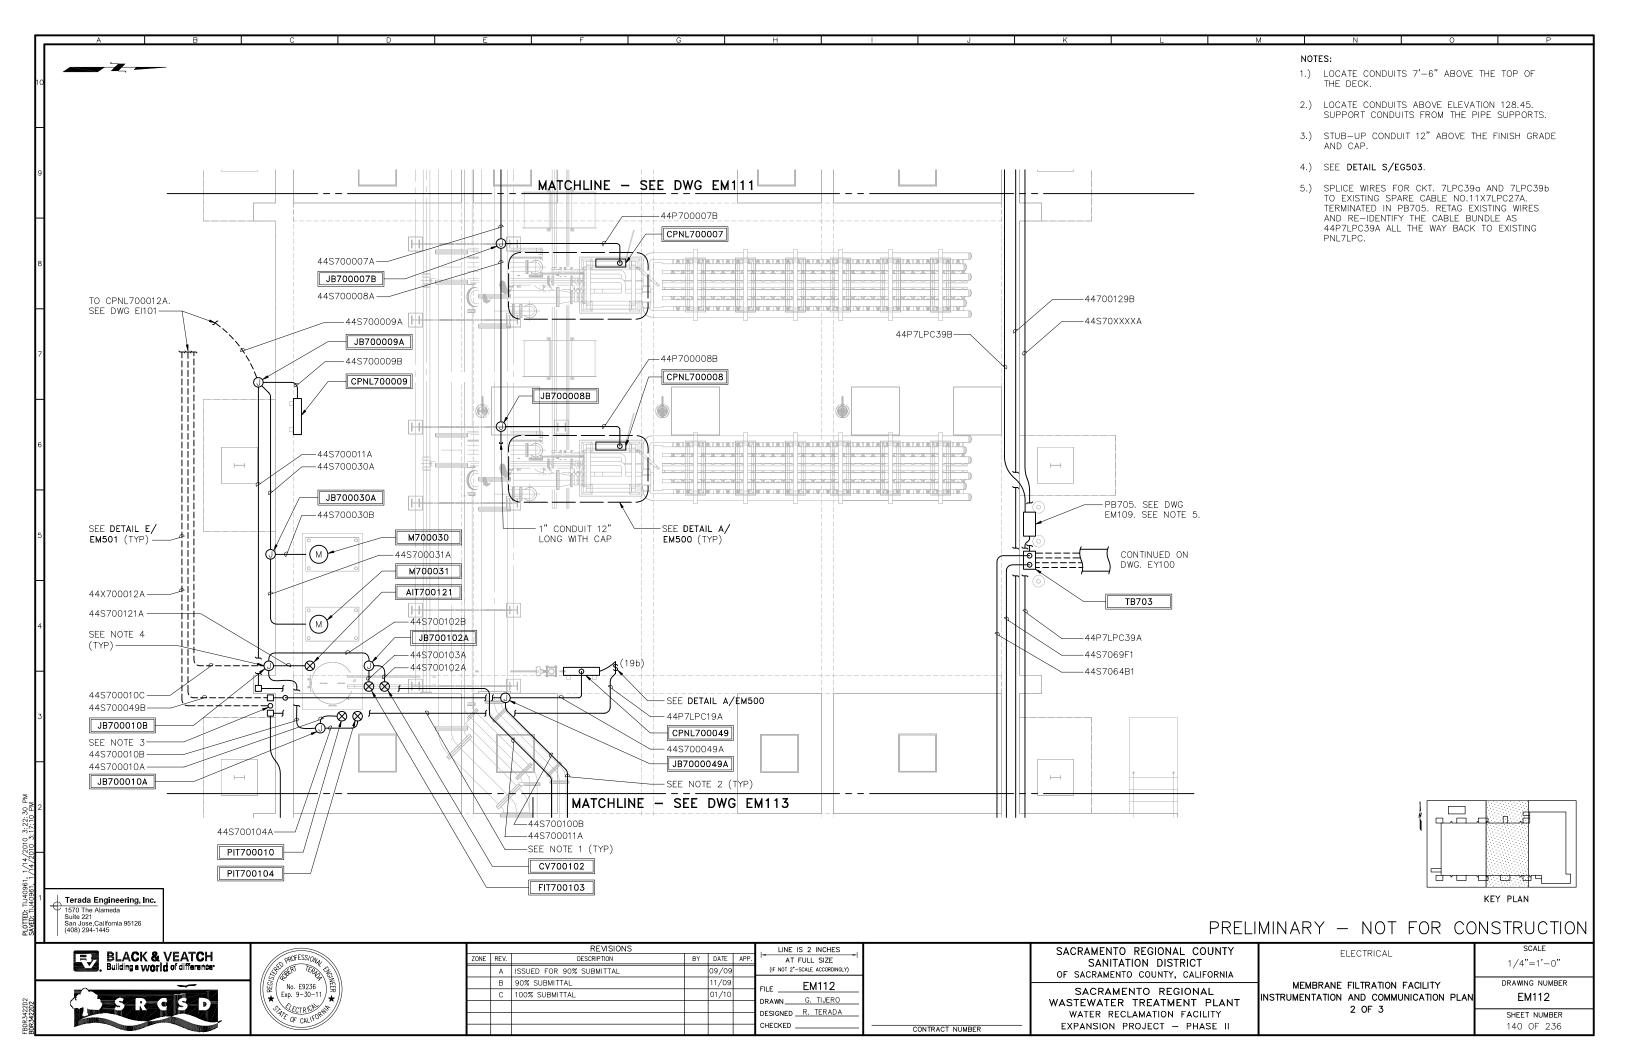

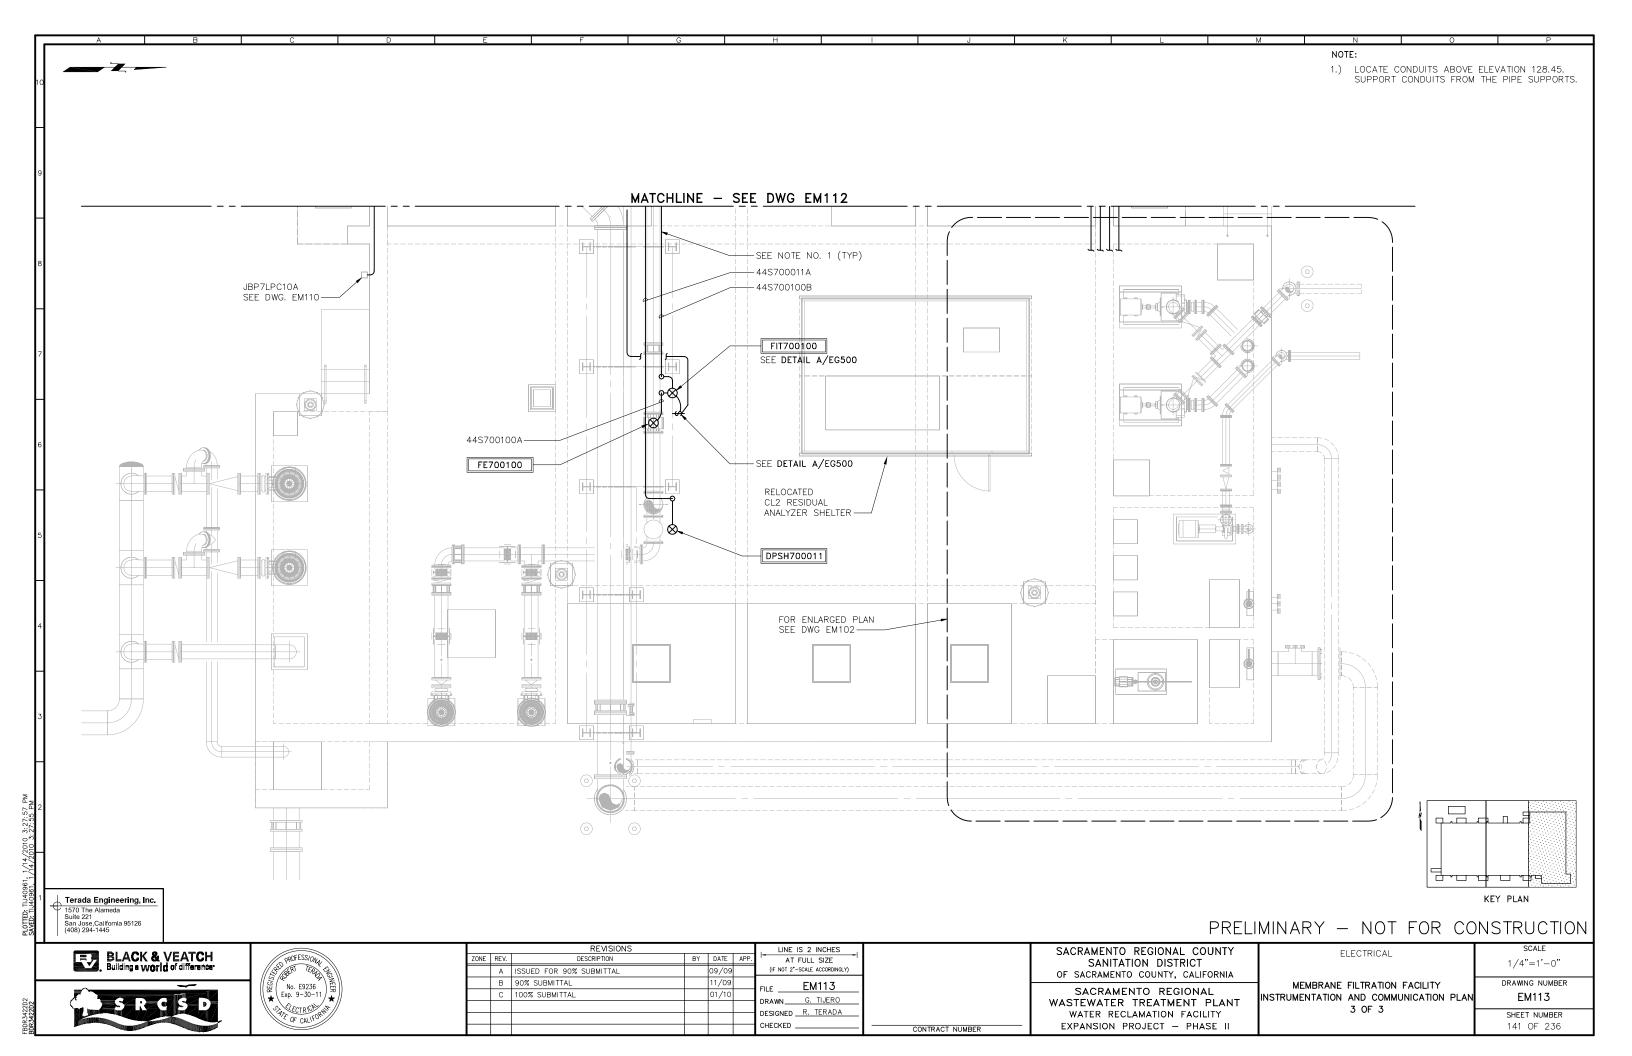

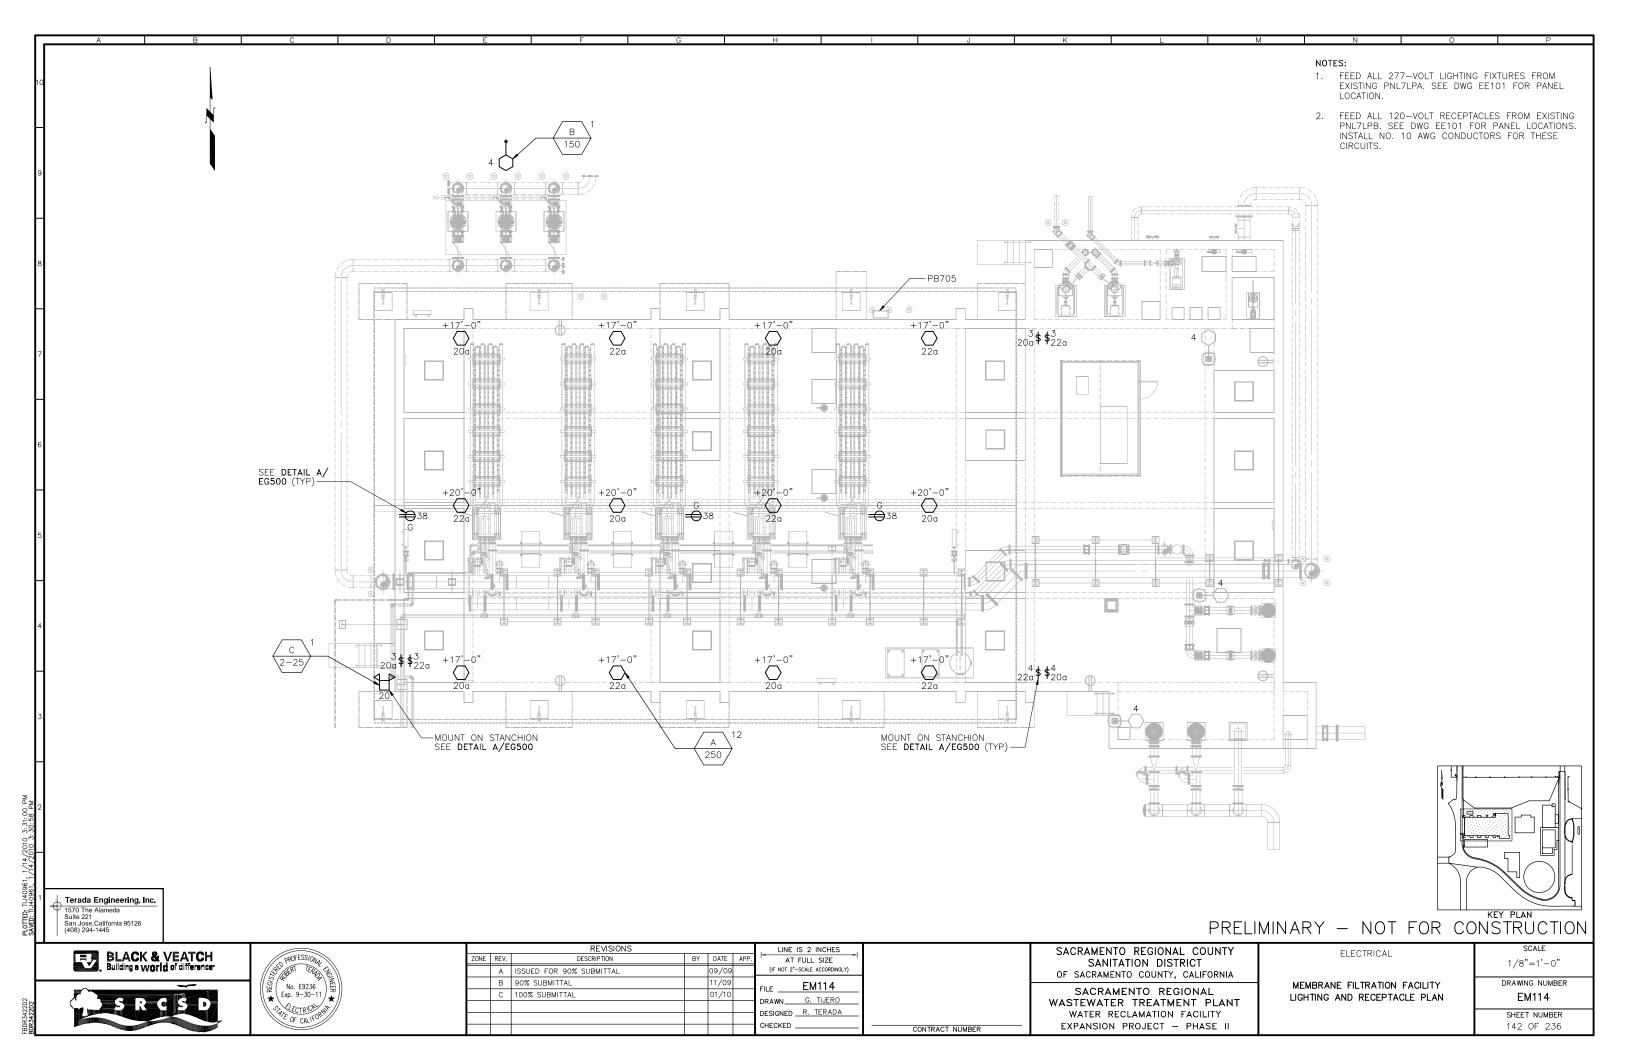

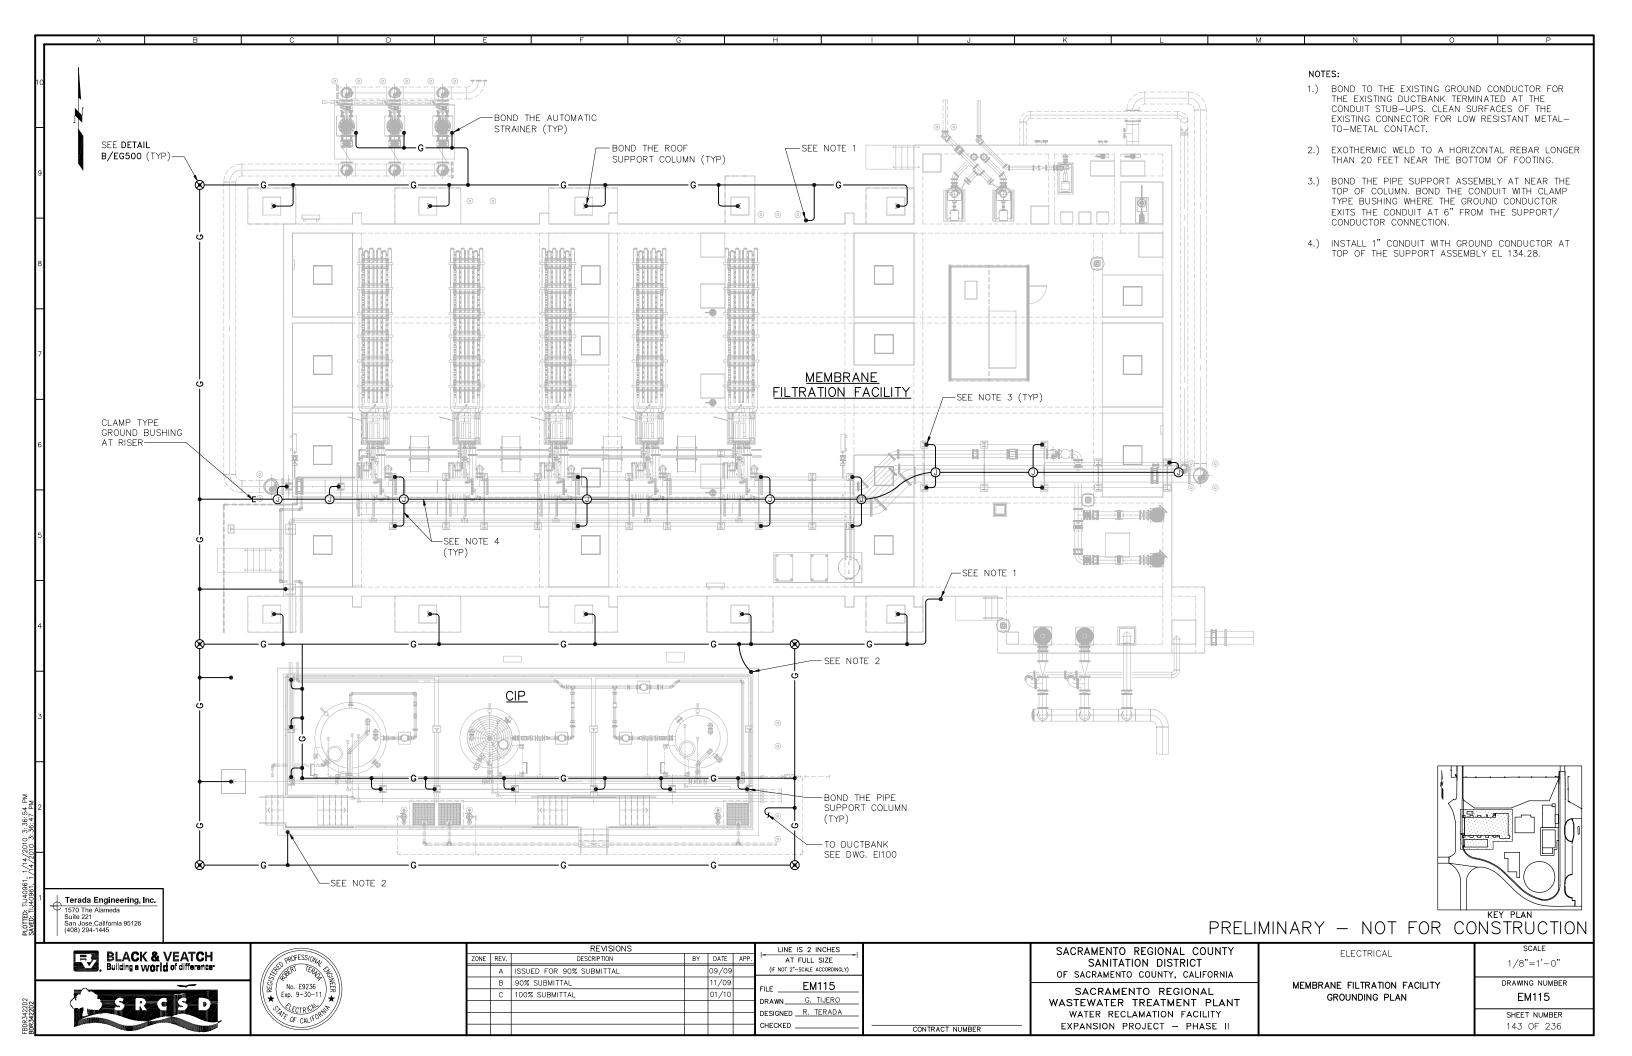

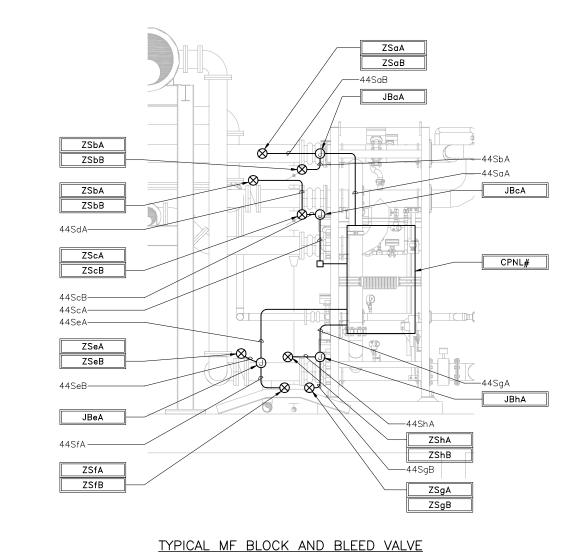

EQUIPMENT NO.	DESCRIPTION	CPN#	а	b	С	d	е	f	g	h
700004	MF UNIT NO.1	CPNL700004	700060	700061	700066	700067	700062	700063	700064	700065
700005	MF UNIT NO.2	CPNL700005	700068	700069	700074	700075	700070	700071	700072	700073
700006	MF UNIT NO.3	CPNL700006	700092	700093	700098	700099	700094	700095	700096	700097
700007	MF UNIT NO.4	CPNL700007	700076	700077	700082	700083	700078	700079	700080	700081
700008	MF UNIT NO.5	CPNL700008	700084	700085	700090	700091	700086	700087	700088	700089

TYPICAL MF BLOCK AND BLEED VALVE LIMIT SWITCH CONDUIT RUNS

PRELIMINARY - NOT FOR CONSTRUCTION



Terada Engineering, Inc. 1570 The Alameda Suite 221 San Jose, California 95126 (408) 294-1445



		REVISIONS	LINE IS 2 INCHES			
ZONE	REV.	DESCRIPTION	BY	DATE	APP.	AT FULL SIZE
	Α	ISSUED FOR 90% SUBMITTAL		09/09		(IF NOT 2"-SCALE ACCORDINGLY)
	В	90% SUBMITTAL		11/09		FILE EM500
	С	100% SUBMITTAL		01/10		
						Divinit
						DESIGNED R. TERADA
						CHECKED

	FULL SIZE -SCALE ACCORDINGLY)
FILE	EM500
DRAWN	G. TIJERO
DESIGNED	R. TERADA
CHECKED	


SACRAMENTO REGIONAL COUNTY
SANITATION DISTRICT
OF SACRAMENTO COUNTY, CALIFORNIA
SACRAMENTO REGIONAL


SACRAMENTO REGIONAL
ASTEWATER TREATMENT PLANT
WATER RECLAMATION FACILITY
FYPANSION PROJECT - PHASE II

MEMBRANE FILTRATION FACILITY DETAIL

ELECTRICAL

AS NOTED DRAWING NUMBER EM500 SHEET NUMBER 144 OF 236

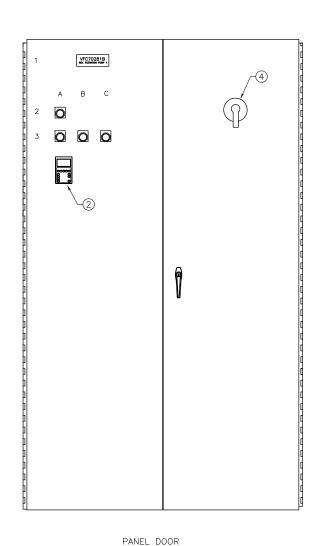

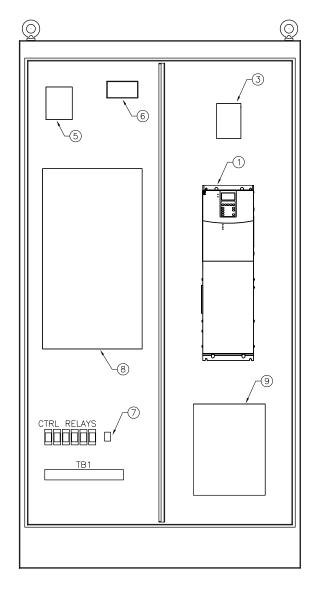

PANEL FRONT VIEW (WITH DOOR REMOVED)

<u>NOTES</u>

- 1. GENERAL ALL WIRING TO THE PANEL ENTER FROM THE TOP.
- 2. NAMEPLATE: UNLESS OTHERWISE STATED, BLACK W/ WHITE LETTERS. LAMINATED PHENOLIC
- 3. NAMEPLATE TO BE ATTACHED W/ S.S. SCREWS.
- 4. PROVIDE 10 SPARE TERMINAL BLOCKS FOR TB1.
- 5. ENCLOSE ALL WIRING CROSSING DOOR HINGES WITH SPIRAL WRAP.
- 6. MOUNT FAN AND EXHAUST GRILL ON LEFT SIDE OF PANEL.

PANEL BILL OF MATERIALS

QTY	MFG	CATALOG	DESCRIPTION
1	HOFFMAN	A904820FSD	ENCLOSURE, NEMA 12, TWO DOOR, 90" (H), 48" (W), 20" (D)
1	HOFFMAN	A90P48F1	ENC. BACK PANEL, 78" (H), 44" (W)
) 1	ALLEN-BRADLEY	20BD077A3ANNANA0	POWERFLEX 700, 480V, 77A, 60HP VFD, FRAME SIZE 4, STANDARD 24V I/O
1	ALLEN-BRADLEY	20-HIM-C3S	DOOR MOUNT VFD DISPLAY WITH CABLE
1	CUTLER-HAMMER	HMCP100L3C	100A MOTOR CIRCUIT PROTECTOR, TYPE HMCP, 3 POLE
1	CUTLER-HAMMER	FHMVD16B	UNIVERSAL ROTARY HANDLE MECHANISM FOR F-FRAME CB
1	ACME ELECTRIC	TB-81215	CONTROL TRANSFORMER, 480-120VAC, 500VA
1	ACME ELECTRIC	PL-112704	PRIMARY FUSE BLOCK
1	ACME ELECTRIC	PL-79931	SECONDARY FUSE BLOCK
) 1	MARATHON	1323572	OUTPUT POWER TB
1	MARATHON	CH 1323	SNAP-ON HINGED COVER FOR OUTPUT POWER TB
1	HOFFMAN	TFP41	COOLING FAN / AIR FILTER / GRILLE
1	HOFFMAN	TEP4	EXHAUST GRILLE / AIR FILTER
) 1	HOFFMAN	A-TEMNO	THERMOSTAT
1	TCI	HG60AW00STC	INPUT HARMONIC FILTER W/ CONTACTOR, OPEN TYPE, 60HP
1	ALLEN-BRADLEY	1321-RWR80-DP	REFLECTIVE WAVE FILTER
1	ALLEN-BRADLEY	800T-PH16W	PILOT LIGHT, LED-TRANSFORMER TYPE, 120AC, WHITE
1	ALLEN-BRADLEY	800T-PTH16G	PILOT LIGHT, LED-TRANSFORMER TYPE, 120AC, PUSH-TO-TEST, GREEN
1	ALLEN-BRADLEY	800T-PTH16R	PILOT LIGHT, LED-TRANSFORMER TYPE, 120AC, PUSH-TO-TEST, RED
1	ALLEN-BRADLEY	800T-PTH16A	PILOT LIGHT, LED-TRANSFORMER TYPE, 120AC, PUSH-TO-TEST, AMBER
6	IDEC	RU4S-A110	CONTROL RELAY, FORM C, 4 POLE, 120VAC, INDICATOR LT
6	IDEC	SY4S-05	RELAY SOCKET
40	PHOENIX CONTACT	30 04 36 2	TERMINAL BLOCKS UK5N
	AS NEEDED		MISC. CTRL FUSES, PANDUIT, SPIRAL WRAP, NAMEPLATES, WIRE, DINRAIL


	NAMEPLATE SCHEDULE								
DRAWING TAG	QUANTITY	TYPE	SIZE	LETTER SIZE	INSCRIPTION	ALLEN-BRADLE P/N			
1	1	PLATE	2.0" X 5.5"	1/2"	SEE TABLE BELOW				
2A	1	RING	30.5 mm	1/8	POWER ON	800H-W100E			
3A	1	RING	30.5 mm	1/8	READY	800H-W100E			
3B	1	RING	30.5 mm	1/8	RUN	800H-W100E			
3C	1	RING	30.5 mm	1/8	FAULT	800H-W100E			

TAG	1	1ST	LINE
TAG	1	2ND	LINE

PANEL NO.1	PANEL NO.2					
VFC70281B	VFC70282B					
REV. FILTRATION PUMP 1	REV. FILTRATION PUMP 2					

PRELIMINARY - NOT FOR CONSTRUCTION



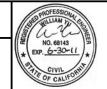



			REVISIONS				LINE IS 2 INCHES
PROFESSION .	ZONE	REV.	DESCRIPTION	BY	DATE	APP.	AT FULL SIZE
TAY SIVALORE (E)							(IF NOT 2"-SCALE ACCORDINGLY
Bootet # 1814							FILE NAME
Exp. 6 -30-10 3							1100
*//							DRAWN S. SIVAPRASAI
ECTRICA							DESIGNED SS
OF CALIFO							CHECKED SS
							011201120

TBD CONTRACT NUMBER

SACRAMENTO REGIONAL COUNTY SANITATION DISTRICT OF SACRAMENTO COUNTY, CALIFORNIA


SACRAMENTO REGIONAL WASTEWATER TREATMENT PLANT WATER RECLAMATION FACILITY


PANEL LAYOUT AND MATERIAL LIST


REVERSE FILTRATION PUMP VFD PANEL VFC70281B/VFC70282B


SHEET 1 OF 1


SCALE NO SCALE DRAWING NUMBER EM700 SHEET NUMBER 145 OF 236

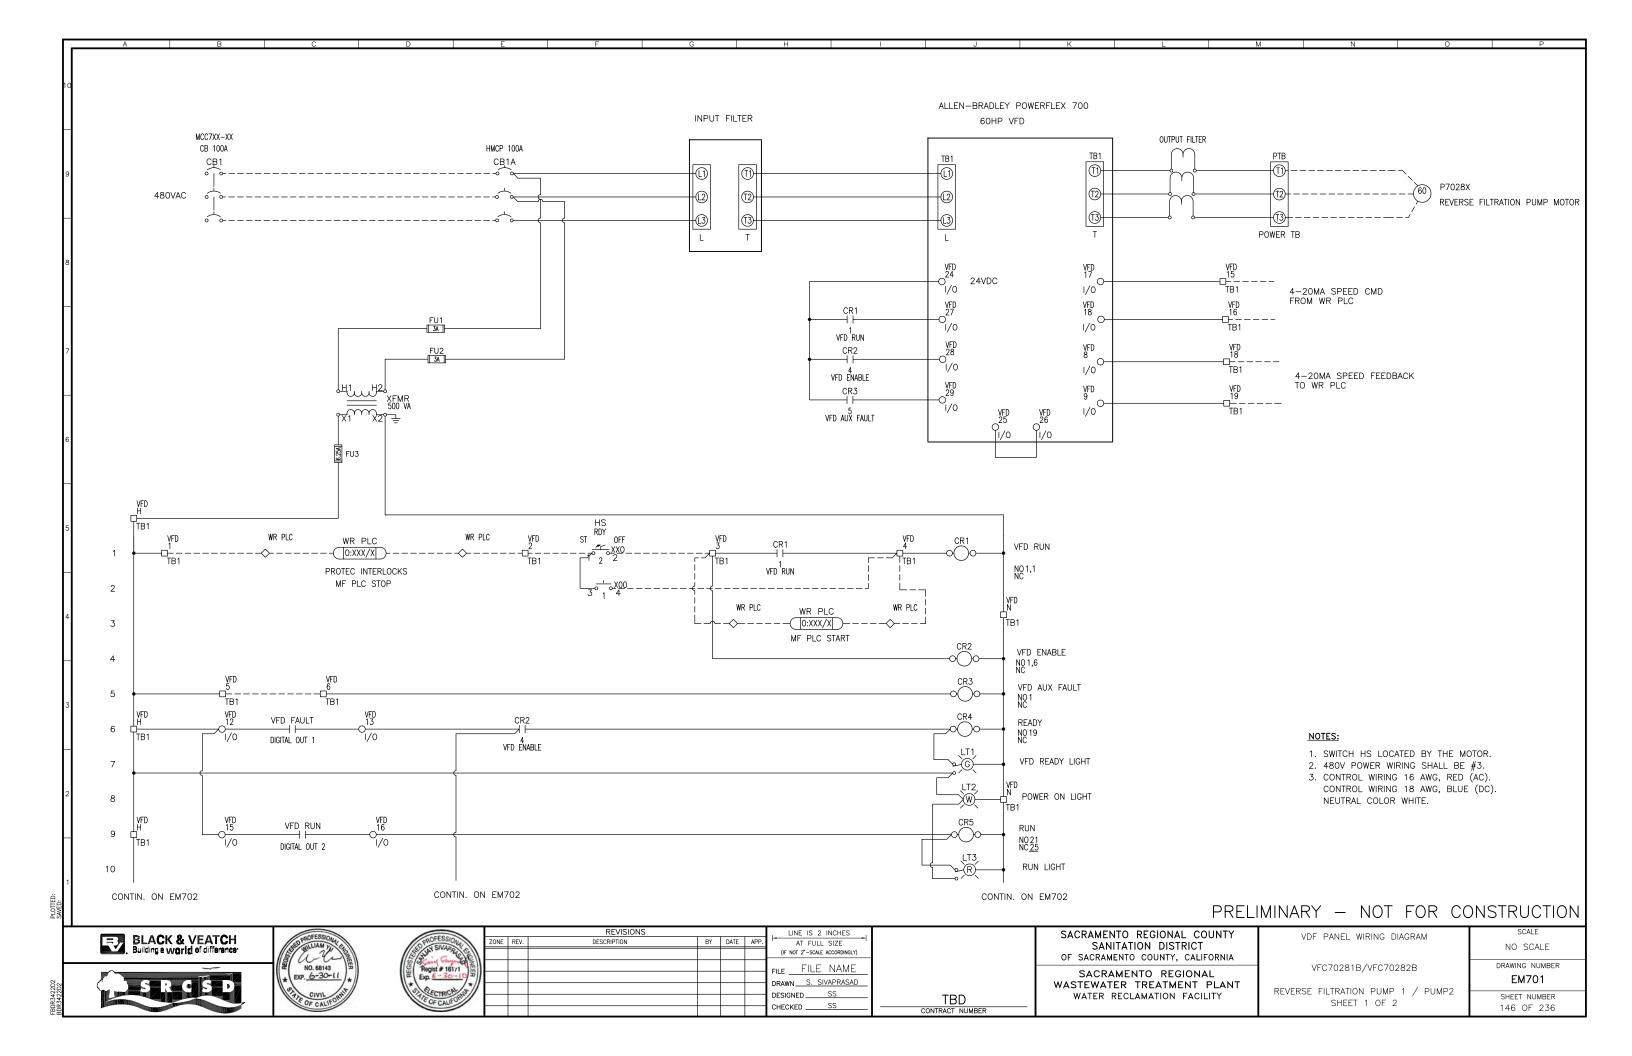


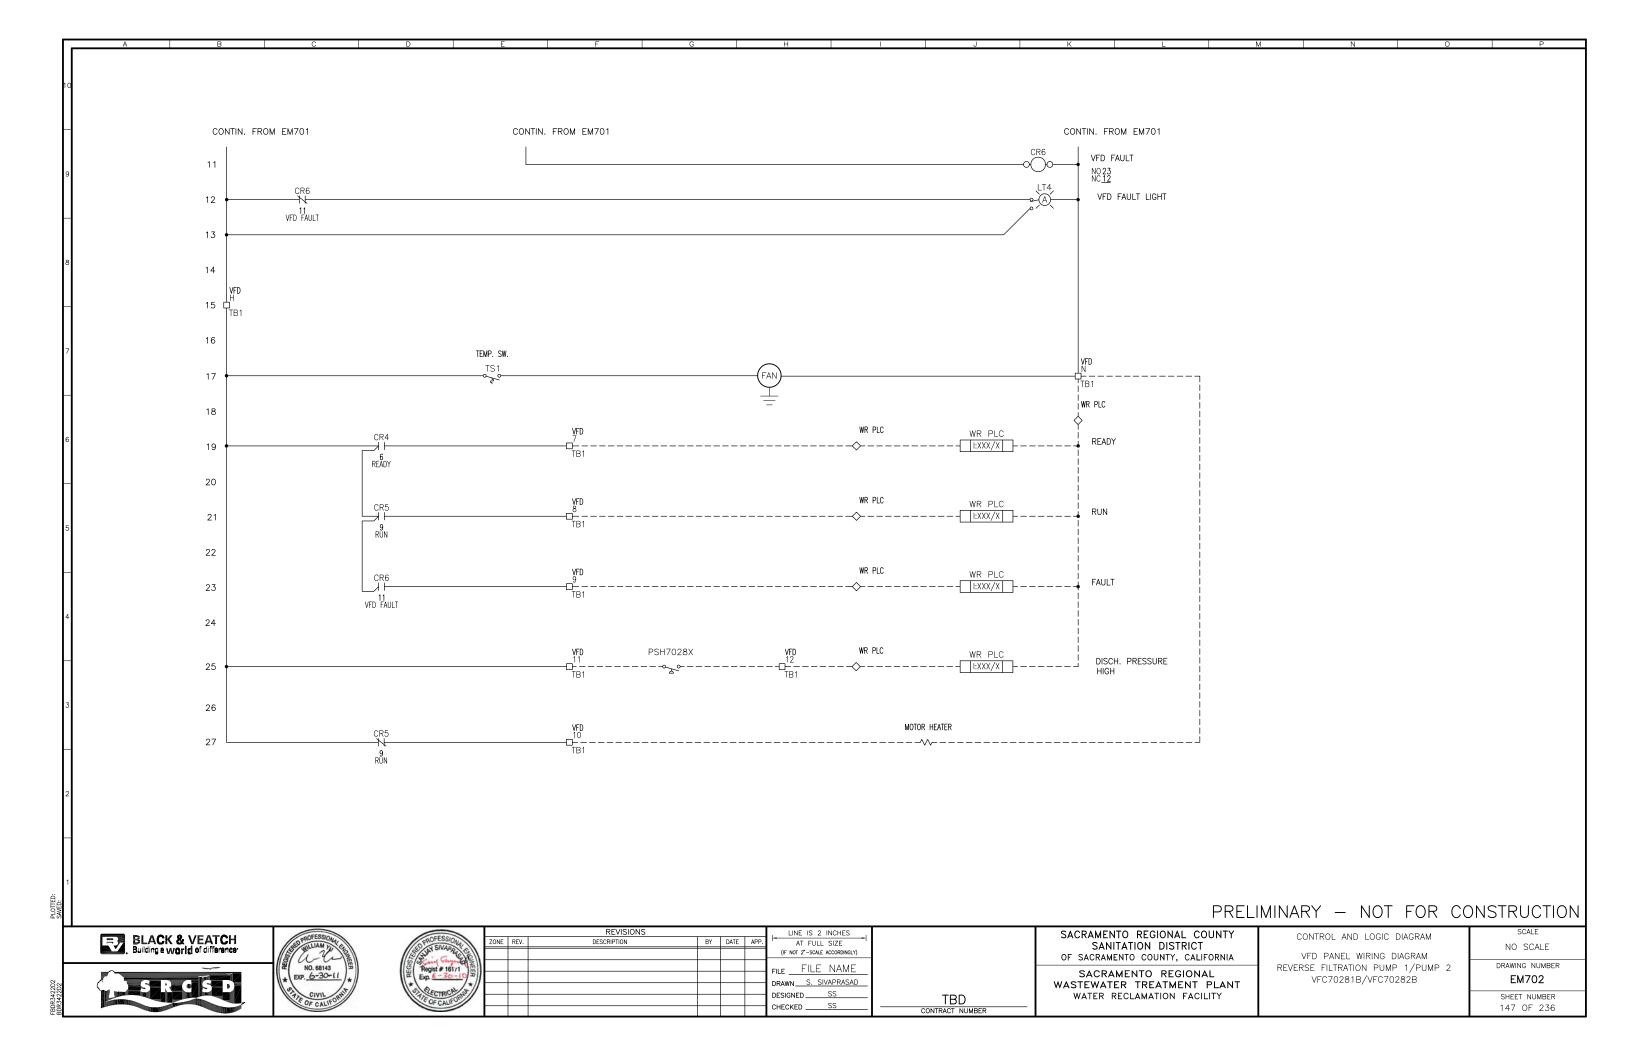

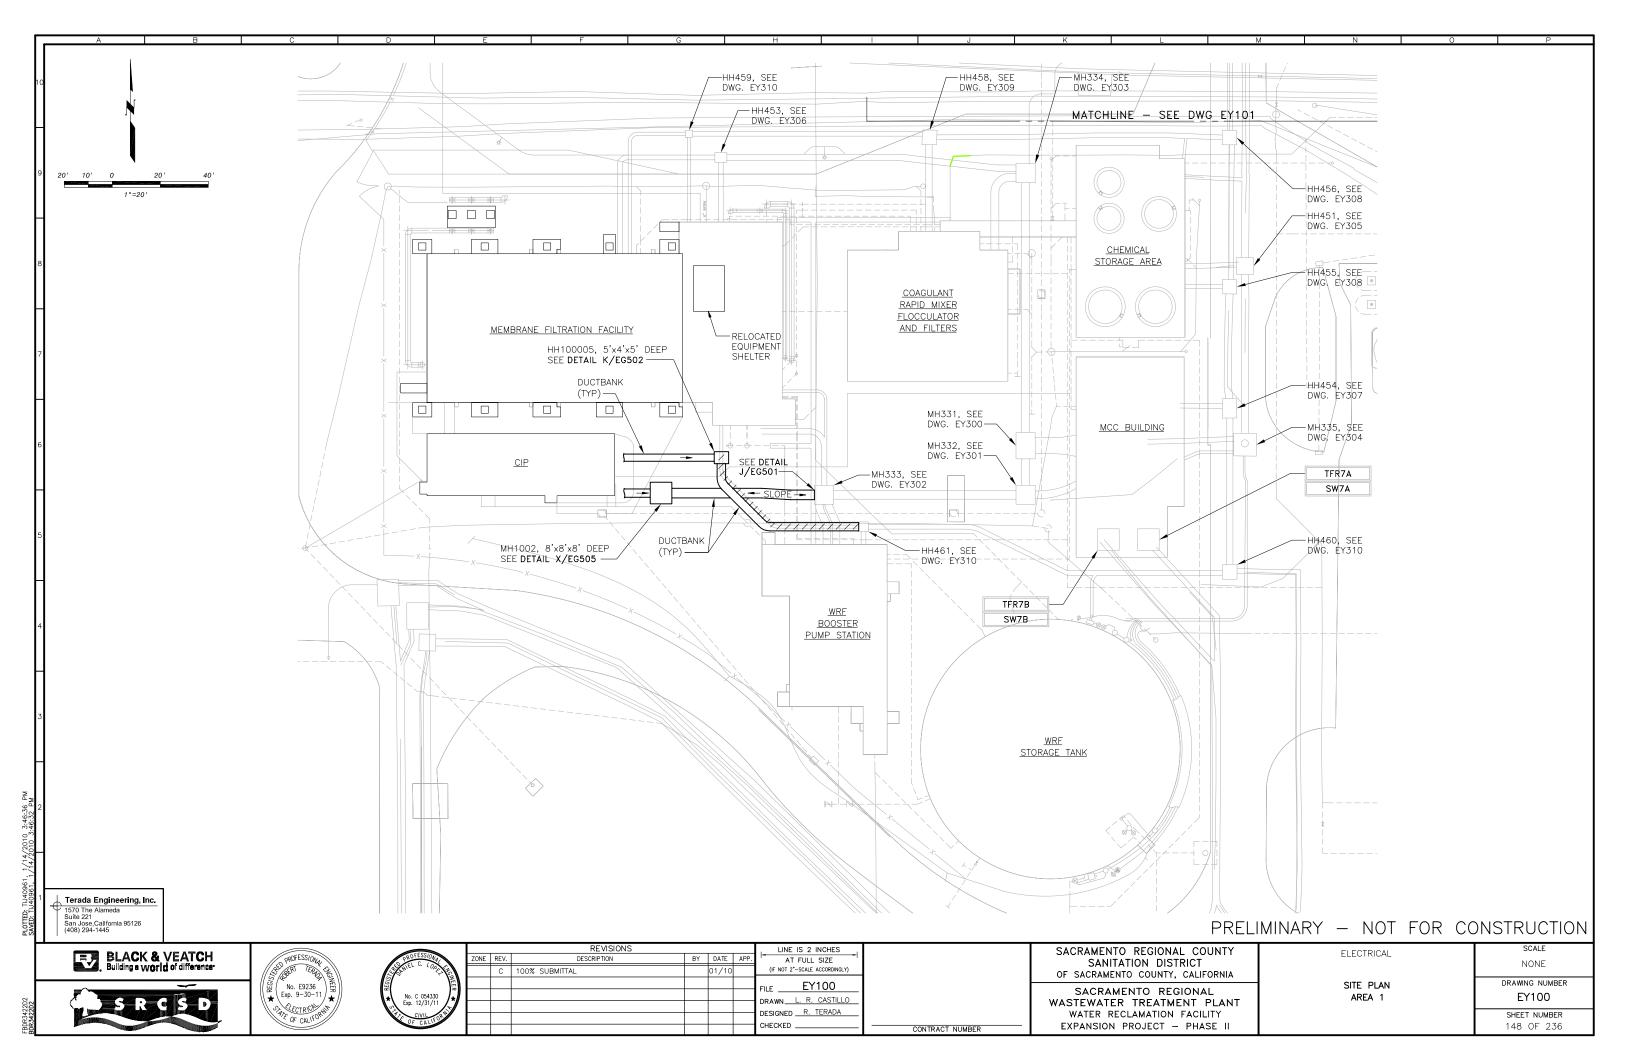


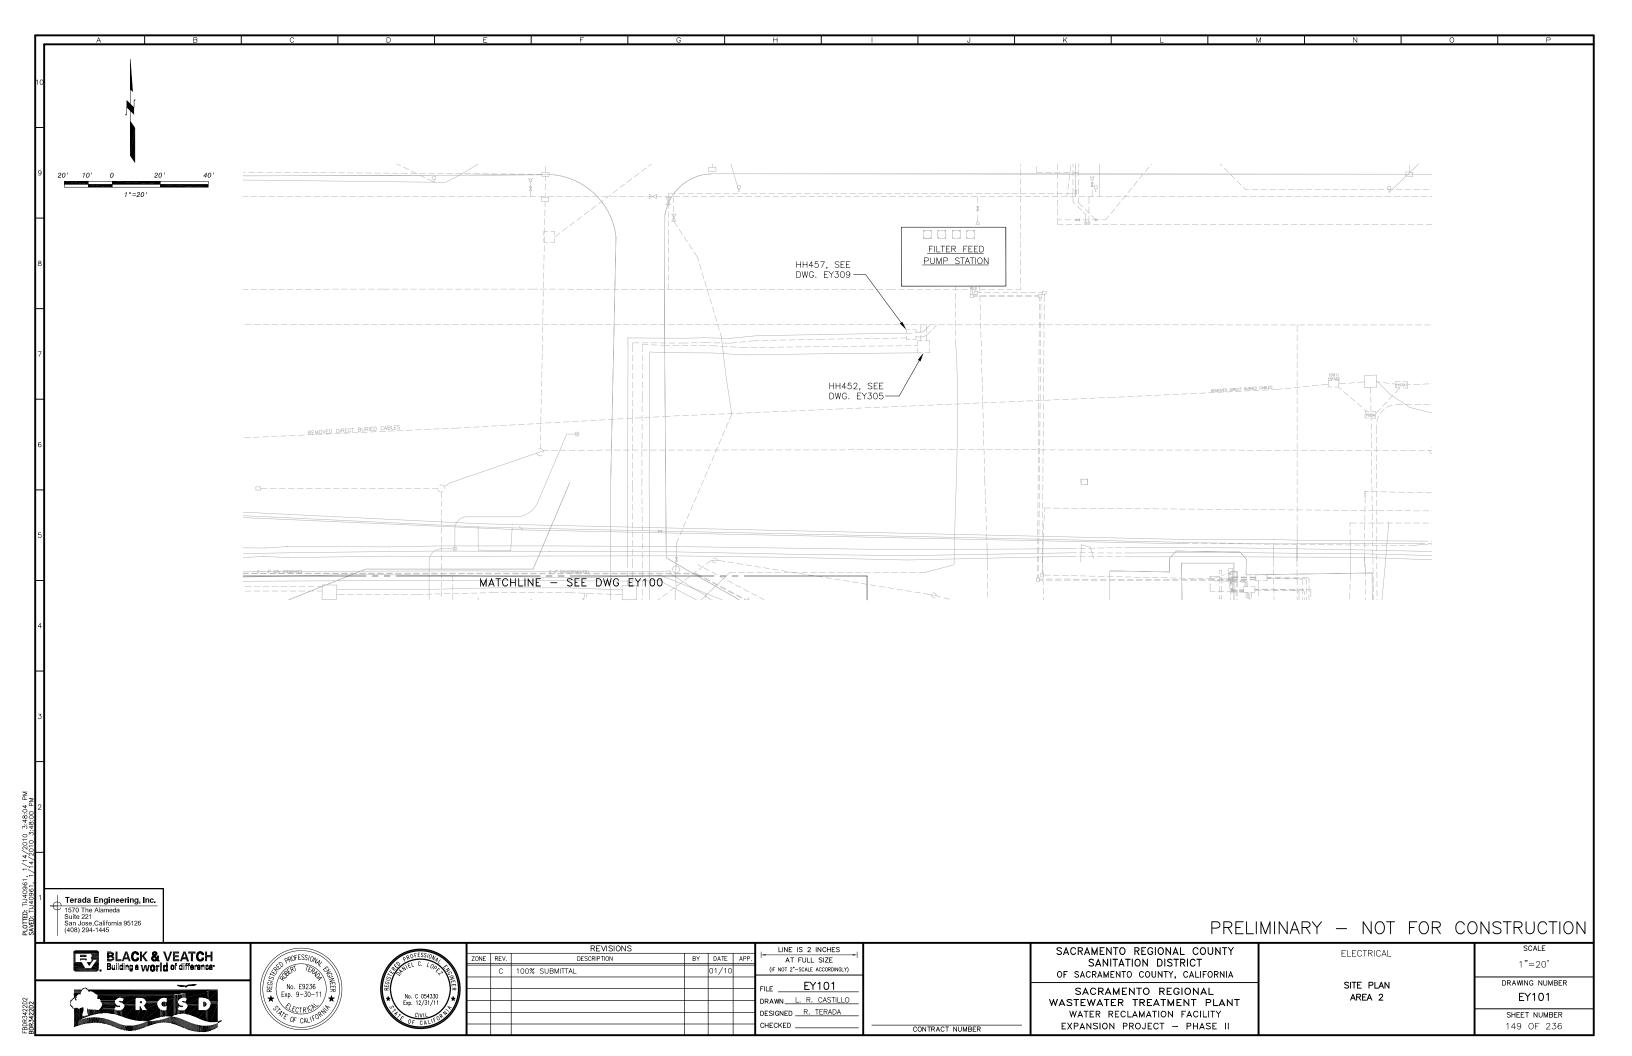

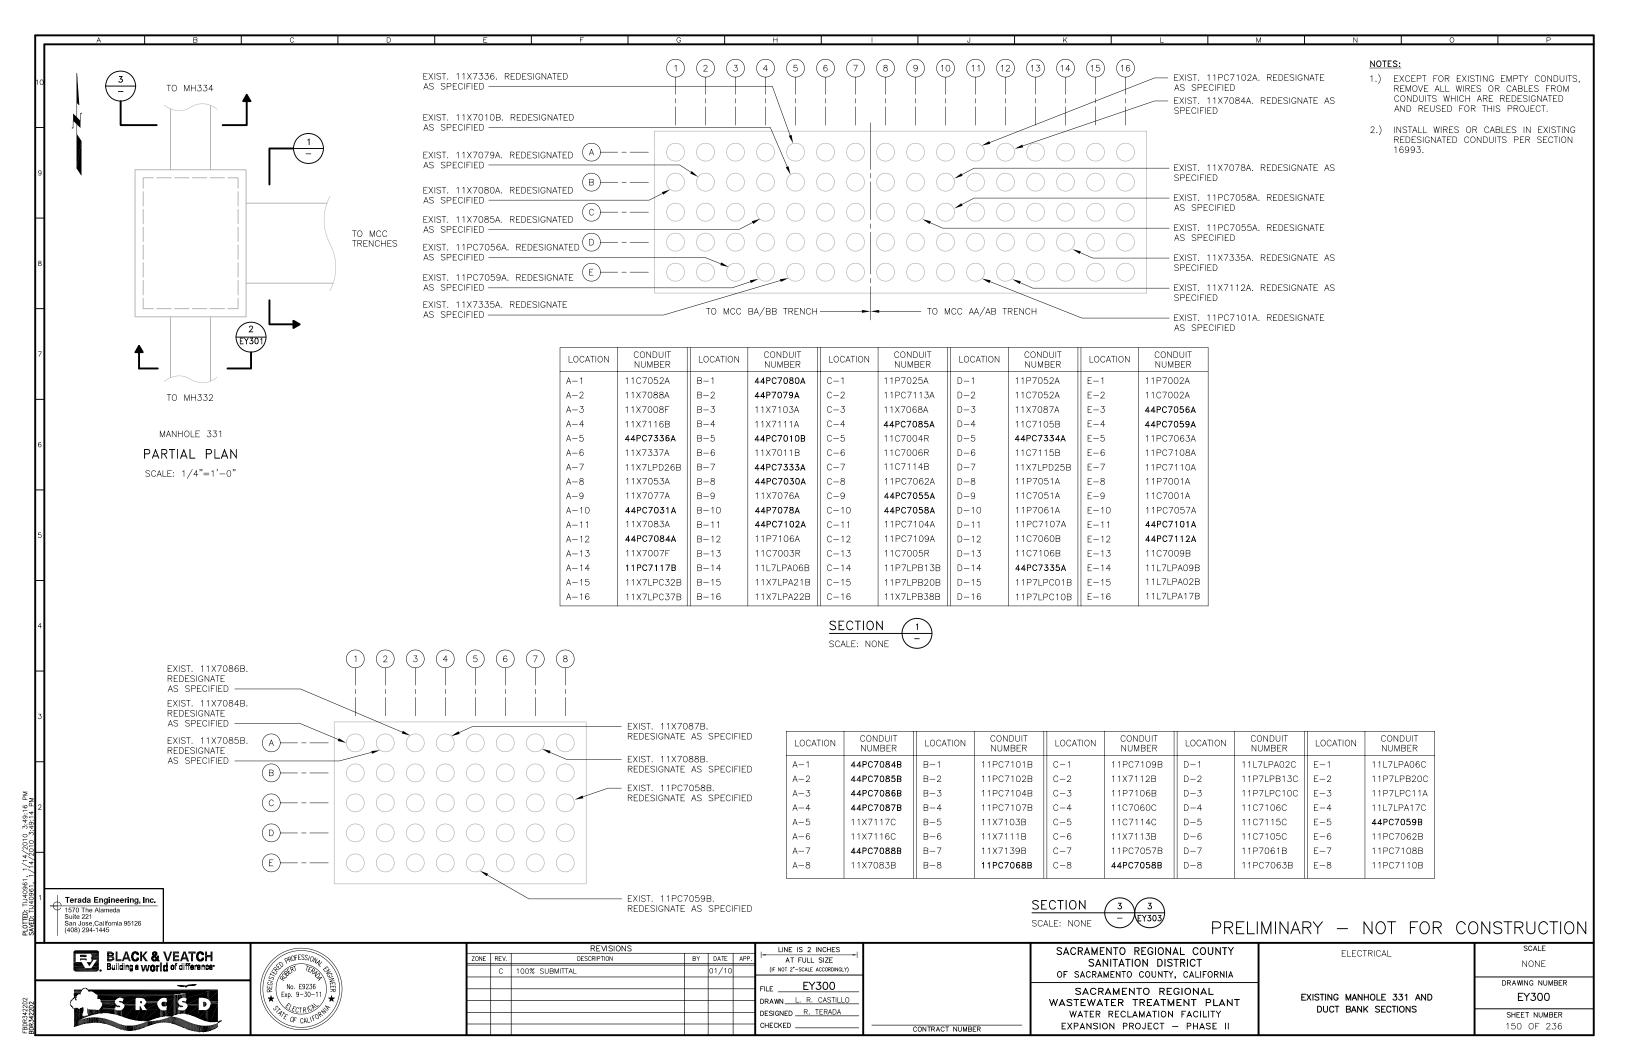

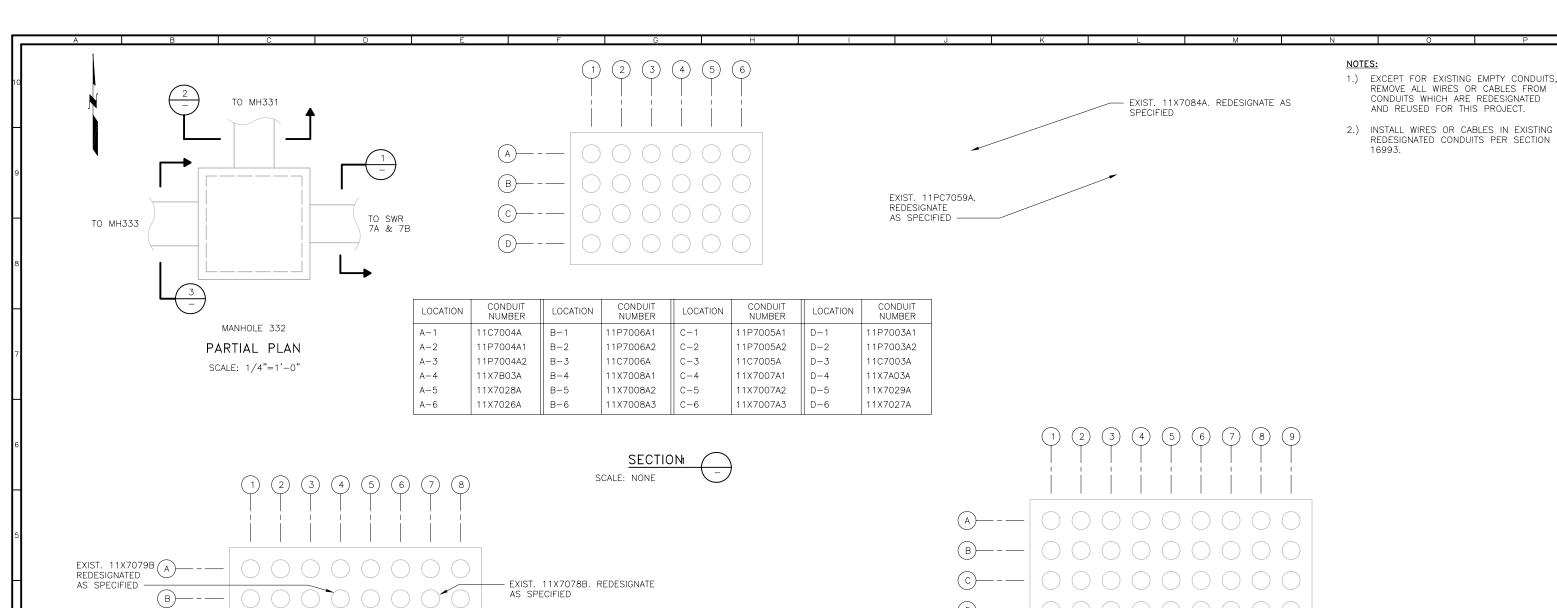

LOCATION	CONDUIT NUMBER										
A-1	11X7333C	B-1	11X7A03B	C-1	11C7009D	D-1	11X7010D	E-1	11X7011D	F-1	11C7054B
A-2	11X7LPB38D	B-2	11X7334C	C-2	44P7079C	D-2	11X7080C	E-2	11P7LPC01D	F-2	11C7052C
A-3	11X7LPA21D	B-3	44P7078C	C-3	11P7002C	D-3	11C7002C	E-3	11P7025C	F-3	11P7052C
A-4	11X7053C	B-4	11X7B03B	C-4	44PC7055C	D-4	11X7077C	E-4	44PC7056C	F-4	11P7LPB28B
A-5	11X7027B	B-5	11X7076C	C-5	11P7001C	D-5	11C7001C	E-5	11P7051C	F-5	11C7051C
A-6	11X7028B	B-6	11X7029B	C-6	11X7030C	D-6	11X7031C	E-6	11X7026B	F-6	11L7LPA09D
A-7	11X7007B3	B-7	11X7008B3	C-7	11C7003B	D-7	11C7004B	E-7	11C7005B	F-7	11C7006B
A-8	11X7007B1	B-8	11X7008B1	C-8	11P7003B1	D-8	11P7004B1	E-8	11P7005B1	F-8	11P7006B1
A-9	11X7007B2	B-9	11X7008B2	C-9	11P7003B2	D-9	11P7004B2	E-9	11P7005B2	F-9	11P7006B2

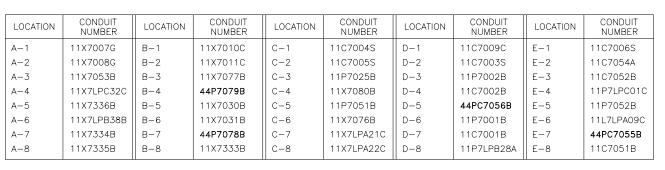

SECTION 2 2
SCALE: NONE - EY300

SECTION 3 2
SCALE: NONE - EY30

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San Jose, California 95126 (408) 294-1445



	REVISIONS	, LINE IS 2 INCHES ,				
REV.	DESCRIPTION	BY	DATE	APP.	AT FULL SIZE	
С	100% SUBMITTAL		01/10		(IF NOT 2"-SCALE ACCORDINGLY)	
					FILE EY301	
					520101120	
					CHECKED	-

EXIST. 11PC7056B. REDESIGNATE

EXIST. 11PC7055B. REDESIGNATE

AS SPECIFIED

AS SPECIFIED

SANITATION DISTRICT
OF SACRAMENTO COUNTY, CALIFORNIA
SACRAMENTO REGIONAL


SACRAMENTO REGIONAL COUNTY

SACRAMENTO REGIONAL
WASTEWATER TREATMENT PLANT
WATER RECLAMATION FACILITY
EXPANSION PROJECT — PHASE II

EXISTING MANHOLE 332 AND DUCT BANK SECTIONS

ELECTRICAL

SCALE			
NONE			
DRAWING NUMBER			
EY301			
EY301			
EY301 SHEET NUMBER			

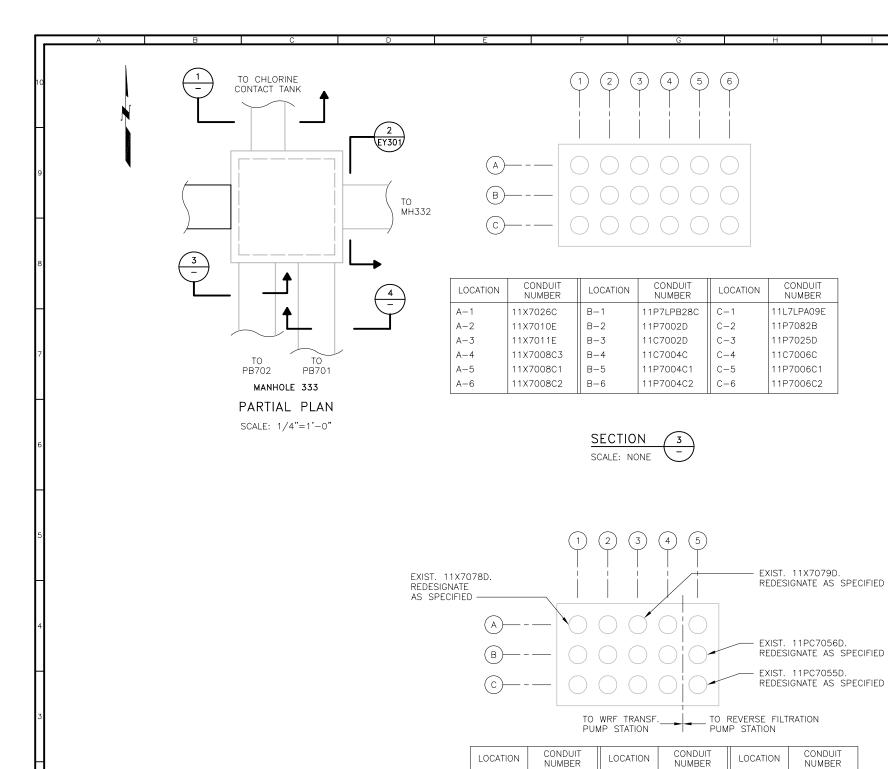

A-1

A-2

A-3

A-4

A - 5

44P7078D

11X7077D

44P7079D

11X7053D

11X7080D

B-1

B-2

B-3

B-4

B-5

SECTION

SCALE: NONE

11P7LPC19A

11P7082C

11C7054C

11X7076D

44PC7056D

C-1

C-2

C-3

C-4

C-5

DATE AP


11P7051D

11C7051D

11P7052D

11C7052D

44PC7055D

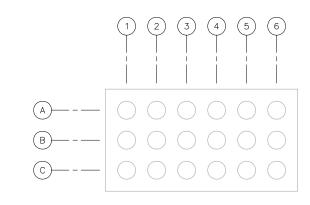

LOCATION	CONDUIT NUMBER	LOCATION	CONDUIT NUMBER	LOCATION	CONDUIT NUMBER
A-1	11X7007C1	B-1	11P7003C1	C-1	11P7005C1
A-2	11X7007C2	B-2	11P7003C2	C-2	11P7005C2
A-3	11X7007C3	B-3	11C7003C	C-3	11C7005C
A-4	11X7029C	B-4	11P7LPC01E	C-4	11C7009E
A-5	11X7031D	B-5	11X7030D	C-5	11P7001D
A-6	11X7027C	B-6	11X7028C	C-6	11C7001D

SECTION SCALE: NONE

PRELIMINARY - NOT FOR CONSTRUCTION

NOTES:

1.) EXCEPT FOR EXISTING EMPTY CONDUITS, REMOVE ALL WIRES OR CABLES FROM CONDUITS WHICH ARE REDESIGNATED AND REUSED FOR THIS PROJECT.

2.) INSTALL WIRES OR CABLES IN EXISTING REDESIGNATED CONDUITS PER SECTION 16993.

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Suite 221 San Jose, Callfornia 95126 (408) 294-1445



REVISIONS						
ΝE	IE REV. DESCRIPTION		BY			
	С	100% SUBMITTAL				


LINE IS 2 INCHES AT FULL SIZE
(IF NOT 2"-SCALE ACCORDINGLY) EY302 DRAWN L. R. CASTILLO DESIGNED R. TERADA CHECKED _ CONTRACT NUMBER SACRAMENTO REGIONAL COUNTY SANITATION DISTRICT OF SACRAMENTO COUNTY, CALIFORNIA

SACRAMENTO REGIONAL WATER RECLAMATION FACILITY EXPANSION PROJECT - PHASE II


ELECTRICAL

SCALE NONE DRAWING NUMBER EY302 SHEET NUMBER 152 OF 236

EXISTING MANHOLE 333 AND WASTEWATER TREATMENT PLANT DUCT BANK SECTIONS

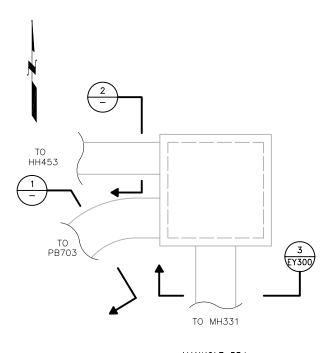

MANHOLE 334 PARTIAL PLAN SCALE: 1/4"=1'-0"

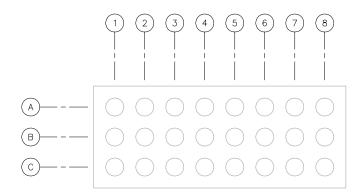

LOCATION	CONDUIT NUMBER	LOCATION	CONDUIT NUMBER	LOCATION	CONDUIT NUMBER	
A-1	11PC7110C	B-1	11P7061C	C-1	11L7LPA06D	
A-2	11PC7109C	B-2	11PC7108C	C-2	11P7LPB13D	
A-3	11X7139A	B-3	11X7113C	C-3	11P7LPC10D	
A-4	11X7140A	B-4	11X7112C	C-4	11PC7107C	
A-5	11PC7102C	B-5	11PC7104C	C-5	CONDUIT PLUGGE	D
A-6	11X7103C	B-6	11P7106C	C-6	11PC7101C	
A-7	11X7117D	B-7	11C7106D	C-7	11C7115D	
A-8	11X7116D	B-8	11C7105D	C-8	11C7114D	

SECTION SCALE: NONE

EXIST. 11X7084C. REDESIGNATE AS SPECIFIED ————	1 2 3 4 5 6
(A)———	000000
EXIST. 11PC7058C. B	0,00000
C	00/0000
EXIST. 11PC7059C. REDESIGNATE AS SPECIFIED —————	

LOCATION	CONDUIT NUMBER	LOCATION	CONDUIT NUMBER	LOCATION	CONDUIT NUMBER
A-1	11X7083C	B-1	11PC7057C	C-1	11L7LPA02D
A-2	11PC7068C	B-2	44PC7058C	C-2	11P7LPB20D
A-3	44PC7084C	B-3	44PC7059C	C-3	11P7LPC11B
A-4	11X7085C	B-4	11PC7062C	C-4	11C7060D
A-5	11X7086C	B-5	11PC7063C	C-5	11P7061D
A-6	11X7087C	B-6	11X7088C	C-6	11L7LPA17F*

*11L7LPA17G AT HH453

CONTRACT NUMBER

SECTION SCALE: NONE

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E9236	() [[] [] [] [] [] [] [] [] []
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CALIFO	//

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	С	100% SUBMITTAL		01/10		(IF NOT 2"-SCALE ACCORDINGLY)
						FILE EY303
						DRAWN L. R. CASTILLO
						DESIGNED R. TERADA
						CHECKED

SACRAMENTO REGIONAL COUNTY SANITATION DISTRICT OF SACRAMENTO COUNTY, CALIFORNIA

SACRAMENTO REGIONAL WASTEWATER TREATMENT PLANT WATER RECLAMATION FACILITY EXPANSION PROJECT - PHASE II

NOTES:


 EXCEPT FOR EXISTING EMPTY CONDUITS, REMOVE ALL WIRES OR CABLES FROM CONDUITS WHICH ARE REDESIGNATED AND REUSED FOR THIS PROJECT.

2.) INSTALL WIRES OR CABLES IN EXISTING REDESIGNATED CONDUITS PER SECTION 16993.

NONE

PRELIMINARY - NOT FOR CONSTRUCTION SCALE ELECTRICAL


> DRAWING NUMBER EXISTING MANHOLE 334 AND EY303 DUCT BANK SECTIONS SHEET NUMBER 153 OF 236

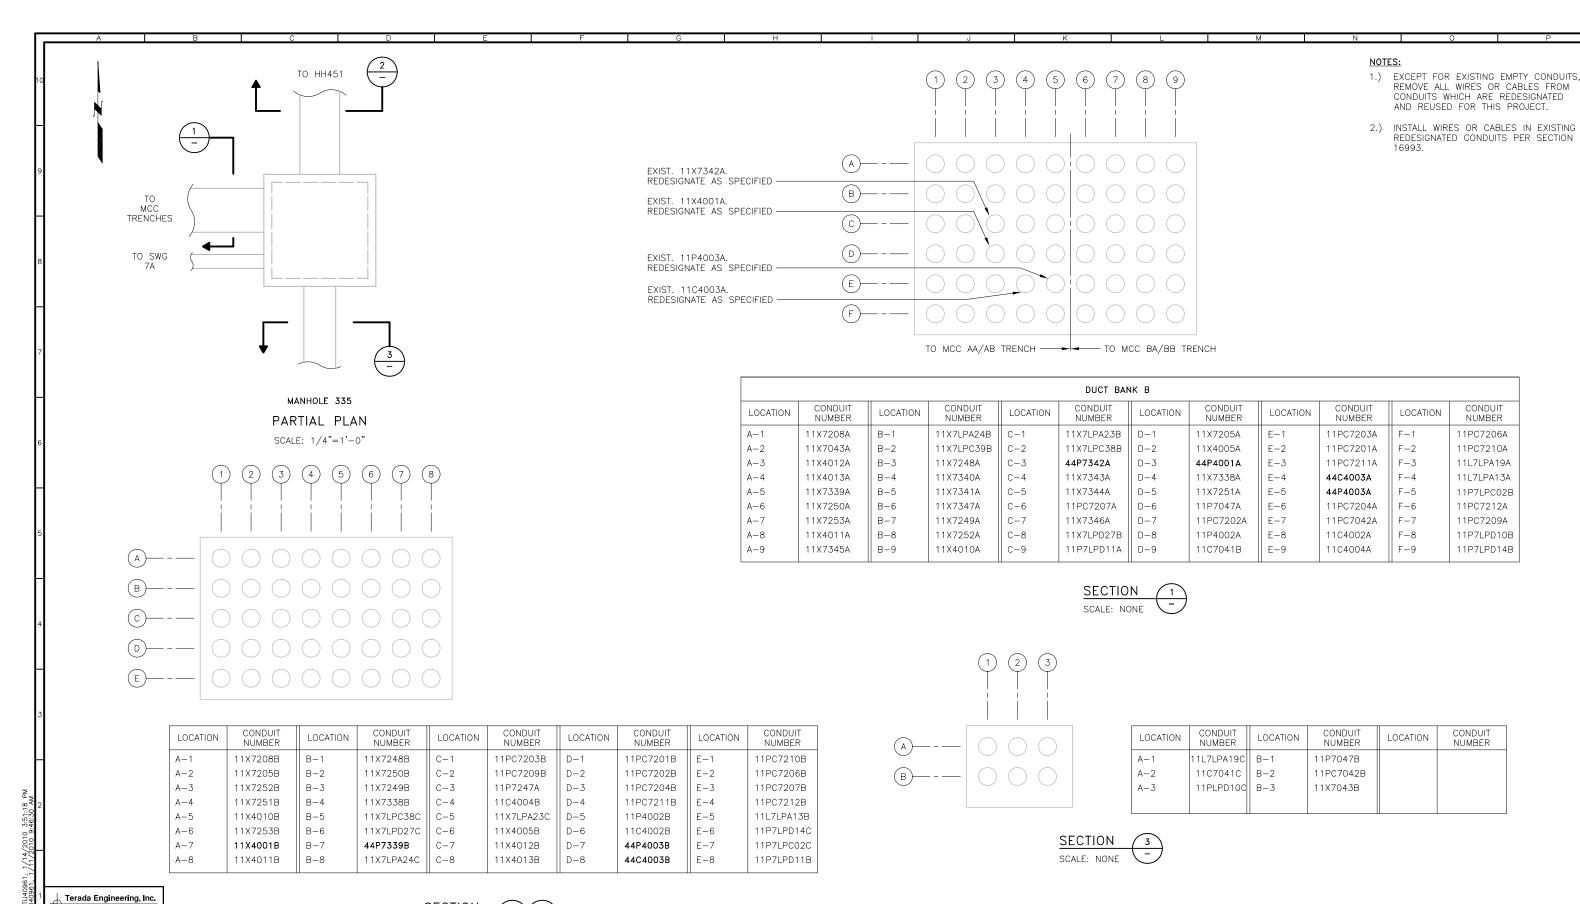

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SACRAMENTO REGIONAL COUNTY
SANITATION DISTRICT
OF SACRAMENTO COUNTY, CALIFORNIA
SACRAMENTO REGIONAL

CONTRACT NUMBER


SACRAMENTO REGIONAL
WASTEWATER TREATMENT PLANT
WATER RECLAMATION FACILITY
EXPANSION PROJECT — PHASE II

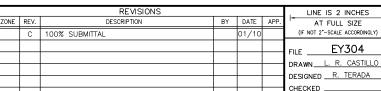
EXISTING MANHOLE 335 AND DUCT BANK SECTIONS


ELECTRICAL

PRELIMINARY - NOT FOR CONSTRUCTION

SCALE
NONE
DRAWING NUMBER
EY304
SHEET NUMBER
154 OF 236

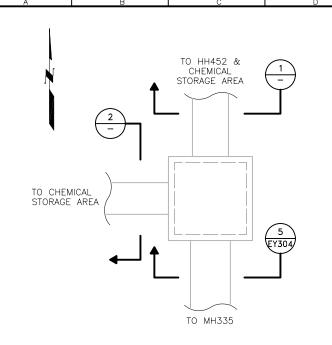


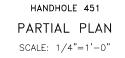

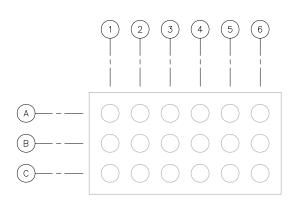


LOCATION	CONDUIT NUMBER	LOCATION	CONDUIT NUMBER	LOCATION	CONDUIT NUMBER
A-1	11L7LPA13C	B-1	11P7247B	C-1	11PC7203C
A-2	11P7LPC02D	B-2	11PC7201C	C-2	11PC7204C
A-3	11X7251C	B-3	11PC7202C	C-3	11PC7205C
A-4	11X7252C	B-4	11X7208C	C-4	11PC7210C
A-5	11X7253C	B-5	11PC7207C	C-5	11PC7209C
A-6	11XP7LD14D	B-6	11PC7206C	C-6	11P7LPD11C



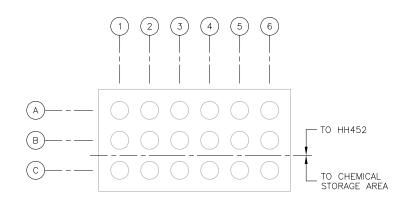


LOCATION	CONDUIT NUMBER	LOCATION	CONDUIT NUMBER	LOCATION	CONDUIT NUMBER
A-1	11X4010C	B-1	11P4002C	C-1	11PC7212C
A-2	11X4011C	B-2	11C4002C	C-2	11X7249C
A-3	11X4001C	B-3	11P4003C	C-3	11C7248C
A-4	11X4005C	B-4	11C4003C	C-4	11P7LPC04A
A-5	11X4012C	B-5	11C4004C	C-5	11PC7211C
A-6	11X4013C	B-6	11P7LPC09A	C-6	11P7LPD19A



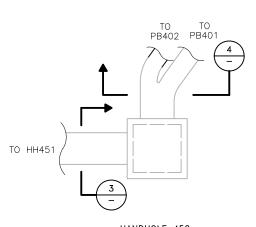

HANDHOLE 452
PARTIAL PLAN
SCALE: 1/4"=1'-0"

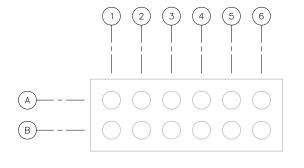

LOCATION	CONDUIT NUMBER	LOCATION	CONDUIT NUMBER
A-1	11X4010C	B-1	11P4002C
A-2	11X4011C	B-2	11C4002C
A-3	11X4001C	B-3	11P4003C
A-4	11X4005C	B-4	11C4003C
A-5	11X4012C	B-5	11C4004C
A-6	11X4013C	B-6	11P7LPC09A
	A-1 A-2 A-3 A-4 A-5	A-1 11X4010C A-2 11X4011C A-3 11X4001C A-4 11X4005C A-5 11X4012C	A-1 11X4010C B-1 A-2 11X4011C B-2 A-3 11X4001C B-3 A-4 11X4005C B-4 A-5 11X4012C B-5



	1	2	3	4	5	
(A)						
B						
DUCT BANK A			-		T BANK PB401	В

NOTES:

 EXCEPT FOR EXISTING EMPTY CONDUITS, REMOVE ALL WIRES OR CABLES FROM CONDUITS WHICH ARE REDESIGNATED

AND REUSED FOR THIS PROJECT.

2.) INSTALL WIRES OR CABLES IN EXISTING REDESIGNATED CONDUITS PER SECTION 16993.

DUCT BANK A						
LOCATION	CONDUIT NUMBER	LOCATION	CONDUIT NUMBER			
A-1 11X4010D		B-1	11X4011D			
A-2	11P4002D	B-2	11C4002D			
	DUCT E	BANK B				
A-3	11X4001D	B-3	11X4005D			
A-4	11P4003D	B-4	11C4003D			
A-5	11C4004D	B-5	11P7LPC09B			



PRELIMINARY - NOT FOR CONSTRUCTION

ELECTRICAL



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, LINE I	REVISIONS						
AT I	APP.	DATE	BY	EV. DESCRIPTION			
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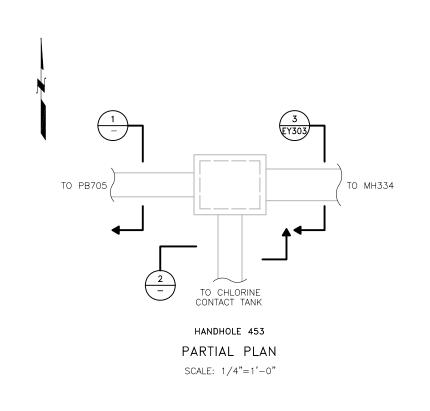
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	APP.	AT FULL SIZE	i
)		(IF NOT 2"-SCALE ACCORDINGLY)	
		FILE EY305	
		DRAWN_ L. R. CASTILLO	
_		DESIGNED R. TERADA	
		CHECKED	
		CHECKED	CONTRACT NUMBER


SACRAMENTO REGIONAL COUNTY
SANITATION DISTRICT
OF SACRAMENTO COUNTY, CALIFORNIA

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SACRAMENTO REGIONAL
WASTEWATER TREATMENT PLANT
WATER RECLAMATION FACILITY
EXPANSION PROJECT - PHASE II

EXISTING HANDHOLES 451 & 452 AND DUCT BANK SECTIONS

SCALE	
NONE	
DRAWING NUMBER	
EY305	
SHEET NUMBER	
1EE OF 076	



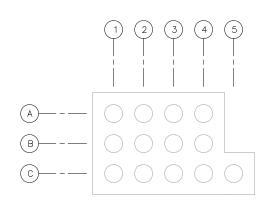


LOCATION	CONDUIT NUMBER	LOCATION	CONDUIT NUMBER	LOCATION	CONDUIT NUMBER
A-1	11X7085D	B-1	11X7086D	C-1	11PC7062D
A-2	11X7087D	B-2	11X7088D	C-2	11C7064A
A-3	11X7089A	B-3	11P7LPB20E	C-3	11L7LPA02E
A-4	11X7090A	B-4	11PC7063D	C-4	11P7LPC11C
		C-5	11L7LPA17H		

SECTION SCALE: NONE



- 1.) EXCEPT FOR EXISTING EMPTY CONDUITS, REMOVE ALL WIRES OR CABLES FROM CONDUITS WHICH ARE REDESIGNATED AND REUSED FOR THIS PROJECT.
- 2.) INSTALL WIRES OR CABLES IN EXISTING REDESIGNATED CONDUITS PER SECTION 16993.

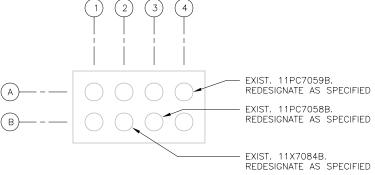

LOCATION	CONDUIT NUMBER	LOCATION	CONDUIT NUMBER
A-1	11P7060E	B-1	11C7061E
A-2	11X7083D	B-2	44PC7084D
A-3	11X7068D	B-3	44PC7058D
A-4	44PC7059D	B-4	11PC7057D

<u>SECTI</u>ON

PRELIMINARY - NOT FOR CONSTRUCTION





		TRE VISIONS				, LIII
ZONE	REV.	DESCRIPTION	BY	DATE	APP.	-
	С	100% SUBMITTAL		01/10		(IF NO
						FILE
						DRAWN.
						DESIGNI
						CHECKE

APP.	- LINE IS 2 INCHES - AT FULL SIZE (IF NOT 2"-SCALE ACCORDINGLY)	
	FILE EY306 DRAWN L. R. CASTILLO DESIGNED R. TERADA CHECKED	CONTRACT NUMBER


SACRAMENTO REGIONAL COUNTY SANITATION DISTRICT OF SACRAMENTO COUNTY, CALIFORNIA

SACRAMENTO REGIONAL WASTEWATER TREATMENT PLANT WATER RECLAMATION FACILITY EXPANSION PROJECT - PHASE II


ELECTRICAL

NONE DRAWING NUMBER EXISTING HANDHOLE 453 AND EY306 DUCT BANK SECTIONS SHEET NUMBER 156 OF 236

Terada Engineering, Inc. 1570 The Alameda Suite 221 San Jose,California 95126 (408) 294-1445

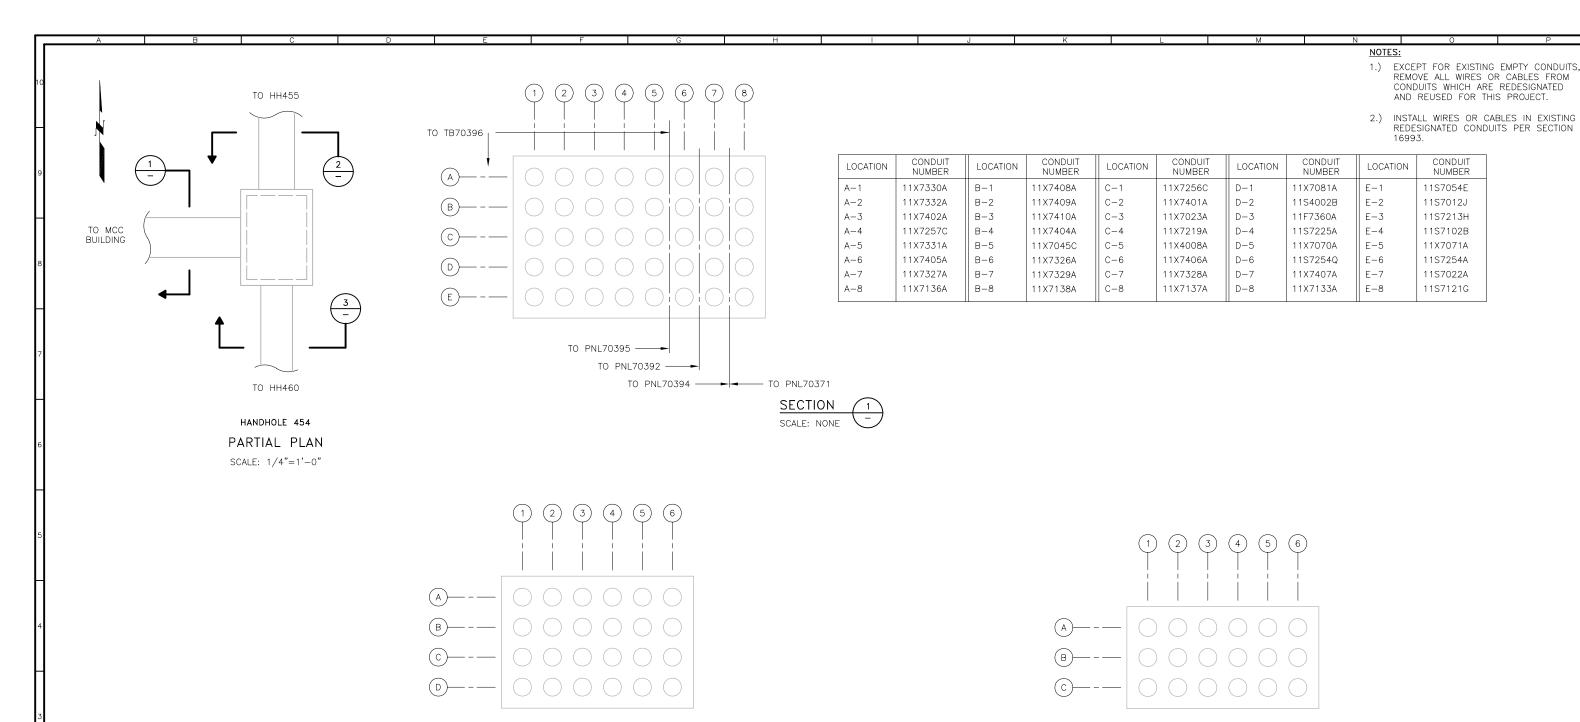

LOCATION	CONDUIT NUMBER	LOCATION	CONDUIT NUMBER	LOCATION	CONDUIT NUMBER	LOCATION	CONDUIT NUMBER
A-1	11X4014D	B-1	11S4002C	C-1	11X7258A	D-1	11X7259A
A-2	11X4009A	B-2	11X4008B	C-2	11X7091A	D-2	11S7121F
A-3	11S7060F	B-3	11X7070B	C-3	11X7092A	D-3	11S7213G
A-4	11S7069A	B-4	11X7071B	C-4	11X7102C	D-4	11X7133B
A-5	11X7219B	B-5	11X7256B	C-5	11X7257B	D-5	11X7245D
A-6	11S7225B	∥ _{B−6}	11S7254B	C-6	11S7254P	D-6	11X7246D

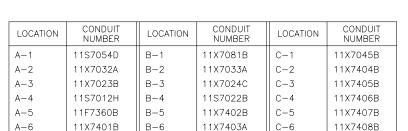

SECTION

PRELIMINARY - NOT FOR CONSTRUCTION

ELECTRICAL



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		REVISIONS				, LINE IS 2 INCHES			
NE	REV.	DESCRIPTION	BY	DATE	APP.	AT FULL SIZE			
	С	100% SUBMITTAL		01/10		(IF NOT 2"-SCALE ACCORDINGLY)			
						FILE EY307			
						DRAWNL. R. CASTILLO			
						DESIGNED R. TERADA			
						CHECKED			

SACRAMENTO REGIONAL COUNTY SANITATION DISTRICT OF SACRAMENTO COUNTY, CALIFORNIA

SACRAMENTO REGIONAL WASTEWATER TREATMENT PLANT WATER RECLAMATION FACILITY EXPANSION PROJECT - PHASE II

EXISTING HANDHOLE 454 AND DUCT BANK SECTIONS

SCALE
NONE
DRAWING NUMBER
EY307
SHEET NUMBER
157 OF 236

REMOVE ALL WIRES OR CABLES FROM CONDUITS WHICH ARE REDESIGNATED

AND REUSED FOR THIS PROJECT.

CONDUIT

NUMBER

11S7054E

11S7012J

11S7213H

11S7102B

11X7071A

11S7254A

11S7022A

11S7121G